

City of Surrey PLANNING & DEVELOPMENT REPORT File: 7916-0304-00

Planning Report Date: November 7, 2016

PROPOSAL:

• Development Permit

to permit renovations to an existing drive-through restaurant (McDonald's) in City Centre.


LOCATION: 10240 - King George Boulevard

OWNER: Heleneco Holdings Ltd., 295237

c/o Jayberg Enterprises Ltd.

ZONING: CHI

OCP DESIGNATION: Central Business District

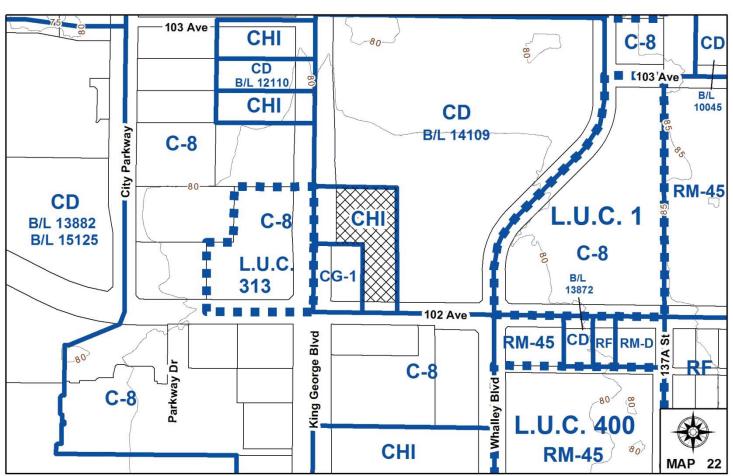

RECOMMENDATION SUMMARY

- Approval to vary the Sign By-law through a comprehensive sign design package.
- Approval to draft Development Permit.

DEVIATION FROM PLANS, POLICIES OR REGULATIONS

• The applicant is seeking to vary the Sign By-law to increase the maximum number of fascia signs from two (2) to seven (7), and to permit more than one (1) fascia sign to be located on the same façade, through a comprehensive design package.

RATIONALE OF RECOMMENDATION

- The proposed exterior renovations to the existing building represent a new modern design character while maintaining desirable elements of the existing building.
- The proposed renovations will improve the overall aesthetics of the site on an interim basis, as it is anticipated that the subject site and adjacent properties will redevelop in the future at a density more consistent with the ultimate vision for this area within City Centre.
- The applicant proposes five (5) additional fascia signs beyond the two (2) signs permitted under the Sign By-law for a total of seven (7) fascia signs, for the existing McDonald's restaurant. The proposed fascia signs are well under the maximum sign area permitted under the Sign By-law, and are of an appropriate size and scale in relation to the building.

RECOMMENDATION

The Planning & Development Department recommends that:

- 1. Council approve the applicant's request to vary the Sign By-law as described in Appendix II.
- 2. Council authorize staff to draft Development Permit No. 7916-0304-00 including a comprehensive sign design package generally in accordance with the attached drawings (Appendix III).
- 3. Council instruct staff to resolve the following issues prior to final approval:
 - (a) submission of a finalized landscaping plan, landscaping cost estimate and tree replacement plan to the specifications and satisfaction of the Planning and Development Department;
 - (b) the applicant satisfy the deficiency in tree replacement on the site, to the satisfaction of the Planning and Development Department; and
 - (c) resolution of all urban design issues to the satisfaction of the Planning and Development Department.

REFERRALS

Engineering: The Engineering Department has no objection to the project.

SITE CHARACTERISTICS

<u>Existing Land Use:</u> McDonald's drive-through restaurant.

Adjacent Area:

Direction	Existing Use	OCP Designation	Existing Zone
North:	Single-storey retail	Central Business	CD (By-law
	building (Save-On-	District	No. 14109)
	Foods and		
	Canadian Tire)		

Direction	Existing Use	OCP Designation	Existing Zone
East:	Retail parking lot	Central Business	CD (By-law
	and drive-through	District	No. 14109)
	restaurant (A&W)		
South:	Gas station	Central Business	CG-1
	(Chevron)	District	
South (Across 102 Avenue):	Restaurant and	Central Business	C-8
	single-storey retail	District	
	building (CIBC)		
West (Across King George	Single-storey	Central Business	L.U.C. 313
Boulevard):	multi-tenant retail	District	(underlying C-8)
	building.		

DEVELOPMENT CONSIDERATIONS

Background

- The subject site is located at 10240 King George Boulevard in City Centre and is approximately 4,181 square metres (1 acre) in size. The site is designated Central Business District in the Official Community Plan (OCP) and is zoned "Highway Commercial Industrial Zone (CHI)". The site is designated "Mixed Use 3.5 FAR" in the Stage 1 City Centre Plan Update.
- The site is currently occupied by a single-storey McDonald's drive-through restaurant. The design of the 359-square metre (3,864-sq. ft.) restaurant was approved under Development Permit No. 7997-0219-00 in January, 1998. At that time Development Variance Permit No. 7997-10219-00 was also approved to reduce the minimum north side yard setback from 7.5 metres (25 ft.) to 3 metres (10 ft.).
- As part of a rebranding strategy, McDonald's Restaurants Ltd. is in the process of updating the exterior and interior of a number of McDonald's restaurants in the Metro Vancouver area, including the City of Surrey. The intent is to update all McDonald's restaurants over the coming years to achieve consistent branding and to increase visibility of the restaurants with a similar modern form and character of the exterior façade and interior dining area.
- Since November 1, 2004, drive-throughs are not permitted in the CHI Zone for sites within City Centre. However, as the subject drive-through was already in existence at that time, its use may continue.

Current Proposal

- The applicant is proposing a Development Permit in order to allow exterior renovations and a small addition to the existing single-storey drive-through restaurant, including new fascia signage and landscaping.
- The applicant is also proposing to vary the Sign By-law through a Comprehensive Sign Design package in order to allow five (5) additional fascia signs, for a total of seven (7) fascia signs.

• The applicant is also proposing to renovate the interior of the restaurant, including a small, 9-square metre (98-sq. ft.) addition through a Tenant Improvement Building Permit.

- The proposed floor area of the building is 368 square metres (3,961 sq. ft.), resulting in a floor area ratio (FAR) of 0.09, which complies with the maximum FAR of 1.0 permitted in the CHI Zone.
- The Stage 1 Land Use and Density Concept of the City Centre Plan Update indicates that the subject site is appropriate for mixed-use developments with densities up to 3.5 FAR. The current building and land use is considered an interim use and it is anticipated that the subject site and adjacent properties will redevelop in the future at a density more consistent with the ultimate vision for this area of Surrey City Centre.
- The adjoining 10-acre site to the north and east is recently under application (No. 7916-0448-00) to rezone to permit 6 mixed-use high-rise buildings and to subdivide into 6 lots. This application is in the initial stages of review and has not been presented to Council.

DESIGN PROPOSAL AND REVIEW

Building Design

- The applicant is proposing exterior modifications and improvements to the existing building, which will provide a more contemporary look to the building.
- The proposed changes to the exterior of the building are intended to implement McDonald's new contemporary restaurant design while maintaining elements and materials of the existing building. The proposed design retains portions of the stucco and metal panel finishing, manufactured stone skirt and aluminum frame glazing. Many of the existing exterior elements and finishes will be retained and painted charcoal grey, red and chestnut brown to implement McDonald's new colour scheme.
- New vertical red metal panels with white metal ribbon will be installed onto the west and south elevations as a new key design element to identify the restaurant entrances and location of the new signage. Similarly, red and white metal paneling will be installed on the north elevation to identify the location of the two drive-through order pick-up windows.
- The existing canopy on the south façade will be removed.
- The majority of the existing vertical and horizontal metal trellis system on concrete columns to the west and south of the building will be removed, however portions within the landscaped area to the west of the building will be retained and updated with charcoal grey paint.
- The existing chain link garbage enclosure to the east of the building will be updated with a new concrete slab and will be clad with hardie panel to match the building.

Drive-Through and Parking

• The existing parking lot and dual lane drive-through configuration will remain unchanged.

• The site accommodates 56 parking stalls, which exceeds the 30 stalls required by the Zoning By-law.

Landscaping

- The existing trees on the subject site will remain, with the exception of five (5) trees within the interior parking lot area, which are in poor condition and will be removed.
- Two (2) deciduous shade trees are proposed to be planted at the drive-through entrance along the east property line.
- The applicant proposes to retain the existing shrub hedge along King George Boulevard and is proposing to enhance the area with shrubs, perennials and ornamental grasses.
- The existing landscape islands around the grille order stalls will be enhanced with updated shrubs and perrenials.
- The existing stamped concrete at the site entrances and the pavers at the entrances will be updated with new paint.

Proposed Signage

- The existing free-standing pylon signs located at the King George Boulevard and 102 Avenue site entrances will remain in place and the sign trellis' will be painted charcoal grey to match the building.
- The on-site directional and drive-through signage will remain unchanged.
- The applicant proposes to remove the five (5) existing fascia signs and install seven (7) new illuminated fascia signs on the building.
- Four (4) fascia signs are proposed on the south elevation, including a white "McDonald's" fascia sign consisting of illuminated individual channel letters, a yellow "Arches" fascia sign, as well as two (2) "sub-brand" fascia signs including a brown and white "McCafe" sign a blue "Open 24 Hours" sign.
- Three (3) fascia signs are proposed on the west elevation, including two (2) yellow "Arches" fascia signs and a blue "Open 24 Hours" fascia sign.
- The Sign By-law allows a maximum of two (2) fascia signs for each premises provided that both of the fascia signs are not located on the on the same façade of the premises.
- The applicant proposes a total of seven (7) fascia signs, and as a result, a relaxation is required to allow five (5) additional fascia signs and permit multiple signs of the same façade.
- The proposed signage design has been reviewed by staff and found to be acceptable. The
 location and scale of the proposed signage is modest and complementary to the building
 design.

• Staff support the proposed variances as part of a comprehensive sign design package.

INFORMATION ATTACHED TO THIS REPORT

The following information is attached to this Report:

Appendix I. Lot Owners, Action Summary and Project Data Sheets

Appendix II. Proposed Sign By-law Variances Table

Appendix III. Site Plan, Building Elevations and Landscape Plans

Original signed by Judith Robertson

Jean Lamontagne General Manager

Planning and Development

LM/da

Information for City Clerk

Legal Description and Owners of all lots that form part of the application:

1. (a) Agent: Name: Andrea Scott

Lovick Scott Architects Ltd.

Address: 3707 - First Avenue

Burnaby, BC V₅C₃V₆

2. Properties involved in the Application

(a) Civic Address: 10240 - King George Boulevard

(b) Civic Address: 10240 - King George Boulevard

Owner: Heleneco Holdings Ltd., 295237

c/o Jayberg Enterprises Ltd.

PID: 001-659-502

Lot 57 Section 26 Block 5 North Range 2 West New Westminster District Plan 32067

DEVELOPMENT DATA SHEET

Existing Zoning: CHI

Required Development Data	Minimum Required / Maximum Allowed	Proposed	
LOT AREA* (in square metres)			
Gross Total			
Road Widening area			
Undevelopable area			
Net Total		1 acre	
LOT COVERAGE (in % of net lot area)			
Buildings & Structures	50%	9%	
Paved & Hard Surfaced Areas		81%	
Total Site Coverage		90%	
SETBACKS (in metres)			
Front (West)	7.5 metres	10.3 metres	
Rear (East)	7.5 metres	14 metres	
Side #1 (North)	7.5 metres or o.o metres	4.5 metres*	
Side #2 (South)	7.5 metres or o.o metres	33 metres	
BUILDING HEIGHT (in metres/storeys) Principal	9.o metres	7.7 metres	
Accessory	9.0 metres	N/A	
NUMBER OF RESIDENTIAL UNITS		N/A	
Bachelor			
One Bed			
Two Bedroom			
Three Bedroom +			
Total			
FLOOR AREA: Residential		N/A	
FLOOR AREA: Commercial			
Retail		368 sq.m.	
Office			
Total		368 sq.m.	
FLOOR AREA: Industrial		N/A	
FLOOR AREA: Institutional		N/A	
TOTAL BUILDING FLOOR AREA	4,181 sq.m.	368 sq.m.	

^{*} Variance approved under Development Variance Permit No. 7997-0219-00

Development Data Sheet cont'd

Required Development Data	Minimum Required / Maximum Allowed	Proposed
DENSITY		
# of units/ha /# units/acre (gross)		
# of units/ha /# units/acre (net)		
FAR (gross)		
FAR (net)	1.0	0.09
AMENITY SPACE (area in square metres)		
Indoor		
Outdoor		
PARKING (number of stalls)		
Commercial		56
Industrial		-
Residential Bachelor + 1 Bedroom		
2-Bed		
3-Bed		
Residential Visitors		
Institutional		
Total Number of Parking Spaces	30	56
Number of disabled stalls		2
Number of small cars		0
Tandem Parking Spaces: Number / % of Total Number of Units		N/A
Size of Tandem Parking Spaces width/length		N/A

Heritage Site NC	O Tree Survey/Assessment Provided	NO
------------------	-----------------------------------	----

#	Proposed Variances	Sign By-law Requirement	Rationale
1	To permit a total of seven (7) fascia signs for the McDonald's drive-through restaurant.	A maximum of two (2) fascia signs are permitted for each premises (Part 5, Section 27(2)(a))	The proposed fascia signs are of an appropriate size and scale in relation to the proposed building
2	To allow three (3) fascia signs to be installed on the same (west) building façade for the McDonald's drivethrough restaurant.	A maximum of two (2) fascia signs are permitted provided that both of the fascia signs are not located on the same façade of the premises (Part 5, Section 27(2)(a))	The additional fascia signs proposed along the west façade includes two golden 'Arches' signs and an 'Open 24 Hours' sign, which is consistent with other McDonald's restaurants in the City.
3	To allow four (4) fascia signs to be installed on the same (south) building façade for the McDonald's drive-through restaurant.	A maximum of two (2) fascia signs are permitted provided that both of the fascia signs are not located on the same façade of the premises (Part 5, Section 27(2)(a))	The additional fascia signs proposed along the south façade includes a golden 'Arches' sign, a 'McCafe' sign and an 'Open 24 Hours' sign, which is consistent with other McDonald's restaurants in the City.

McDONALD'S APPROVALS

EXTERIOR ELEVATIONS APPROVAL
REGIONAL / NATIONAL DESIGN

LOT 57, SECTION 26, RANGE 2, PLAN 32067, NWD 10240 KING GEORGE HIGHWAY, SURREY, B.C.



DRAWING / CONSULTANT LIST:

<u>ARCHITECTU</u>RAL

LOVICK SCOTT ARCHITECTS LTD.
3707 1st AVENUE
BURNABY, B.C., V5C 3V6
(tel), 604.298.3700
(fax), 604.298.6081
(e-mail) peter@lovickscott.com
rreyes@lovickscott.com

A0.C COVER SHEET
A0.1 GENERAL NOTES, CODE ANALYSIS
& SPECIFICATIONS
A0.2 WALL & SIGNAGE SCHEDULE
ASO.0 CONTEXT PHOTOS

 AS1.0
 SITE PLAN (EXISTING)
 A2.3

 AS1.1
 PROPOSED GARBAGE ENCLOSURE PLAN, ELEVATIONS & SECTION
 A2.5

A1.0 EXISTING / DEMO FLOOR PLAN A1.1 PROPOSED FLOOR PLAN A1.4 EXISTING / DEMO ROOF PLAN

A1.5 PROPOSED ROOF PLAN

A2.0 EXISTING & PROPOSED WEST ELEVATIONS
A2.1 EXISTING & PROPOSED SOUTH ELEVATIONS
A2.2 EXISTING & PROPOSED EAST ELEVATIONS
A2.3 EXISTING & PROPOSED NORTH ELEVATIONS

A2.3 EXISTING & PROPOSED NOR A2.4 COLOURED ELEVATIONS A2.5 PERSPECTIVES

A3.0 BUILDING SECTIONS (A&B) A3.1 BUILDING SECTIONS (C)

LANDSCAPE

IBI GROUP 308 - 30 Eglington Ave. West Mississauga, On, L5R 3E7 (tel) 905.890.3550 (fax) 905.890.7081

LP1 LANDSCAPE PLAN LP2 LANDSCAPE PLAN EXTERIOR FINISHES SPECIFICATIONS: ISTED NOTES AND SPECIFICATIONS ARE TYPICAL APPLY ITEMS AS PER SCOPE OF WORK

GERTAINTEED: FIBER GEMENT 'PANEL' & LAP

PANELS: SMOOTH FINISH 48" x 96" x 5/16" PANELS, UNLESS NOTED OTHERWISE.

OTERORE

SIGN PAINTD COLORS, (REPER TO ELEVATIONS)

LIGHT GERT, DILLIN PAINT FEOD'S GERT MCD 50

FEDIN GERT, DILLIN PAIN TROOF GERT MCD 50

FEDIN GERT, DILLIN PAIN TROOF GERT MCD 42

LAP, CEDAR LAP, 5 (M° S MC GHACOAL GERT MCD 42

SECOND TOLLIN PAINT CHETNITH ACCAPT ERONN MCD 31

REVELS, CLEAR MODIZED THICH - DONTRINI

PRODUCT INSTALLATION NOTES:

SECOLAL INSULATION NOTES:
VERTICAL PAREL FASTENERS; MUST LINE UP BOTH VERTICALLY 4
HORIZONTALLY, OFFSET FASTENERS WILL NOT SE ACCEPTED AND
PANELS MAY HAVE TO BE REPLACED WERE FASTENERS DO NOT
LINE UP.

LINE UP.
ALL FASTINERS ARE TO BE STAINLESS STEEL, FACTORY
PRE-PAINTED TO MATCH ADJACENT PANELS, 6.C. TO RE-TOJC.
PAINTED S.S. FASTINERS ONCE PANELS ARE INSTALLED (PAIN
MATCH FACTORY PAINT COLCUR AND TYPE).

3. REVEALS ARE TO BE INSTALLED TRUE & PLIMB.

EASYTRIM J-CHANNEL MUST BE INSTALLED AROUND SIDE EDGES OF ALL DOORS, WINDOWS, LIGHT FIXTURES & WATER HOSE BOXES AND EASYTRIM 5-CHANNEL OF ALL DOORS, WINDOWS, LIGHT FIXTURES &

4. EAST INM 5-CHANNEL OF ALL DOORS, MIDDONS, LIGHT FIXTURES & WATER ROSE BOXES HEAD. REVEALS INSTALLED OVER OTHER REVEALS THAT REQUIRE: 5. NOTICHING SHOULD HAVE NOTICHES CUT IN PIRST REVEAL & NOT THE EXPOSED REVEAL.

DRYGGED REVEAL.
SHA (JUTS IN PARELS AROND FLASHING SHOULD BE NEAT AND NO MIDER THAN NECESSARY. EXISTING JUTS MIST BE CONCEALED WITH L-CHANNEL, OR THE PARELS REPLACED.
CARE MIST BE EXERCISED WITH HANDLING/CUITTING THE PANELS TO AVOID CHIPPED EDGES, DANAGED PANELS SHOULD BUT IN INSTALLED PACELT IN LOW VISIBLE AREAS SOUCH AS INSIDE FACES.

8. EXPOSED PANEL EDGES ARE TO BE FACTORY EDGES AS OPPOSED TO CUT EDGES.

4 EFER TO MARKACTINERS SPECIFICATIONS FOR ADDITIONAL MISTAL ATOM REQUIREMS. SPECIFICATIONS FOR ADDITIONAL MISTAL ATOM REQUIREMS. SPECIFIC PRODUCTS SCREENS RECO FOR SMOOTH (O, MARCH PAREL TO BE 56 AND PRIE PAINTED TO MATCH THE SURROGATIONS PAREL.

ALTERNATIVES FOR CERTAINTEED & EASY TRIM PRODUCTS WILL NOT

ALPOLIC METAL PANELS (SEE DESPONSIBILITY CHAPT)

4MM PANEL THICKNESS TYPICAL DRY JOINTS DRY JOINTS
30" X 60" TYPICAL PANEL SIZE
ALTERNATIVE PRODUCTS WILL NOT BE ACCEPTED
CONTRACTOR TO PROVIDE SHOP DRAWINGS FOR ARCHITECTS

RED PANEL: RON RED, FEVE LUMIFION PAINT SYSTEM, 80% 6L0SS.

WHITE PANEL: BNT WHITE, FEVE LIMIFION PAINT SYSTEM, 30% GL095. CONTRACTOR TO CONTACT SUPPLIER IMMEDIATELY UPON TENDER ANARD SPETIES A SIGNED PURCHASE ORDER FROM THE CONTRACTOR BY THE MIDDLE OF OF THE SECOND MEEK. IT IS CRITICAL THAT THE CONTRACTOR COMPLETE ALL FIELD MEASUREMENTS AND FORWARD THEM TO SUPPLIER BY THE END OF

METAL SIDING: (SEE RESPONSIBILITY CHART) PREFINISHED ADISO MEDIUM GREY: "REGENT GREY" GCI6082 DARK GREY: 'CHARCOAL GREY' QCI6082

ALTERNATIVE PRODUCTS WILL NOT BE ACCEPTED. METAL CAP FLASHING:

24 SAUSE

ALL JOINTS ARE TO BE 5-JOINTS, NO EXPOSED FASTENERS
PREPRINSHED CHARCOAL GREY GC 60T2 OR TO MATCH METAL
PANEL AS PER ELEVATIONS

METAL ROOFING: PREFINISHED VICHEST TRADITION IOO
MEDIM GREY: VICHEST TREGENT GREY QCIGOB2
DARK GREY: VICHEST 'CHARCOAL GREY' QCIGOT;
OR AS PER ELEVATIONS

ASPHALT ROOFING: IKO-TAB "CHARCOAL GREY" MARATHON 25 AR OR EQUIVALENT UPON MCD'S PM'S APPROVAL.

PAINTED METAL:

DULUX PAINT DEVTHANE 3T9

DALLIX PAINT DEVTHAVE 3TH CLEAN AND PREPARE SIGNACE HITH PAINT MANUFACTURER'S RECOMMENDED SURFACE CONDITIONER TO REMOVE ALL RUST AND DIRT. BENGRE SURFACE IS THOROUGHLY DRY PRIOR TO PAINTING PAINT TO BE COLOUR MATCHED TO ELEVATION SPECIFIED COLOUR

OR LIGHT GREY: DULIX PAINT MCD 52 MEDIUM GREY: DULIX PAINT MCD 48 DARK GREY: DULIX PAINT MCD 44 RED: DULIX PAINT McDONALD'S RED' MCD 53 NAWKAW CONCRETE AND MASONRY STAIN:

STANDET DE UBED ON INCOATED MASONRY/CONCRETE/STUCCO
SIRFACES
LIGHT GREY, NANKAN FROST GREY'
MEDINI GREY, NANKAN FROST GREY'
DAKK GREY, NANKAN HEGHT GREY
BROWN, NANKAN KURSENT GREY'
BROWN, NANKAN KURSENTI BROWN

ALTERNATIVE PRODUCTS WILL NOT BE ACCEPTED

STUCCO PAINT: TILCCO PAINT:
DULIX PAINT-EXTERIOR MG SATIN MAX LATEX
HAITE DULIX PAINT HAITE MCD 51
LIGHT GREY, DULIX PAINT FROOT GREY MCD 50
MEDUM GREY, DULIX PAINT REGENT GREY MCD 40
BROWN GREY, DULIX PAINT SCHARCOAL, GREY MCD 42
BROWN DULIX PAINT CHARCOAL, GREY MCD 42
BROWN DULIX PAINT CHARNITACAFE BROWN MCD 3

SPANDREL PANEL GLAZING: ENTERIOR LITE 6mm TEMPERED 61A/55
1/2* ANSE/ACE
1/2* ANSE/

NOTE:

NOTE:
- NHEN ORDERING, CONTRACTOR MIST INDICATE MCDONALD'S
ACCOUNT
N. ADDITION TO THE COLOUR CODE MCD...!
- ALTERNATIVE MATERIALS MAY BE APPROVED AT THE
DESCRIPTION OF THE NATIONAL DESIGN AND CONSTRUCTION
DETARMINENT CONTROL MICHAEL AND CONSTRUCTION.

CONSTRUCTION AND SITE REVIEW NOTES

THESE DRAWINGS HAVE BEEN ARCHITECTURALLY DESIGNED &
INSHIBERED IN CONFORMACE WITH PART 3 OF BCBC, 2012.

FOLLONING IS LA LIST OF SITE REVIEWS THAT ARE REGINED DURING
CONSTRUCTION. CONTRACTOR IS TO NOTIFY ARCHITECT AND
INSHIPERS S DAYS PRIOR TO REQUIRED SITE REVIEW. ALL
INSPECTIONS MIST BE COMPLETE IF CONTRACTOR IS TO OSTAIN.

OCCUPANCY, CONTRACTOR IS TO KEEP PROGRESS PHOTOGRAPHS OF THE CONSTRUCTION, CONTRACTOR SHALL TAKE A MINIMUM OF IO PHOTOGRAPHS ON THE PRIDAY OF EACH MEEK OF CONSTRUCTION.
CONTRACTOR TO SUBMIT A CD OF THE PHOTOGRAPHS TO THE
MCDONALD'S PROJECT MANAGER AT THE CONCLUSION OF THE PROJECT

CONTRACTOR TO INFORM ARCHITECT WHEN CONSTRUCTION BEGINS.

CONTRACTOR SHALL VERIFY ALL DIMENSIONS PRIOR TO CONSTRUCTION AND INFORM THE ARCHITECT IF THERE ARE ANY DISCREPANCIES.

CONTRACTOR TO PROVIDE A CONSTRUCTION SAFETY PLAN.

ARCHITECTURAL SITE REVIEWS: (CONFIRM W/ ARCHITECT)

FRAMING AND LAYOUT.
ON COMPLETION OF INSTALLATION OF INSULATION AND VAPOUR BARRIER
BRIDE TO BOARDING.

ON COMPLETION OF WINDOW MEMBRANE FLASHING INSTALLATION. ON COMPLETION OF PROJECT PRIOR TO OCCUPANCY INSPECTION & AFTER ENGINEERS FINAL REVIEWS WITH LOCAL BUILDING INSPECTOR.

STRUCTURAL SITE REVIEWS: (CONFIRM W/ STRUCT, P. ENG.) PRIOR TO COMMENCEMENT OF PILINS. SOME JOBS REQUIRE INSPECTIONS FOR THE PILE LENGTH REINFORCING. IN OTHER CASES, A GEOTECHNICAL ENGINEER WILL BE DOING THE INSPECTIONS.

PRIOR TO POUR OF FIRST PILE GAPS (IF ANY).

PRIOR TO POUR OF FIRST GRADE BEAM AND PRIOR TO SUBSEQUENT GRADE BEAM POURS

PRIOR TO POUR OF SLAB. IF SLAB IS DONE IN SEVERAL POURS, WE SHOULD BE CALLED FOR EACH PRINTING.

ONCE FRAMING IS IP, BUT BEFORE WALLS ARE CLOSED IN AND ROOFING IS ON.
THEY WILL ALSO NEED TO ENSURE THE TRUSS SUPPLIER INSPECTS THE
INSTALL ATION DEPONE THE WALLS ARE CLOSED IN OR ROOFING/CELLING IS IN.

AFTER THE NEW LINTELS ARE INSTALLED BUT BEFORE THEYARE CLOSED

AFTER THE EXTRA STUDS/BLOCKING IS IN PLACE FOR THE CANOPIES BUT BEFORE THE WALLS ARE CLOSED UP. AS WELL AS AFTER ALL THE CANOPY FRAMING IS INSTALLED.

ELECTRICAL SITE REVIEWS: (CONFIRM W/ ELEC. P. ENG.)

AT COMPLETION OF ELECTRICAL WIRING ROUGH-IN PRIOR TO BOARDING. AT COMPLETION OF PROJECT WHEN ALL LIGHTING, LIFE SAFETY AND POWER SYSTEMS ARE OPERATIONAL.

MECHANICAL SITE REVIEWS: (CONFIRM W/ MECH. P. ENG.)

BELOW GRADE PIPING COMPLETION PRIOR TO BACKELLING

AT COMPLETION OF PLUMBING ROUGH-INS AND PRESSURE TEST PRIOR TO BOARDING, AT COMPLETION OF H.V.A.C EQUIPMENT AND DUCTS ROUGH-IN PRIOR TO THE INSTALLATION OF CELLINGS.

AT SUBSTANTIAL COMPLETION OF PROJECT WHEN ALL PLIMBING AND HAVAC. SYSTEMS ARE COMPLETE AND ARE OPERATIONALLY ON AFTER CITY FINAL.

DEMOLITION NOTES

IT IS THE INTENT OF THESE DRAWINGS THAT THE AREA SHOWN IN THE SCORE OF WORK BE FREPARED FOR THE REPOVATION BY SELECTIVE DEPOLLITION AND REPOVAL, OF THE SINDCATED. SOPE THOSE WILL REQUIRE CAREFUL REMOVAL, STORAGE AND INVESTORY FOR REISE IN THE REMOVATION, LISTED MOTES AND SPECIFICATIONS ARE TYPICAL, APPLY ITEMS AS FER SCORE OF MORES.

CONTRACTOR SHALL VERIFY FIELD CONDITIONS AND NOTIFY INTERIOR ARCHITECT OF ALL DISCREPANCIES BEFORE PROCEEDING WITH WORK.

PROVIDE AND MAINTAIN HOARDING, FIRE ALARM AND EXITING LIGHTING AND GUARD RALS TO PROTECT OCCUPANTS OF BUILDING, MORKERS AND GUESTS, AND AS REQUIRED BY APPLICABLE REGULATORY ADMISORY.

AZVISORY.

ARRANCE AND PAY FOR DISCONDECTING, REMOVING AND CAPPING UTILITY SERVICES WITHIN AREAS OF DEMOLITION. DISCONDECT AND STIB OFF. NOTIFY THE AFFECTED UTILITY COMPANY NO. ON STIE OFFECTATIONS MANAGER IN ADVINCE AND OBTAIN APPROVAL BEFORE STARTING THE MORE.

STARTING THIS WORK, ALL DEMOLISHED MATERIALS NOT FOR REUSE TO BE IMMEDIATELY REMOVED FROM SITE 4 PROPERLY DISPOSED OF,

PERFORM DEMOLITION IN ACCORDANCE WITH APPLICABLE AUTHORITIES HAVINS JURISDICTION.

DEMOLISH EXISTING WALLS WITH CARE, DO NOT DAMAGE ADJACENT SURFACES NOTED TO REMAIN. PROVIDE TEMPORARY SHORING WHERE REQUIRED PRIOR TO REMOVAL OF STRUCTURAL FRAMING MEMBERS.

REPAIR ALL DEMOLITION PERFORMED IN EXCESS OF THAT REQUIRED AT NO COST TO THE OWNER. NO COST TO THE CHIEFE

NEWTOW EDWISTED MATERIALS, TOOLS AND EQUIPMENT FROM SITE UPON COMPLETION OF MORK. LEAVE SITE IN A CONDITION ACCEPTABLE TO THE OWNER TWO AD ACCITIENT.

UPON DISCOVERY OF HAZARDOUS OR CONTAMINATED MATERIALS CONFORT TO APPLICATE STATUTION REQUIREMENTS AND IMPEDIALEST AND VIOLENCE STATUTION REQUIREMENTS AND IMPEDIALEST AND CASE ACCITIENT.

UPON DISCOVERY OF ANY ROT OR MOULD DURING CONSTRUCTION, CONTRACTOR IS TO INFORM THE ARCHITECT FOR REMEDIATION

CONFORM TO ALL APPLICABLE CODES FOR DEMOLITION WORK, SAFETY OF STRUCTURE, SAFETY OF MATERIALS HANDLING AND DUST CONTROL.

CONFIRM WITH MCDONALD'S PROJECT MANAGER FOR DISPOSAL OF EXISTING FURNITURE, PLAY PLACE FURNITURE AND KITCHEN EQUIPMENT

DISHIP INVESTIGE, PLAT TAZE PRINTING AND SILICENS EXPERTING NO NEW TACKS. THE PLATE TAXE DESIRING CONTRACTION WITH A THE PLATE TAXE DESIRING ACCURATE AND PRESENTE TO ACCURATE NATIONAL PRINTING THE PLATE TO THE PLATE TAXES OF TAXES OF TAXES THE PLATE TAXES OF THE PLATE TAXES OF TAXES THE PLATE TAXES OF TAXES OF

NEW WALL TILE.

CONTRACTOR HIS REMOVE ALL LAYERS OF EXSTINS HALL TILE AND
REPERACE SHEFACE TO ACCEPT NEW TILE PRIOR TO INSTALLATION OF
REPOVED PRIOR TILE INSTALLATION IN INSTALLATION SHEFACE
REPOVED PRIOR TILE INSTALLATION IN INSTALLED AFTER
TO SE

NERVICE PRICE IN ILE ROJALLATION IN ROJALLED AFTER.

MEREE PRAMANDS SHOW NEW CELLINGS, EXISTING CELLING IS TO BE REMOVED & DISPOSED OF, ALONG MITH ALL EXISTING LIGHTING, REFE TO ELECTRICAL, NEW LIGHTING, EQUIPMENT AND EQ. 4 RE CELLING MODIFIED LIFE SAFETY EQUIPMENT, REFER TO MECHANICAL DRAWINGS FOR NEW OR REVISED DUCT MO SPILL LICACITIONS.

WHERE NEW FINISHES ARE SHOWN EXISTING FINISHES ARE TO BE REMOVED AND DISPOSED OF AND EXISTING SURFACE IS TO BE FREPARED FOR NEW FINISHES UNLESS NOTED OTHERWISE.

PRIOR TO CUTTING DOOR OPENINGS INTO EXISTING WALLS, OPEN CELLING TO CONFIRM THAT EXISTING WALL IS NOT LOAD-BEARING. IF WALL IS LOAD-BEARING CONTRACTOR MUST CONTACT STRUCTURAL ENGINEER FOR INSTRUCTIONS.

 RELOCATE THERMOSTATS, RECEPTACLES, SHITCHES, FAN CONTROLS AND OTHER ELECTRICAL / MECHANICAL DEVICES ON DEMOLISHED WALLS. CONFIRM WITH THE MCDONALD'S PROJECT MANAGER FOR THE REJOCATION OF EXISTING SECURITY DEVICES, SOUND SYSTEM EQUIPMENT OR MONITORS LOCATED ON DEMOLISHED WALLS AND CELLINGS.

20.ALL TRENCHING TO THE FLOOR SLAB OUTSIDE OF THE RENOVATION AREA IS TO BE REPAIRED AS PER THE STRUCTURAL ENGINEER'S DIRECTIONS AND TO MATCH EXISTING FINISHES.

I. ANY EXISTING UNDER SLAB CONDUITS ARE FOUND WITH IN DEMOLISHED MALLS THEY ARE TO BE CAPPED LEVEL, WITH SLAB AND EXISTING MRING IS TO BE RAIN OVER HEAD TO NEW LOCATION. IF MIRING IS NOT RESUIRED CONTRACTOR IS TO REMOVE.

GENERAL NOTES

IS THE NITH OF THES SPANNING THAT THE AREA SHANN IN THE SCOTE, OF HOSE BET REPORTED FOR ANY BROCKATION BY DELECTIVE PROJECT AND REPORTAL FOR THE BROCKATION FOR BELLEN EXPENSIVE AND REPORTAL OF THIS BROCKATION. SAVE THIS WILL REQUIRE CAREFUL REPORTAL TO CONTROL AND SPECIFIC ATTIONS ARE TYPICAL. APPLY TITES AS PER SCOTE OF THE SERVICE AND SPECIFIC ATTIONS ARE TYPICAL. APPLY TITES AS PER SCOTE OF THOSE AND SPECIFIC ATTIONS AND SPECIFIC ATTIONS AS PER SCOTE OF THOSE AND SPECIFIC ATTIONS AS PER SCOTE OF THOSE AND SPECIFIC ATTIONS AS PER SCOTE OF THOSE AS PER SCOTE OF THOSE AND SPECIFIC ATTIONS AS PER SCOTE OF THOSE OF THOSE AS PER SCOTE OF THOSE OF

THESE DRAWINGS SHALL NOT BE SCALED.

THESE DRAWINGS ARE TO BE READ IN CONJUNCTION WITH STRUCTURAL, MECHANICAL, ELECTRICAL, AND INTERIOR DESIGN DRAWINGS AS A COMPLETE SET.

COMPATE SET.

ALL HORS SHALL COMPORT TO THE CURRENT APPLICABLE PROVINCIAL
BILDING COSE AND ALL LOCAL MINISTER, COSES AND BYTAMON
COSTINGUIS ON THE PROPERTY ALL DATINGS PROBLEMS, MILLIONS PROBLEMS
COSTINGUIS ON THE PROPERTY ALL DATINGS PROBLEMS, MILLIONS PROBLEMS
EAST-PROPERTY ALL DATINGS PROBLEMS, MILLIONS PROBLEMS
EAST-PROPERTY ALL DATINGS PROBLEMS PROBLEMS
OF COMPANION OF THE PROCEDUIS OF THE PROBLEMS PROBLEMS PROBLEMS
OF COMPANION OF THE PROBLEMS PROBLEMS PROBLEMS
OF COMPANION OF THE PROBLEMS PROBLEMS PROBLEMS
OF COMPANION OF THE PROBLEMS PROBL

SILE AND LICAMINOSIS TO THE WORST CASE SCENARIO.
CONTRACTOR TO PROVIDE A COMPLETE MECHANICAL (VENTILATION) &
PUMPING SYSTEM IN ACCORDANCE WITH THE CURRENT APPLICABLE
PROVINCIAL BUILDING CODE AND RELATED STANDARDS GOVERNING THE
WORK.

PLECTRICAL DESIGN AND INSTALLATION TO CONFORM TO THE CURRENT APPLICABLE PROVINCIAL BUILDING CODE AND ALL LOCAL MUNICIPAL. ELECTRICAL AND MECHANICAL DRAWINGS ARE TO TAKE PRECEDENCE OVER KITCHEN DRAWINGS.

FASTEN ALL GYPSUM WALLBOARD (GMB) IN CONFORMANCE WITH SUBSECTION 9,29.5 OF THE APPLICABLE PROVINCIAL BUILDING CODE. ALL WORK DONE IN CONNECTION WITH THESE SPECIFICATIONS AND DRAWINGS MUST COMPLY WITH THE INDUSTRIAL HEALTH AND SAFETY RESULLATIONS OF THE MORKERS COMPENSATION BOARD OF THE APPLICABLE PROVINCE.

APPLICABLE PROVINCE.

FAME SPREAD RATING FOR INTERIOR FINISHES TO CONFORM TO THE CURRENT APPLICABLE PROVINCIAL BILLIONS CODE.

THE CONTRACTOR IS TO MAINTAIN RUISTING FIRE SEPARATIONS, GROUT OR SEAL ALL PRINCIPADIONS THRU FIRE SEPARATIONS TO MAINTAIN THE INTERRITY OF THE FIRE SEPARATION.

INLEGALT OF THE FIRE SEPARATION.
ALL RIKE SEPARATION PARTITIONS ARE TO EXTEND FROM THE FLOOR
SLAS TO THE MORRESIDE OF THE STRUCTURE ABOVE TO PROVIDE A
SPORE-THEIR I FIRE STOPPER SEPARATION. CONTRACTOR IS TO
MAINTAIN THE INTERESTY OF THE SESTIME FIRE SEPARATIONS, FLOOR
FENETRATIONS ARE TO BE MATER TIGHT.
WHERE ISEN I PURING MEANING.

WHERE NEW PLUMBING VENTS PENETRATE CEILING (WITHIN STUD PARTITIONS (a.C. TO PROVIDE POSITIVE SEAL EFFICIENT STUD PARTITIONS) (a.C. TO PROVIDE POSITIVE SEAL EFFICIENT SEAT NO SIDES OF OPENING. ALL PERETRATION TIRCUPH FIRE RATED WALLS AND CELLING MIST BE SEALED WITH FIRE RATED CALLK OR CONTRACTOR MIST PROVIDE FIRE DAMPER.

MIST REVOVUE FIRE DAMPER.

SEPERAL CONTRACTOR TO REVIEW ALL ARCHTECTURAL, MECHANICAL, AND ELECTRICAL DRAWINGS AND IS REPONSIBLE FOR ALL ADDITIONAL OPENINGS FIRE SUDOIS, MALLS, REPERALES, ADJOINE FLOORS FOR MECHANICAL REQUIREMENTS, ELECTRICAL REVIEWS, DAMJOT REVIEWS, ACCESS PARIAS AND OTHER OPENINSS FOR SHOWN ON DRAWINGS. IF ANY BOT OR POULD IS DISCOVERED DURING CONSTRUCTION, CONTRACTOR, IS TO INFORM THE AGENTLECT FOR REPEDATION.

CONTRACTOR IS 1/2 INFORM IT.

INSTRUCTION.

ALL 6/88 IN RELION HINDONS THAT IS REQUIRED TO BE REPLACED
DIRING CONSTRUCTION IS TO BE REPLACED WITH 1/2" CEMENT BOARD.

ALL 6/88 IN NASHROOM THAT IS REQUIRED TO BE REPLACED DIRING
CONSTRUCTION TO TO BE REPLACED WITH 1/2" CEMEN DOAND TO 4%
AFF., 1/2" 6/88 ABOVE 4/4" AFF.

ACT., LE GIND ABOVE 40' AFF.

CONTRACTOR IS RESPONSIBLE FOR PROCUREMENT, DELIVERY, STORAGE, UKCHATING, AGENETY, AND FINA, FLACEMENT OF ALL TITHS, INCLIDNS OWER SIMPLED ITH NULES NOTED OTHERWISE.

ANY DAMAGE, INCREED DIRECTLY, OR INDIRECTLY BY CONSTRUCTION NORK SIALL BE REPAIRED AND MADE 600D AT NOT COST TO THE OWNER.

CANDER.

THE CONTRACTOR SHALL FAMILIARIZE HIMSELF WITH THE SOILS
CONDITIONS AND FOLLOW THE RECOMMENDATIONS OF THE SOIL REPORT.
CONTRACTOR TO SLOPE FINISH EARNOR MANY FROM THE BUILDINGS MIN.
1/4" FER 1-0" TO PROVIDE ADEQUATE DRAINASE AND MEET ALL CITY
BUILDING RANGE.

22. SUPPLY SHOP DRAWINGS OF ALL SPECIALTY ITEMS FOR ARCHITECTS APPROVAL.
23. CONFIRM ALL NEW KITCHEN EQUIPMENT CLEARANCES PRIOR TO

CONTRACTOR TO INSPECT ALL EXISTING WASHROOM ACCESSORIES NOTED TO REMAIN AND REPLACE ANY DAMAGED WASHROOM

NOTED TO REMAIN AND REPLACE ANY DAMAGED AWGROOM ACCESSORIES, INSTAIL MODD ELOCKING FOR ALL WAGROOM ACCESSORIES, HADRALL MODD ELOCKING FOR ALL WAGROOM ACCESSORIES, REPER TO STRUCTURAL DRAWINGS FOR INTERIOR BEARING AND SHEAR WALL INFORMATION.

WALL INCOMPATION.

CONTRACTOR SHALL DETERMINE DISTING SLAD SPROOF AND RESPONDED BY SHALL DETERMINE DISTING SLAD SPROOF AND RESPONDED BY SHALL HE PARTIALLY EMPOSION AS SHALL DEAL PROPERTY OF THE SHARL SHAD AND A SHARL BE ALL AND DAY. CANTROLLOW DETERMINES THAT DESCRIPTION AND A SHARL BY SHAR

LEPHILES, AND PLES CELLING PHYROLOGY, PROFIT IN SINCLINGAL PARTY IN SINCLINGAL PROFIT IN SINC

ZONITS TO BEASER A CONTINUOS SEAL.

20 ALE PTIVODO NO POSO BLOCKHO ISEED AT GRADE OR AS PART OF
THE ROOF CONSTRUCTION SHALL BE PRESSIRE—TREATED.

30 ARM INCH LOSE PRINCIPAS SHALL BE RESISTED TREATED.

BEGGER ALL BESTINGS ARE DESIGNED INTERVALED OR SHALL BE CONTINUO MAY EXPLAIN SHAME SHALL BE CONTINUO MAY BE REPLAINED TO THE PRESSIRE THE SHAME SHA

ALL NEW INTERIOR WALLS DIMENSIONED FROM OUTSIDE OF EXTERIOR SHEATHING TO CENTERLINE OF WALL (UN.O.).

S. U.N.O. ALL INTERIOR STEEL STID WALL MODER 12-0* ARE TO BE 3 5/6*, ALL STEEL STID WALLS UP TO 20°0° ARE TO BE 6°. ALL INTERIOR WALLS DELIVERADOS ENSINEEDED BY STEEL STID CONTRACTOR CONTRACTOR TO PROVIDE SEISHIC ENSINEERED SHOP DRAWINGS FOR ARCHTECTS APPROVIAL.

CONSTRUCTION IS TO BE 1/2" CEMENT BOARD TO 48" A.F.F. WITH 1/2" SWB ABOVE 48"

ABORE 40°

CONTRACTOR MOST EMPS ALL PINISED DEPOSED CORNESS OF NISH FLASHING IN AREAS ACCESSED ED THE PER LC, CORTINE FLASHING IN AREA ACCESSED ED THE PER LC, CORTINE FLASHING IN ART MAY.

AREA THE SERVICE CORNESS IS TO BE EXTREMED ON MODIFIED THAT THE THE SERVICE CORNESS IS TO BE EXTREMED ON MODIFIED THAT AREA THAT AREA TO BE EXTREMED TO BE ACCESSED TO BE ACCESSED TO THE SERVICE CORNESS OF BE EXTREMED TO BE ACCESSED TO BE ACCESSED THE SECRETARY OF THE ACCESSED THE SERVICE ACCESSED THE SECRETARY OF THE ACCESSED THE SECRETARY OF THE SECRETARY OF THE ACCESSED THE SECRETARY OF THE SECRETARY

CONTRACTOR TO COORDINATE INSULATION AND/OR CHASES FOR VENDER SUPPLIED PIPING IN UNIEATED ROOF SPACES.

SCOPE OF WORK

* RE-IMAGE RENOVATION.

* RE-IMAGE RENOVATION.

- NEW INTERIOR LOBBY/DINING & WASHROOMS

- NEW EXTERIOR FINISHES

- NEW CUSTOMER SERVICE LAYOUT

SCOPE OF WORK TO BE CONFIRMED WITH MCD'S

BUILDING CODE ANALYSIS

OCCUPANCY

GROUP A ASSEMBLY OCCUPANCY

BUILDING CODE - 2012 BCBC

3.2.2.26
Group A. Division 2, I storey
- combustible or noncombustible construction
- not more than I storey in building height
- building area not more than 600 sq.m If facing 3 streets

OCCUPANT LOAD CALCULATIONS:

PUBLIC DINING 84 SEATS

STORAGE AREA 44.11 Sq.M. (474.8 Sq.Ft.) x 1 PERSON per 46 sq.m. = 0.96 I PERSON KITCHEN ADEA 110.10 Sq.M. (1185.13 Sq.Ft.) x 1 PERSON per 9.3 sq.m. = 11.84

12 PERSONS 19.14 Sq.M. (206.05 Sq.Ft.) x 1 PERSON per 9.3 sq.m. = 2.08 OFFICE AREA 2 PERSONS

TOTAL STAFF 15 PERSONS TOTAL OCCUPANT LOAD = 99 PERSONS

WATER CLOSETS (PER TABLE 3.1.2.2.A)

REGUIRED: I MALE / 2 FEMALE PROVIDED: 3 MALE (1 MC, 2 URINAL) 2 FEMALE (2 MC) I ACCESSIBLE UNISEX WASHROOM (I WC)

REQUIRED FIRE SEPARATION OF AREAS:

SERVICE ROOM (3.6.2.1): I HR (ELECTRICAL ROOM - EXISTING # NO CHANGE)

I HR (EXISTING & NO CHANGE)

EXIT REQUIREMENTS (3.4.2.) - (NO CHANGE)

PROVIDED: 3 (PROPOSED - I KITCHEN & 2 DINING)

TRAVEL DISTANCE: 30 m MAX

REQUIREMENTS FOR PERSONS WITH DISABILITIES: (EXISTING & NO CHANGE)

ENTRANCE:

<u>ن</u> (00)0 (25)

CONSTITUTE STATE

CONTRACTOR SHALL VERIFY ALL DIMENSIONS ON SITE, DRAWINGS SHALL NOT BE SOALED.



3707 1ST AVENUE BURNABY, BC V5C 3V6 ADMIN@LOVICKSCOTT.COM P: 604 298 3700 F: 604 298 608 MEMBER OF THE AIBC, AAA, SAA, NWTAA & RAIC


COPYRIGHT LOVICK SCOTT ARCHITECTS LTD. THIS MATERIAL IS AN INSTRUME OF SEPVICE AND REMAINS AT ALL TIMES THE EXCLUSIVE PROPERTY OF LOVIC

McDonald's Restaurant

10240 - King George Hwy, SURREY, BC GENERAL NOTES, CODE ANALYSIS, AND SPECIFICATIONS

16-021 A 0.1 M-0'S NATIONAL NUMBER SCALE " = I'-0' 1/16 DATE BEVISION

8 '₹ -₹

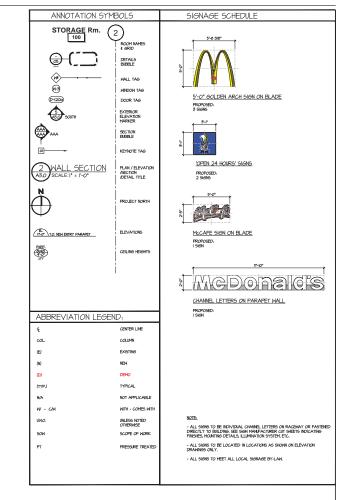



CONTRACTOR SHALL VERIFY ALL DIMENSIONS ON SITE, DRAWINGS SHALL NOT BE SCALED.



1ST AVENUE

McDonald's Restaurant


10240 - King George Ниу, SURREY, ВС

0240 - King George Hw URREY, BC	y.	-051
ANNS		₽
WALL & SIGNAGE	SCHEDULES	Sentral City (Whalley) - 16-021
OJECT NUMBER	DRAWING NUMBER	-≥.
b-02l	AO.2) ję
ALE 4" = 1'-0"	MID'S NATIONAL NUMBER 1196	_ <u>e</u>
TE	REVESION	- <u>‡</u>
PRIL 2016		_ద







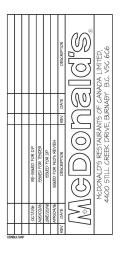



3707 1ST AVENUE
BURNABY, BC
ADMIN QLOVICKSCOTT.COM
P: 604 298 3700 F: 604 298 6081
MEMBER OF THE AIBC, AAA, SAA, NWTAA & RAIC
MOTRECUNA.












McDonald's Restaurant

DRAWING		-:
CONTEX	Т РНОТОБ	-
PROJECT NUMBER	DRAWING NUMBER	-
16-021	A50.0	_;
SCALE NOT TO SCALE	Mad's National Number 196	-
DATE APRIL 2016	REVISION OCT 2016	-

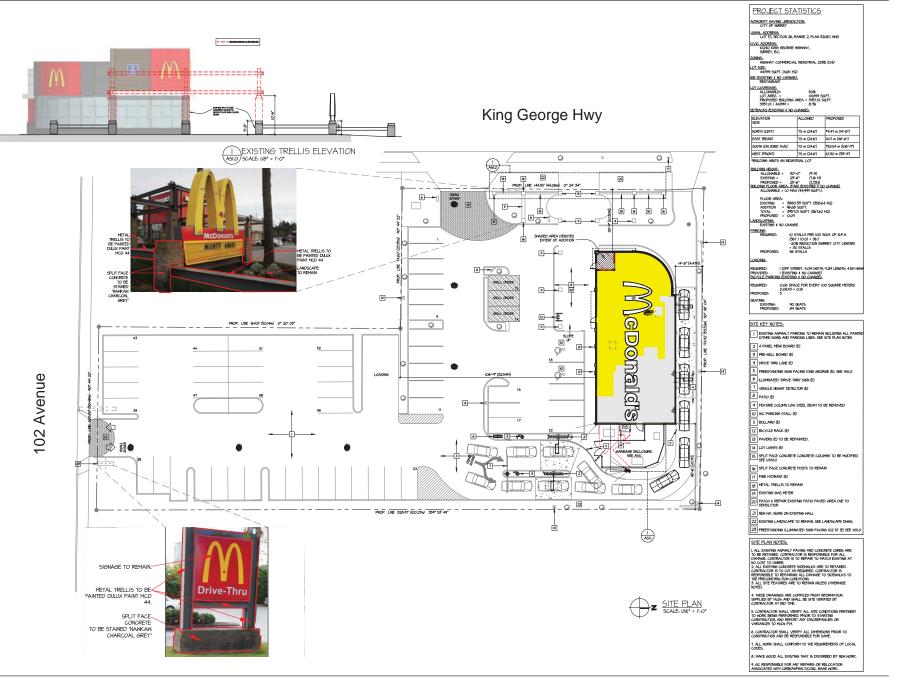




CONTRACTOR SHALL VERIFY ALL DIMENSIONS ON SITE, DRAWINGS SHALL NOT BE SOM FO.



1ST AVENUE BURNABY, BC V5C 3V6 ADMIN@LOVICKSCOTT.COM P: 604 298 3700 F: 604 298 6081 MEMBER OF THE AIBC, AAA, SAA, NWTAA & RAIC

McDonald's Restaurant

0240 - King Geo SURREY, BC	orge Hwy,	-051
GRAING S	ITE PLAN	Central City (Whalley) - 16-021
PROJECT NUMBER	CRAWING NUVBER	-≥
16-021	ASI.0	į.
SCALE	Mad's NATE(NAL NUMBER	- 🛁
I/16" = I'-O"	1196	_≌
STAC	REVISION	- 5
APRIL 2016	OCT 2016	_&

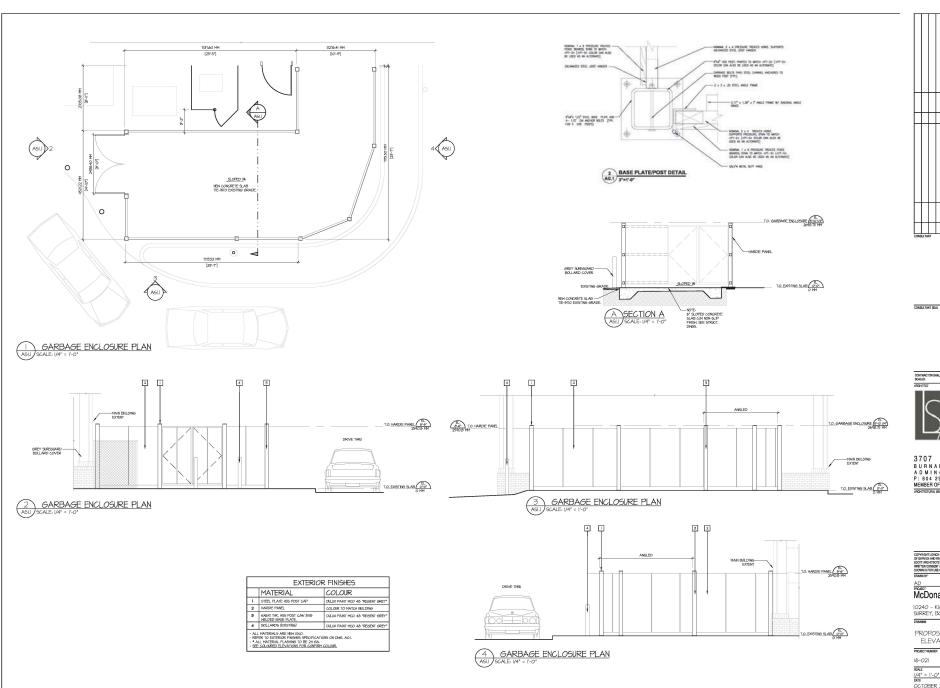



CONTRACTOR SHALL VERIFY ALL DIMENSIONS ON SITE. DRAWINGS SHALL NOT BE SOALED.

ARCHITECT




3707 1ST AVENUE
BURNABY, BC
ADMIN @ LOVICKSCOTT. COM
P: 804 298 3700 F: 804 298 8081
MEMBER OF THE AIBC, AAA, SAA, NWTAA & RAIC
ANDIFFCHAN SIZE.

McDonald's Restaurant

10240 - King George Ниц. SURREY, ВС

16-021

	- I
BAGE ENCLOSURI PLAN / SECTION	allev
DRAWING NUMBER	-≥
ASI.I	1
Maco'S NATIONAL NUMBER 1196	ral
REVISION	Sentral
	MICES NATIONAL NUMBER 1196

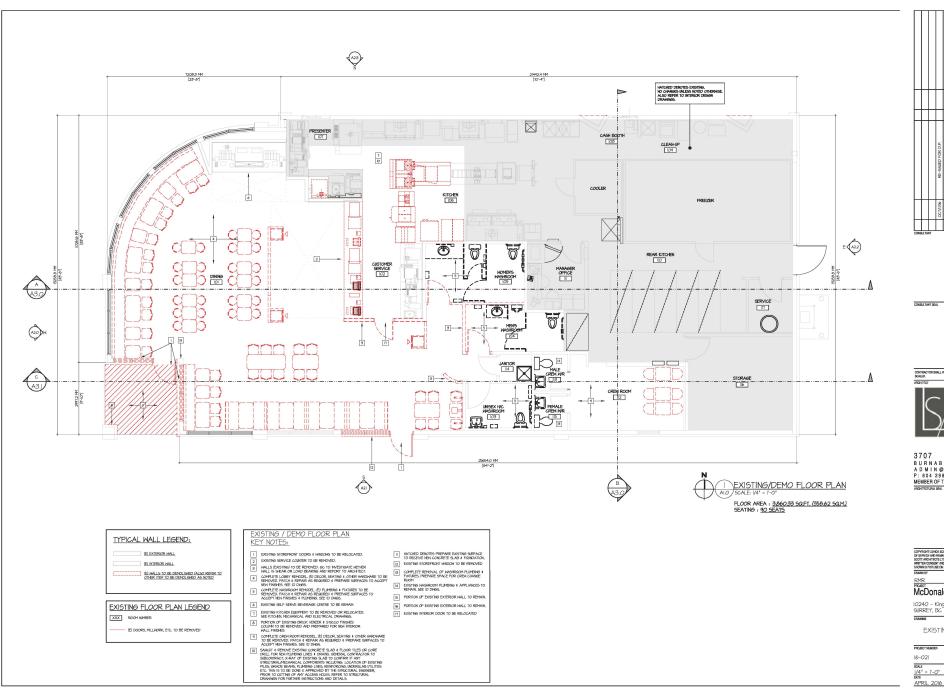



CONTRACTOR SHALL VERIFY ALL DIMENSIONS ON SITE, DRAWINGS SHALL MOT BE SCALED.




1ST AVENUE

McDonald's Restaurant

EXISTING/DEMO FLOOR PLAN

PROJECT NUMBER	DRAWING NUMBER
16-021	Al.O
SCALE	Maco'S NATIONAL NUMBER
1/4" = 1'-0"	1196
DATE	REVISION
APRIL 2016	OCT 2016

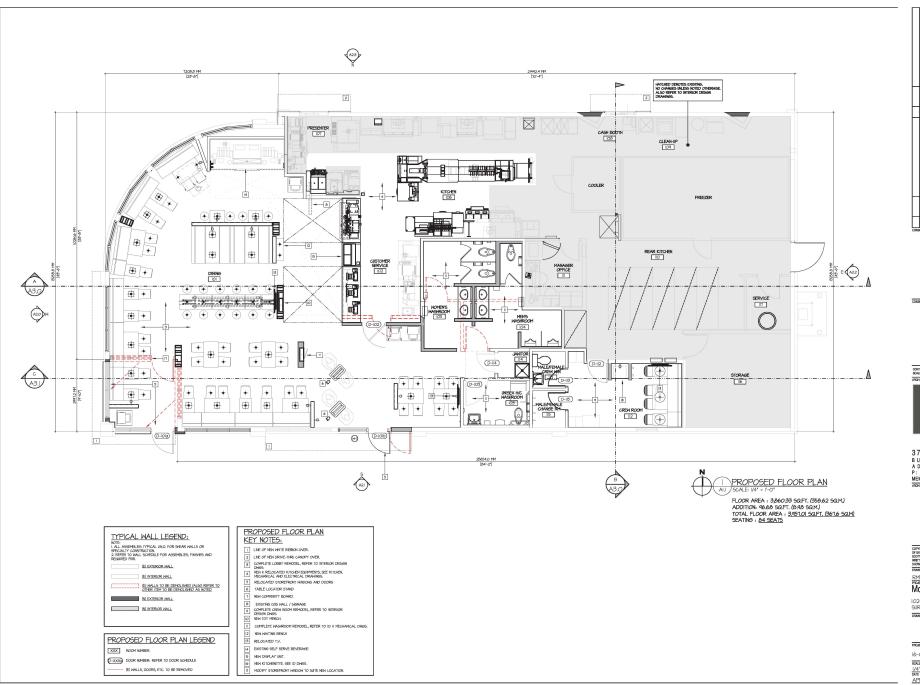




CONTRACTOR SHALL VERIFY ALL DIMENSIONS ON SITE, DRAWINGS SHALL MOT BE SCALED.



AVENUE 3707 1ST

McDonald's Restaurant

SURREY, BC	
DRAWING	
PROPOSEI	FLOOR PLAN
PROJECT NUMBER	DRAWING NUMBER
16-021	Al.I
SCALE	Mad'S NATIONAL NUMBER
1/4" = 1'-0"	1196
APRII 2016	OCT 2016

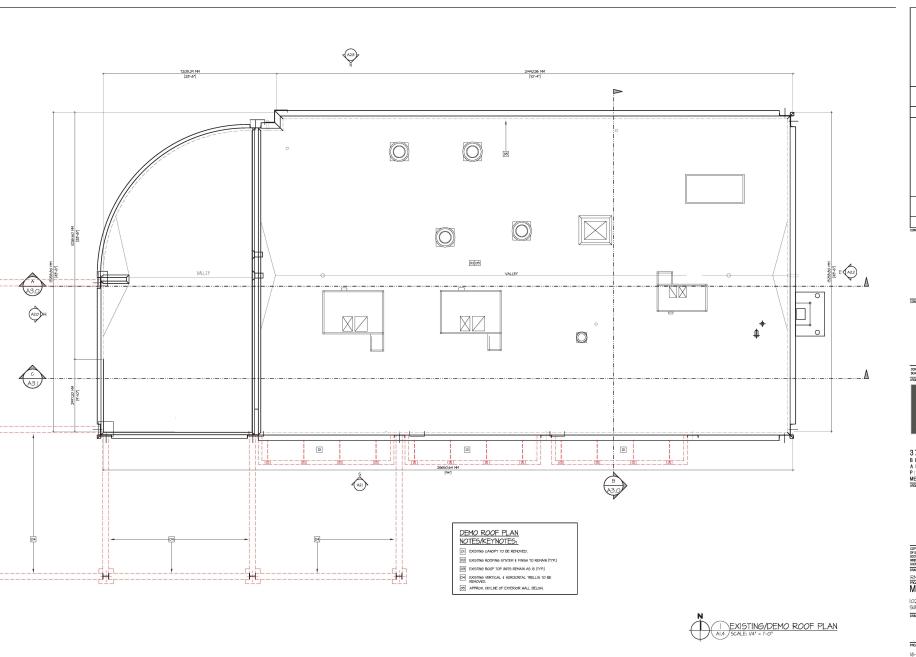






3707 1ST AVENUE
BURNABY, BC YSC 3V6
ADMIN @LOVICKSCOTT.COM
P: 604 298 3700 F: 604 298 6081
MEMBER OF THE AIBC, AAA, SAA, NWTAA & RAIC
AGGRICHAUSUS

RMR PROJECT McDonald's Restaurant

10240 - King George Ниц, SURREY, ВС

10240 - King Georg SURREY, BC	је Ниу,
DRAWING	
EXISTING/DE	EMO ROOF PLAN
PROJECT NUMBER	DRAWING NUMBER
16-021	Al.4
SCALE	MICES NATIONAL NUMBER
1/4" = 1'-0"	1196
DATE	REVISION
APRII 2016	

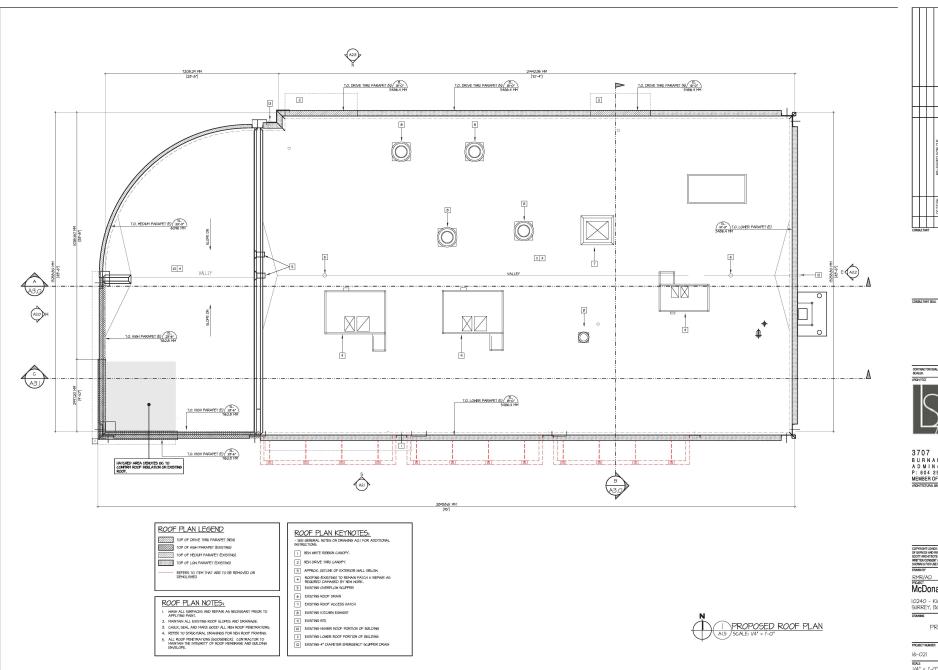






3707 1ST AVENUE BURNABY, BC V5C 3V6 ADMIN@LOVICKSCOTT.COM P: 804 298 3700 F: 804 298 8081 MEMBEROFIHE AIBC, AAA, SAA, NWTAA & RAIC ЖОНПОТИККИ.

McDonald's Restaurant

10240 - King George Hwy, SURREY, BC

10240 - King Geor SURREY, BC		- 6-05
	ED ROOF PLAN	(Whalley) - 16-021
PROJECT NUMBER	DRAWING NUMBER	-₹
16-021	AI.5	Ě
8CALE /4" = '-0"	Med'S NATIONAL NUMBER	<u>=</u>
DATE = 1-0	REVISION	Sentral

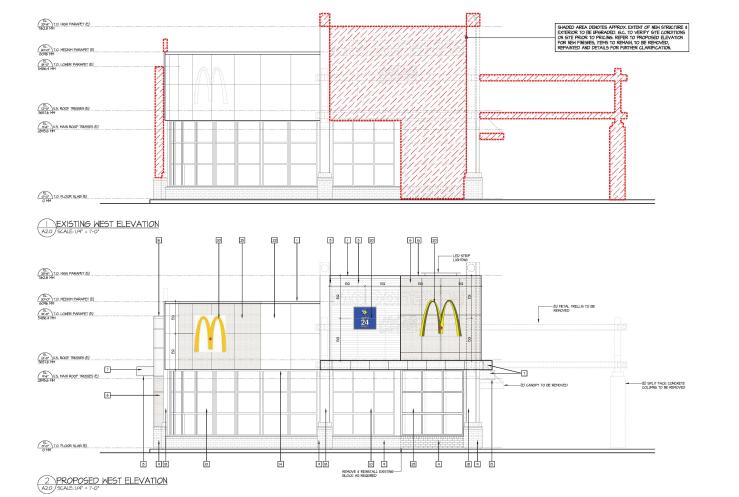

CONSULTANT SEAL CONTRACTOR SHALL VERIFY ALL DIMENSIONS ON SITE. DRAWNIGS SHALL MOT BE SCALED.

(O)

(M)

0



3707 1ST AVENUE BURNABY, BC V5C 3V6 ADMIN@LOVICKSCOTT.COM P: 604 298 3700 F: 604 298 6081 MEMBER OF THE AIBC, AAA, SAA, NWTAA & RAIC MONTICTUM. SUAL

ELEVATION NOTES:

REFER TO SCOPE OF WORK BEFORE APPLYING ITEMS BELOW.

- RETIRE TO SCOPE OF HORK EPFORE APPLYING INDIG BELOW

 L DITTIES THAT ALL ALDRING SCHITT (ALDRING HOTE) TO BE
 REVANDA, ME TO BE REVANDA AND DEPYORD BY 64, "HICKI'S

 PROVIDED AND TO BE REVANDE AND DEPYORD BY 64, "HICKI'S

 DESTINE HICKOR'S ALLRING HAZING DOORS HOTED TO BE REVANDA

 RETID BE REVANDA AND DEPYORD BY 64, MLLESS WITTO TO BE
 RETID BE REVANDA AND DEPYORD BY 64, MLLESS WITTO TO BE
 DISTRIBUTED AND DEPYORD BY 64, MLLESS WITTO TO BE
 DISTRIBUTED AND DEPYORD BY 64, MLLESS WITTO TO BE
 DISTRIBUTED AND SCHITT HE FORM FROM TO ORDINATE HER HICKORY.

 REVANDA ALD DEPTO BEDTERNICA CHIEFLES, MICHIGAI DEPOSITION DE
 REVANDA CAP OFF BEDTERNICA, LIFE BEDTERNICA BEDEFINES

 PROVIDED AND DEPTO HOR PERSON AS GETTO FROM THE TOTO TO BE
 REVANDA CAP OFF BEDTERNICA, LIFE BEDTERNICA BEDEFINES

 PROVIDED ENTONE DEPTO HOR PERSON AS GETTO RETIRE TO BE DEPTORD

 PROVIDE AND DEPTO HOR PERSON AS GETTO RETIRES, PRAY SAND CAP

 PLASHIBLE VIDEO TO BE REVANDE TO BE DIPROSED OF BE A FORM OFF

 PLASHIBLE VIDEO TO BE REVANDE TO BE DIPROSED OF BEAT AND THE
 REVANDA DE TORM OFF AND THE DIPROSE OFF AND THE MESTING

 ROT OR HERD TALL DEPTINE WASHE OR BEDTERNOS THAT OF THE
 ROT OR HOD DE DECOMPERED PROJECT HANGES A ARCHITECT IS TO BE
 ROTTED THE SAND THE OR SECRETION OF BENTONDE OF BENTONDE OF BENTONDE OF THE REVERDED OF BENTONDE OF THE REVERDED OF BENTONDE OF THE REVERDED OF THE REVER

- MASH ALL SIRPACES AND REPAIR AS NECESSARY PRIOR TO APPLYING PAINT.
 PAINT, ANY POSITING DAMAGED STILCCO TO MATCH EXISTING. ALL VOIDS AND CRACKS TO BE EPOINT ORGAINED PRIOR TO PAINTING.
 CLEM AND REPAIR AS NECESSARY ALL EXISTING SIRPACES TO REMAIN INFANITIO.
- IMPAINTS:

 REPLOKE EXISTING SIGNACE TO REMAIN ON BUILDING PRIOR TO PAINTING.

 REPLOKE SIGNACE UPON COMPLETION.

 PRIOR TO PAINTING F ROOF, BUT ALL GUTTER IS GALVANEED MILL BE

 REXIDED TO BE CLEMED WITH BESLAMMI ROOFE MIS BM ON LE

 GREARED PALSETER PER MANEFACTINERS INSTINCTIONS.

 3. Mal-BISTING DISLAMS TO REPLAINT OF EXPANITE OVERTY-MILLION.

- REMOVE ALL EXISTING SMOKER STANDS AND OTHER WALL MOUNTED FIXTURES PRIOR TO PAINTING AND REINSTALLED.
- . DISTING ACCESS PANELS ARE TO BE PAINTED TO MATCH ADJACENT SURFACES.
- IT. REFER TO EXTERIOR FINISH SPECIFICATION ON DRAWING A.O.

		EXTERIOR	FIN	IISHES	
	MATERIAL	COLOUR		MATERIAL	COLOUR
1	* PREFINSHED METAL CAP PLASHING	CHARLOAL GC-16/01/2 OR TO MATCH ADACENT FINISHES: G. 'RON RED'	12	PREFINSHED METAL BASE / THRU WALL PLASHING	CHARCOAL GC-16/012
\vdash		B. BAT WHITE'	13	PREFINSHED METAL BASE / THRU WALL FLASHING (EXISTING)	PAINTED DULUX PAINT MCD 44
2	HORIZONTAL METAL SIDING, ADISO	'CHARCOAL GREY' (GCI6072)		PERSONNE (EXISTING)	
3	4/4 FIBER CEMENT TRIM - SMOOTH = 35" WIDTH	DILLUX PAINT 'CHESTNUT/McGAFE BROWN MCD 9T	и	PERFORATED METAL PANEL SOFFIT - AD300	BNT MHTE'
4	MANUFACTURED STONE C/W SILL	STAINED - NANKAN 'CHARGOAL GREY'	15	METAL PANEL SOPPIT - ADBOO	BUT WHITE,
5	FIBER CEMENT LAP SIDING	DILLIX PAINT 'CHESTNUTMICAFE BROWN MCD 91	16	METAL DOORS & FRAMES (EXISTING) MEDIUM GREY	PAINTED DULUX PAINT MCD 48
6	METAL PANEL - RED	RON RED	п	ALIMINIM STOREFRONT DOORWINDOW FRAMES	CLEAR ANODIZED
7	METAL PANEL / RIBBON - HHTE	BUL WHILE,	В	STEEL COLUMN CHANNEL (EXISTING)	PAINTED TO MATCH DULIX PAINT 'CHESTNUTMcGAFE BROWN MCD BT
8	STUCCO (EXISTING) - MEDIUM GREY	PAINTED DULUX PAINT RESENT GREY MCD 49			BROWN MCD 51
4	MANUFACTURED STONE C/W SILL (EXISTING) - DARK	STAINED - NANKAN 'CHARGOAL GREY'	И	METAL STUCCO REVEALS (EXISTING)	PAINTED TO MATCH ADJACENT SURFACES
1	BRET		20	SIGNAGE	SEE RESPONSIBILITY CHART
ю	ALIMINIM STOREFRONT DOORWINDOM FRAMES (EXISTING)	CLEAR ANODIZED	21	STICCO - DENOTES DOTTED HATCH, TEXTURE TO MATCH EXISTING.	PAINTED DULIX PAINT RESENT GREY MCD 44
Н	WINDOW HEAD (E) & WINDOW SILL (E)	PAINTED DULUX PAINT MCD 44	22	METAL PANEL (EXISTING) - DARK GREY	PAINTED DULUX PAINT HCD 44
	L MATERIALS ARE NEW UNIO.		25	ALIMINUM STOREFRONT DOOR/ HINDOW FRAME (E)	RELOCATED (CLEAR ANODIZED)
- * A	FER TO EXTERIOR FINISHES SPECIFICATIONS ON DMG. ALL MATERIAL FLASHING TO BE 24 GA.	AO.I.	24	GLASS BLOCKS (E)	REMAIN AG IS.
- 98	E COLOURED ELEVATIONS FOR CONFIRM COLOUR.		25	METAL PANEL (EXISTING) - DARK GREY	TO BE PAINTED RON RED' TO MATCH EXISTING.


PROPOSED ELEV. LEGEND:

xx MATERIAL NUMBER EXISTING CLADDING, DOORS, WINDOWS, ETC. TO BE REMOVED

McDonald's Restaurant

10240 - King George Ниу, SURREY, ВС

10240 - King Geo SURREY, BC	где Ниу,	621
	5 & PROPOSED ELEVATIONS	City (Whalley) - 16-021
PROJECT NUMBER	DRAWING NUMBER	−¥
16-021	A2.0	<u>`</u>
SCALE /4" = '-O"	Madys National Number 196	_
APRIL 2016	REVISION SEPT/27/16	Central

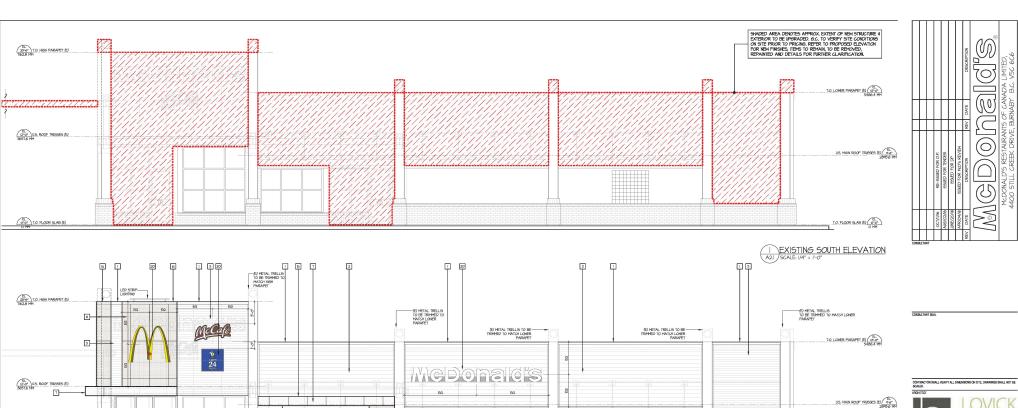

9 8

21



(M)

0

(4)

₩ ₩

3707 1ST AVENUE BURNABY, BC V5C 3V6 ADMIN@LOVICKSCOTT.COM P: 604 298 3700 F: 604 298 6081 MEMBER OF THE AIBC, AAA, SAA, NWTAA & RAIC

2 PROPOSED SOUTH ELEVATION
A21 SCALE: I/4" = I'-0"

9

ELEVATION NOTES:

TO FLOOR SLAB (E)

REFER TO SCOPE OF WORK BEFORE APPLYING ITEMS BELOW.

19 4 23

I M

6

- RETEX TO SOUTH OF MORE REPORE APPLIES TIME BELLOW

 DITEINED WILL LAZONIES SOFTET ALCOHOLE IT, MAGINE KITTED TO BE

 REPORTED, AME TO BE REPORTED AND DEPOZED BY ACE, PRITCH I

 REPORTED AND TO BE REPORTED AND DEPOZED BY ACE, PRITCH I

 REPORTED AND DEPOZED BY ACE, ALLESS MITTED TO BE

 REPORTED AND DEPOZED BY ACE, ALLESS MITTED TO BE

 REPORTED AND DEPOZED BY ACE, ALLESS MITTED TO BE

 REPORTED AND DEPOZED BY ACE, ALLESS MITTED TO BE

 DEPOZED AND DEPOZED BY ACE, ALLESS MITTED TO BE

 DEPOZED AND DEPOZED BY ACE, ALLESS MITTED TO BE

 REPORTED AND DEPOZED BY ACE, ALLESS MITTED TO BE

 REPORTED AND DEPOZED BY ACE, ALLESS MITTED TO PARTISING AND

 REPOZED AND DEPOZED BY ACE, ALLESS MITTED BY ACE

 REPOZED AND DEPOZED AND DEPOZED BY ACE, ALLESS MITTED TO

 REPOZED AND DEPOZED AND DEPOZED AND DEPOZED AND DEPOZED

 REPOZED AND DEPOZED AND DEPOZED AND DEPOZED AND DEPOZED

 REPOZED AND DEPOZED AND

- REPAIR AS REQUIRED ALL DESTRIED DAVISED OF THE HORK.

 G. TO INSTRUCT ALL DESTRIES VARIABLE SINGERS, SEATHING, FRANCIS AND ROLLAND TO DETERMEN FEB. ACCRETA THE LE RECESSARY. F. ANY
 FORTH THE PROPERTY OF THE
- M-GH ALL SURFACES AND REPAIR AS NECESSARY PRIOR TO APPLYING PAINT.
 PAICE ANY DESTRIBO DAMAGED STILLCO TO MATCH DESTRIBO. ALL VOIDS AND CRACKES TO BE EPOXT GRADIED PRIOR TO PAINTING.
 CLEAN AND REPAIR AS NECESSARY ALL DESTRIBO SURFACES TO REMAIN INFAINTED.

(H)

占

ô

1 2 4

卤卤

- INPANIED.

 IR PROVE DESTINE SIGNAGE TO REMAIN ON BUILDING PRIOR TO PANITING, REPLACE SIGNAGE IPON COPPLETON.

 PRIOR TO PANITING FROOT, ROL 4 GUTTER IS GALVANETED MILL BE REQUIRED TO BE CLEMED WITH BELIAMON MODIFIED OF DISCUSSION OF THE PRIMARY CONTRIBETS OF THE CLEMEN BY A CONTRIBED ON THE PANITING SIGNAGE OF THE PRIVATE PRI

- . REMOVE ALL EXISTING SMOKER STANDS AND OTHER WALL MOUNTED FIXTURES PRIOR TO PAINTING AND REINSTALLED.
- 6. EXISTING ACCESS PANELS ARE TO BE PAINTED TO MATCH ADJACENT
- IT. REFER TO EXTERIOR FINISH SPECIFICATION ON DRAWING A.O.

		EXTERIOR	FIN	IISHES	
	MATERIAL	COLOUR		MATERIAL	COLOUR
1	* PREFINSHED METAL CAP FLASHING	CHARCOAL, GC-16/07/2 OR TO MATCH ADACENT FINISHES. a. IRON RED*	12	PREFINSHED METAL BASE / THRU WALL FLASHING	CHARCOAL GC-16012
		b. ENT HHTE	13	PREFINSHED METAL BASE / THRU WALL PLASHING (EXISTING)	PAINTED DULUX PAINT MCD 44
2	HORIZONTAL METAL SIDING, ADISO	'CHARCOAL GREY' (QCI6072)		PLASHING (EXISTING)	
3	4/4 FIBER CEMENT TRIM - SMOOTH = 35" WIDTH	DULIX PAINT 'CHESTNUTMICGAFE BROWN' MCD 3T	14	PERFORATED METAL PANEL SOFFIT - AD300	'BNT WHITE'
4	MANUFACTURED STONE CAN SILL	STAINED - NANKAN 'CHARLOOAL GREY'	15	METAL PANEL SOFFIT - ADBOO	BNI MHIE,
5	FIBER CEMENT LAP SIDING	DULIX PAINT 'CHESTNUT/McGAFE BROWN' MCD ST	16	METAL DOORS & FRAMES (EXISTING) MEDIUM GREY	PAINTED DULUX PAINT MCD 48
6	METAL PANEL - RED	'RON RED'	п	ALIMINIM STOREFRONT DOOR/WINDOW FRAMES	GLEAR ANODIZED
7	METAL PANEL / RIBBON - HHTE	BNT WHITE'	18	STEEL COLUMN CHANNEL (EXISTING)	PAINTED TO MATCH DULIX PAINT CHESTNUTANGAFE BROWN MCD 3T
8	STUCCO (EXISTING) - MEDIUM GREY	PAINTED DULUX PAINT 'REGENT GREY' MCD 49			BROWN MGD 91
4	MANUFACTURED STONE C/M SILL (EXISTING) - DARK	STAINED - NAHKAH 'CHARGOAL GREY'	14	METAL STUCGO REVEALS (EXISTING)	PAINTED TO MATCH ADJACENT SURFACES
	DHET		20	SIGNAGE	SEE RESPONSIBILITY CHART
ю	ALIMINIM STOREFRONT DOOR/HINDON FRAMES (EXISTING)	GLEAR ANODIZED	21	STUCCO - DENOTES DOTTED HATCH, TEXTURE TO MATCH EXISTING.	PAINTED DILLIX PAINT 'REGENT GREY' MCD 44
II	WINDOW HEAD (E) 6 WINDOW SILL (E)	PAINTED DULUX PAINT HCD 44	22	METAL PANEL (EXISTING) - DARK GREY	PAINTED DULUX PAINT HCD 44
	MATERIALS ARE NEW UNIO.		23	ALUMINUM STOREFRONT DOOR/ WINDOW FRAME (E)	RELOCATED (CLEAR ANODIZED)
- * A	ER TO EXTERIOR FINSHES SPECIFICATIONS ON DHG. LL MATERIAL PLASHING TO BE 24 GA.	AO.L	24	GLASS BLOCKS (E)	REMAIN AG IS.
- 983	COLOURED ELEVATIONS FOR CONFIRM COLOUR.		25	METAL PANEL (EXISTING) - DARK GREY	TO BE PAINTED 'RON RED' TO MATCH EXISTING.

D

2

9

PROPOSED ELEV. LEGEND: xx

MATERIAL NUMBER EXISTING CLADDING, DOORS, WINDOWS, ETC. TO BE REMOVED


T.O. FLOOR SLAB (E) (F.O. O. MH


McDonald's Restaurant

10240 - King George Hwy, SURREY, BC

EXISTING & PROPOSED SOUTH ELEVATIONS

PHUSEUI NUMBER	UHWWING NUMBER
16-021	A2.I
SCALE	MICTS NATIONAL NUMBER
/4" = '-O"	1196
DATE	REVISION
APRIL 2016	SEPT/27/16

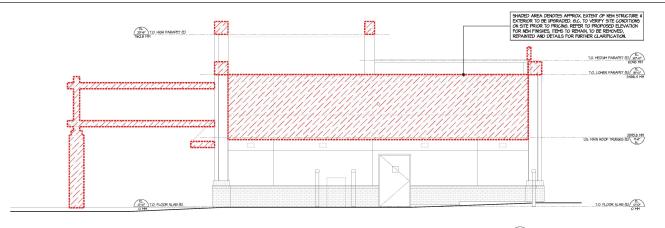

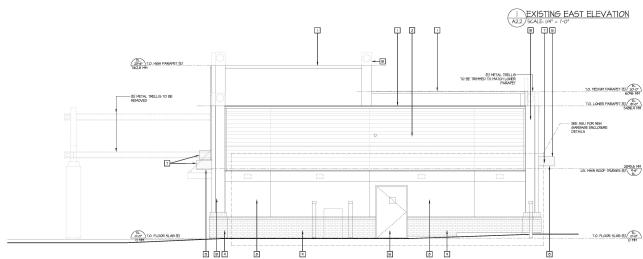

2 PROPOSED EAST ELEVATION SCALE; |/4" = |'-0"

ELEVATION NOTES:

REFER TO SCOPE OF WORK BEFORE APPLYING ITEMS BELOW.

- RETEX TO SCOTE OF MORE EFFORE APPLIED THE BLOCK

 BETTAGEN ALL ACTIONS, STETT ACTIONS IN THE AGEN INTO TO BE

 BETTAGEN ALL ACTIONS, STETT ACTIONS IN THE AGEN

 BETTAGEN AND TO BE RESPONDED THE PROPOSED BY SIG. PRINCIPL

 BETTAGEN AND ACTIONS AND ACTIONS AND ACTION ACTION

 BETTAGEN AND ACTION ACTION ACTION ACTION

 BETTAGEN AND ACTION ACTION ACTION

 BETTAGEN AND ACTION ACTION

 BETTAGEN AND ACTION

 BETTAGEN ACTION

 B
- REPARA AS REQUIRED ALL DESTRIED DAVAGED DE TORH MORKS. GLO TO REPERT ALL DESTRIES VACADE MORKES, SEKANIBIS, FRANCIS AND RELATION TO DETERMENE FERSILACIERTI NAL. DE RECESSARY, F. ANY DESTRICT SERVICE DE STATEMENT DE RECESSARY, F. ANY DESTRIES LAMBATICA FOR REPORTANT REVOLUCIONE. DESTRIES LILLIMANTED SIGNACE 4 SUPPORTS NOTICE DE REPORTED ANY RECURSTRAINE DE LILLIMANTED SIGNACE 4 SUPPORTS NOTICE DE REPORTED DE RECURSTRAINE DE LILLIMANTED SIGNACE 4 SUPPORTS NOTICE DE REPORTED DE RECURSTRAINE DE LILLIMANTED SIGNACE 4 SUPPORTS NOTICE DE NOTICE DE RECURSTRAINE DE LILLIMANTED SIGNACE 5 SUPPORTS NOTICE DE RECURSTRAINE DE LILLIMANTE DE RECURSTRAINE DE LILLIMANTE DE RECURSTRAINE DE LILLIMANTE DE RECURSTRAINE DE
- M-GH ALL SURFACES AND REPAIR AS NECESSARY PRIOR TO APPLYING PAINT.
 PAICE ANY DESTRIBO DAMAGED STILLCO TO MATCH DESTRIBO. ALL VOIDS AND CRACKES TO BE EPOXT GRADIED PRIOR TO PAINTING.
 CLEAN AND REPAIR AS NECESSARY ALL DESTRIPO SURFACES TO REMAIN INPAINTED.
- INPANIED.

 IR PROVE DESTINE SIGNAGE TO REMAIN ON BUILDING PRIOR TO PANITING, REPLACE SIGNAGE IPON COPPLETON.

 PRIOR TO PANITING FROOT, ROL 4 GUTTER IS GALVANETED MILL BE REQUIRED TO BE CLEMED WITH BEHAVIOR MODE MOS BY OL 4 GENERAL BUILDING FROM THE PRIVATE MINERES SIGNAGE FROM THE PRIVATE MINERES SIGNAGE SIGNAGE SIGNAGE FROM THE PRIVATE MINERES SIGNAGE S

- . REMOVE ALL EXISTING SMOKER STANDS AND OTHER WALL MOUNTED FIXTURES PRIOR TO PAINTING AND REINSTALLED.
- EXISTING ACCESS PANELS ARE TO BE PAINTED TO MATCH ADJACENT SURFACES.
- IT. REFER TO EXTERIOR FINISH SPECIFICATION ON DRAWING A.O.

		EXTERIOR	FIN	IISHES	
	MATERIAL	COLOUR		MATERIAL	COLOUR
1	* PREFINSHED METAL CAP FLASHING	CHARCOAL, GC-16/07/2 OR TO MATCH ADACENT FINISHES. a. IRON RED*	12	PREFINSHED METAL BASE / THRU WALL PLASHINS	CHARCOAL GC-16/012
		b. ENT HHTE	13	PREFINSHED METAL BASE / THRU HALL	PAINTED DULUX PAINT MCD 44
2	HORIZONTAL METAL SIDING, ADISO	'CHARCOAL GREY' (GICI6072)		PLASHING (EXISTING)	
3	4/4 FIBER CEMENT TRIM - SMOOTH = 3.5" WIDTH	DULUX PAINT 'CHESTNUTANGGAFE BROWN' MCD 3T	14	PERFORATED METAL PANEL SOFFIT - AD3000	BNI WHITE!
4	MANUFACTURED STONE C/N SILL	STAINED - NANKAN 'CHARLOOAL GREY'	15	METAL PANEL SOFFIT - ADBOO	BNI WHILE,
5	FIBER CEMENT LAP SIZING	DULIX PAINT 'CHESTNUTANGAFE BROWN' MCD 51	16	METAL DOORS & FRAMES (EXISTING) MEDIUM GREY	PAINTED DULUX PAINT McD 48
6	METAL PANEL - RED	RON RED	п	ALIMINIM STOREFRONT DOORANDOW FRAMES	GLEAR ANODIZED
7	METAL PANEL / RIBBON - HHITE	BNL WHILE,	18	STEEL COLUMN CHANNEL (EXISTING)	PAINTED TO MATCH DULIX PAINT CHESTNITAGGAFE BROWN MCD ST
8	STUCCO (EXISTING) - MEDIUM GREY	PAINTED DULIX PAINT 'REGENT GREY' MCD 49			BRUNK HUD 51
4	MANUFACTURED STONE C/N SILL (EXISTING) - DARK	STAINED - NAHKAH 'CHARCOAL GREY'	14	METAL STUCCO REVEALS (EXISTING)	PAINTED TO MATCH ADJACENT SURFACES
	GREY		20	SIGNAGE	SEE RESPONSIBILITY CHART
ю	ALIMINIM STOREFRONT DOOR/HIDDH FRAMES (EXISTING)	GLEAR ANODIZED	21	STICCO - DENOTES DOTTED HATCH, TEXTURE TO MATCH EXISTING.	PAINTED DILLIX PAINT 'REGENT GREY' MCD 44
Ш	WINDOW HEAD (E) 6 WINDOW SILL (E)	PAINTED DULIX PAINT MCD 44	22	METAL PANEL (EXISTING) - DARK GREY	PAINTED DULUX PAINT HCD 44
	MATERIALS ARE NEW UNIO.		23	ALIMINUM STOREFRONT DOOR/ WINDOW FRAME (E)	RELOCATED (CLEAR ANODIZED)
- * A	TER TO EXTERIOR FINSHES SPECIFICATIONS ON DMG. LL MATERIAL PLASHING TO BE 24 GA.	AO.L	24	GLASS BLOCKS (E)	REMAIN AG IS.
- 92	COLOURED ELEVATIONS FOR CONFIRM COLOUR.		25	METAL PANEL (EXISTING) - DARK GREY	TO BE PAINTED 'RON RED' TO MATCH EXISTING.



CONSULTANT SEAL

CONTRACTOR SHALL VERIFY ALL DIMENSIONS ON SITE. DRAWINGS SHALL NOT BE SCALED.



AVENUE 3707 1ST

PROPOSED ELEV. LEGEND:

EXISTING CLADDING, DOORS, WINDOWS, ETC. TO BE REMOVED


MATERIAL NUMBER

xx

McDonald's Restaurant

10240 - King George Ниц. SURREY, ВС

0240 - King George Hw SURREY, BC	y,	-021
ORANNA		-9
EXISTING & PI EAST ELEV		Central City (Whalley) - 16-021
PROJECT NUMBER	DRAWING NUMBER	-≥
16-021	A2.2	Æ
ICALE /4" = '-0"	Maco's National Number 1196	tral
ate APRIL 2016	REVISION SEPT/27/16	_ _ _ _ _ _ _

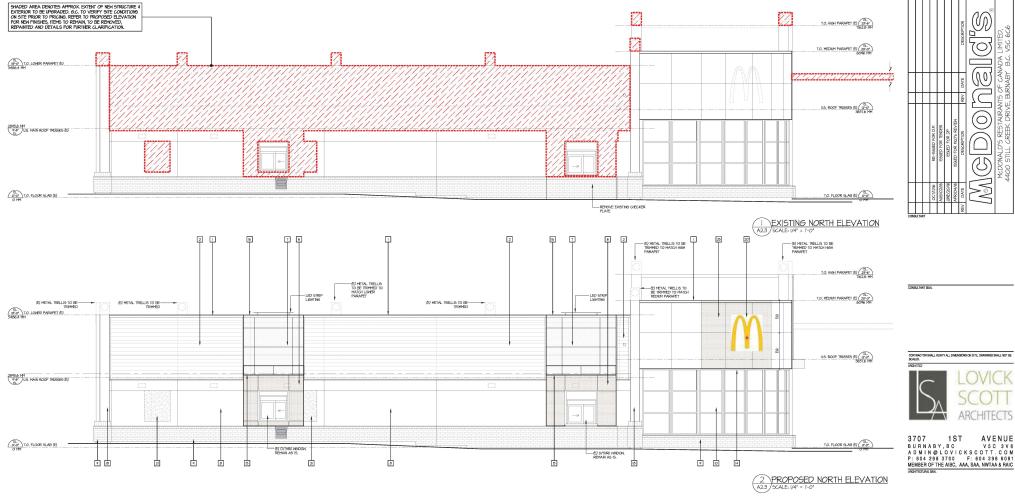

xx

ELEVATION NOTES:

REFER TO SCOPE OF WORK BEFORE APPLYING ITEMS BELOW.

- RETER TO SCOPE OF HORK EEPONE APPLYING INDIG BELOW

 L DITTERS FINAL CLADDING STRIPT CLADDING IT, LABRING MOTED TO BE
 REPOYDED, ARE TO BE REPOYDED AND DEPOYDED BY GL. FINAL IT

 PROVIDED AND THE REPOYDED AND DEPOYDED BY GL. FINAL IT

 DESTROYS HERDONG IN ALMOST AND THE STRIPT OF THE FINAL IT

 DESTROYS HERDONG IN ALMOST AND THE STRIPT OF THE FINAL IT

 DESTROYS HERDONG IN THE STRIPT AND THE STRIPT OF THE FINAL IT

 DESTROYS HERDONG IN THE STRIPT AND THE STRIPT OF THE STRIPT OF THE STRIPT AND THE STRIPT

ı	8. WASH ALL SURFACE PAINT.	es and repair as necessary prior to af	PLYING	1	* PREFINSHED METAL CAP FLASHING	CHARCOAL OCH OR TO MATCH A
ı		IS DAMAGED STUCCO TO MATCH EXISTING. A E EPOXY GROUTED PRIOR TO PAINTING.	ILL VOIDS			a. 'RON RED' b. 'BNT HHITE'
ı		R AS NECESSARY ALL EXISTING SURFACES TO	REMAIN	2	HORIZONTAL METAL SIDING, ADISO	CHARCOAL GRE
ı	UNPAINTED.			3	4/4 FIBER CEMENT TRIM - SMOOTH = 35" WIDTH	DULUX PAINT 'CH
ı	II. REMOVE EXISTING S REPLACE SIGNAGE	SIGNAGE TO REMAIN ON BULLDING PRIOR TO I UPON COMPLETION.	PAINTING.	4	MANUFACTURED STONE CALSILL	STAINED - NAVK
ı		IF ROOF, RHL & GUTTER IS GALVANIZED HIL		5	FIBER CEMENT LAP SIDING	DULUX PAINT 'CH
ı		LEANED HITH BENJAMIN MOORE M65 - BM OIL ER PER MANUFACTURER'S INSTRUCTIONS.		6	METAL PANEL - RED	'RON RED'
ı	IS. ALL DISTING BOLL	ARDS TO REMAIN TO BE PAINTED SAFETY YE	LON:	7	METAL PANEL / RIBBON - WHITE	BUL MHILE,
ı	H. ALL DISTING SOFT	TIS TO REMAIN TO BE PAINTED EXTERIOR OF	ADE WITE	8	STUCCO (EXISTING) - MEDIUM GREY	PAINTED DULUX 1
		TING SMOKER STANDS AND OTHER WALL MOUND PAINTING AND REINSTALLED.	meo	4	MANUFACTURED STONE C/M SILL (EXISTING) - DARK GREY	STAINED - NAME

EXISTING ACCESS PANELS ARE TO BE PAINTED TO MATCH ADJACENT SURFACES.

IT. REFER TO EXTERIOR FINISH SPECIFICATION ON DRAWING A.O.

MATERIAL

COLOUR

1	* PREFINSHED METAL CAP FLASHING	CHARCOAL GC-16072 OR TO MATCH ADACENT FINISHES: a. 'RON RED'	12	PREFINSHED METAL BASE / THRU WALL. PLASHING	CHARCOAL GC-16/012
		b. 'BNT HHITE'	13	* PREFINSHED METAL BASE / THRU WALL	PAINTED DULUX PAINT HCD 44
2	HORIZONTAL METAL SIDING, ADISO	'CHARCOAL GREY' (9CI60T2)		FLASHING (EXISTING)	
3	4/4 FIBER CEMENT TRIM - SMOOTH = 3.5" WIDTH	DULIX PAINT 'CHESTNUTANGGAFE BROWN MGD 3T	14	PERFORATED METAL PANEL SOFFIT - AD300	BKL WHILE,
4	MANUFACTURED STONE C/M SILL	STAINED - NANKAN 'CHARLOOAL GREY'	15	METAL PANEL SOFFIT - ADBOO	BNI WHITE!
5	FIBER CEMENT LAP SIDING	DULIX PAINT 'CHESTNUTANCGAFE BROWN MCD 91	16	METAL DOORS & FRAMES (EXISTING) MEDIUM GREY	PAINTED DULUX PAINT MCD 48
6	METAL PANEL - RED	'RON RED'	п	ALIMINIM STOREFRONT DOOR/WINDOW FRAMES	GLEAR ANODIZED
7	METAL PANEL / RIBBON - WHITE	BNI WHITE,	18	STEEL COLUMN CHANNEL (EXISTING)	PAINTED TO MATCH DULIX PAINT CHESTNIT/McGAFE BROWN MCD ST
В	STUCCO (EXISTING) - MEDIUM GREY	PAINTED DULUX PAINT 'REGENT GREY' MCD 49	1		BROWN MCD 31
4	MANUFACTURED STONE C/M SILL (EXISTING) - DARK	STAINED - NAHKAH 'CHARCOAL GREY'	14	METAL STUCCO REVEALS (EXISTING)	PAINTED TO MATCH ADJACENT SURFACES
	GREY		20	SIGNAGE	SEE RESPONSIBILITY CHART
Ю	ALIMINIM STOREFRONT DOOR/MINDON FRAMES (EXISTING)	GLEAR ANODIZED	21	STICCO - DENOTES DOTTED HATCH, TEXTURE TO MATCH EXISTING.	PAINTED DULIX PAINT RESENT GREY MCD 44
II	HINDOW HEAD (E) 4 WINDOW SILL (E)	PAINTED DULUX PAINT HCD 44	22	METAL PANEL (EXISTING) - DARK GREY	PAINTED DULUX PAINT HCD 44
- ALI	. MATERIALS ARE NEW UNIO.		23	ALUMINUM STOREFRONT DOOR/ WINDOW FRAME (E)	RELOGATED (CLEAR ANODIZED)
	ER TO EXTERIOR FINSHES SPECIFICATIONS ON DWG. LL MATERIAL PLASHING TO BE 24 GA.	AO.L	24	6LASS BLOCKS (E)	REMAIN AG IS.
- 92	COLOURED ELEVATIONS FOR CONFIRM COLOUR.		25	METAL PANEL (EXISTING) - DARK GREY	TO BE PAINTED 'RON RED' TO MATCH EXISTING.

EXTERIOR FINISHES

MATERIAL

COLOUR

PROPOSED ELEV. LEGEND:

MATERIAL NUMBER EXISTING CLADDING, DOORS, WINDOWS, ETC. TO BE REMOVED

1ST

AVENUE

(M)

0

McDonald's Restaurant

10240 - King George Ниц. SURREY, ВС

0240 - King George Hwi SURREY, BC	у,	621
EXISTING & PENORTH ELEV		ılley) - 16-021
PROJECT NUMBER	DRAWING NUMBER A2.3	City (Whalley)
1/4" = 1'-0" DATE APRIL 2016	MED'S NATIONAL NUMBER 1196 REVISION SEPT/217/16	Central







24 24

3 PROPOSED WEST ELEVATION
A24 SCALE: NTS

CONTRACTOR SHALL VERIFY ALL DIMENSIONS ON SITE. DRAWINGS SHALL NOT BE SOALED.

ARCHITECT

3707 1ST AVENUE
BURNABY, BC V5C 3V6
ADMIN @LOVICKSCOTT.COM
P: 604 298 3700 F: 604 298 6081
MEMBER OF THE AIBC, AAA, SAA, NWTAA & RAIC
AGGRICULUSUS


4 PROPOSED NORTH ELEVATION
A2.4 SCALE: NT5

CONSULTANT SEAL

McDonald's Restaurant

SURREY, BC		16-021
	ELEVATIONS	(Whalley) - 1
PROJECT NUMBER	DEMMING NUMBER	<
16-021	A2.4) (j
16-021 SCALE	A2.4	_≅
10 021		_≅
SCALE	Mid'S NATIONAL NUMBER	Sentral City (



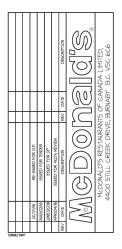

CONTRACTOR SHALL VERIFY ALL DIMENSIONS ON SITE. DRAWINGS SHALL NOT BE SCALED.

ARCHITECT

REAFFECT LO

ARCHITECTS

3707 1ST AVENUE
BURNABY, 8C V5C 3V6
AD MIN @ LO VICK S C OTT. C O M
P: 804 293 3700 F: 864 298 6881
MEMBER OF THE ABC, AAA, SAA, NWTAA & RAIC
AVENTICUAL ME.

RIGHT LOYICK SOUTT ARCHITECTS LTD. THIS MATERIAL IS AN INSTRUMENT INFOE AND RIBMANS AT ALL THINES THE EXCLUSIVE PROPRIETY OF LOYICK T ARCHITECTS LTD. REPRODUCTION OR RELISE IS PROCHRITED WITHOUT THE EEN CONSIST! AND IMME OF LOYICK SCOTT ARCHITECTS LTD. INFORMATION IN IS FOR LISE ON THE DESIGNATED PROJECT ONLY.

RMR PROJECT

McDonald's Restaurant

10240 - King George Ниу, SURREY, ВС

PERSPECTIVES

PROJECT INAMERS

16-021 A 2.5


BOALE


BOALE

MOST TO SCALE

DATE

AFRIL 2016 OCT/11/16

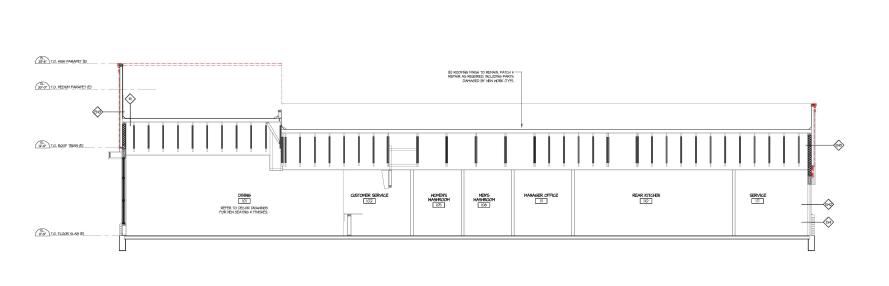

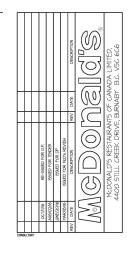

CONTRACTOR SHALL VERIFY ALL DIMENSIONS ON SITE. DRAWINGS SHALL NOT BE SCALED.

ARCHITECT

3707 1ST AVENUE BURNABY, BC . ADMIN & U.OVICKSCOTT. COMP. BO4 298 3700 F: 804 298 6081 MEMBER OF THE AIBC, AAA, SAA, NWTAA & RAIC ADMINISTRATION


McDonald's Restaurant

10240 - King George Ниу, SURREY, ВС

0240 - King George Hwi SURREY, BC	d.	-02
BUILDING SECTI	0N5 A & B	Central City (Whalley) - 16-021
PROJECT NUMBER	DRAWING NUMBER	-≥
16-021	A3.0	É
ICALE /4" = '-0"	Mad'S NATIONAL NUMBER 196	
JUNE 2016	REVISION	- Se

BUILDING SECTION -A

-- DENOTES EXISTING TO BE REMOVED

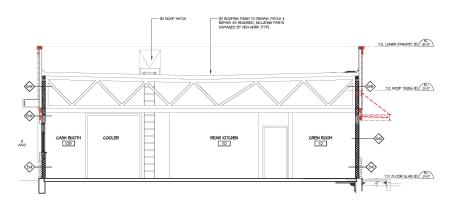

2 BUILDING SECTION -B A3.0 SCALE: 1/4" = 1"-0"

					7	ens m	TILLIAN	ISNO
		REV	2	0	F	,,	NWITT	ISNO
	<u></u>	DATE	AUG/02/16	ОСТЛИ6				
McDONALD'S RESTAURANTS OF CANADA LIMITED, 4400 STILL CREEK DRIVE, BURNABY B.C. V5C 6C6		DESCRIPTION	ISSUED FOR TENDER	RE-ISSUED FOR D.P.				
TS OF		REV D	L	H	L	H	L	H
ABA CAN	[00]	DATE						L
IADA LIMITED, B.C. V5C 6C6	1105	DESCRIPTION						

S BULDING SECTION -C , NEW CONCRETE SLAB 4 FOUNDATION, SEE STRUCTURAL DWGS. (9) BAJR 900.H OT (9-0) MEM FLOOR TILES. REFER TO DECOR DRAWINGS FOR NEW SEATING & FINISHES. ANTIOR MAEPHALE CREEM WR 35**ASORAGE** DINING CREW ROOM EXECUTED, SEE ALD 4 ALL 96E ID DMGG" - NEM CEITING JITES 943 (3) SEURT 100R O.T (10-12) ***** ⊗ Γ≱V G TO, HEDSIAN PARAMET (E) — (E) BOOFING FINISH TO REPAIN PATCH I REPAIR AG REGUIRED, INCLLDING PARTS TAMAGED BY NEW HORK (TYP). — 66 TO CONFIRM ROOF INSTALLATION ON EXISTING ROOF (E) TSPARAM HOH OT (NEX (3) TSPANSANG HOH. Q.T. (%- KE.)

Central City (Whalley) - 16-021 NOISIABLE BTA3 |/4" = "}\| BTA3 961 BERATIN TANOLLYN SCRW I.EA 120-91 PROJECT NUMBER BULLPING SECTIONS C OS40 - KING GEORGE HMY.

McDonald's Restaurant

STORITECTS

SCATED, CONTRACTOR SHALL VEHEY ALT DIMENSIONS ON SITE, DRAWINGS SHALL NOT BE

CENOMER SELOT ENTREMS SETONED.

Мс	Donald's PLANT LIST BOTANICAL NAME TREES	COMMON NAME	CAL.	SIZE	COND	MATURE HEIGHT (m)	MATURE SPREAD (m)	O.C. SPACING (m)	QNTY.
Pa	Planantus acertolia x 'Bloodgood'	London Plane Tree	70mm		20 gal.	25	20	5.0	2
	SHRUBS AND PERENNIALS								
Cg	Cotinus 'Grace'	Grace Smoke Tree		60cm	3 gal.	2.0	2.0	1.0	- 4
Bg	Boxus 'Green Gem'	Green Gem Boxwood		30cm	3 gal.	0.6	0.6	0.5	36
Yf	Yucca fiscoids 'Golden Sword'	Golden Sword Yucca		60cm	3 gal.	1.2	1.2	1.0	8
88	Artemesia stelleriana 'Boughton Silver'	Boughton Silver Wormwood			1 gal.	0.2	0.6	0.5	17
SILI	Arctostaphylos uva ursi Vancouver Jade	Bearberry			1 gal.	0.1	0.3	0.5	120
pm	Polystichum munitum	Western Sword Fern			2 gsl.	0.9	0.9	0.5	120

LANDSCAPE NOTES:

- LANDSCAPE NOTES:

 NETILAL PLANTED HAND TO MAKE FOR ETHANDES INFO DE MO RETALIAL PART MATERIA IN AUCCIONANCE WITH DELIARCINA LANDSLAVE ETHANDES. LATEST COTTOM AREA OF EACH RETIRED CONTINUA AND THAT MAY DELIAR TO BE REMATED THAN AND THAT MAY DELIAR TO BE REMATED WITH AN AUTOMATE OF CENTROLINO, ALL PLANT WATERA TO BE REMATED WITH AN AUTOMATE OF CENTROLINO, ALL PLANT WATERA TO BE REMATED WITH AN AUTOMATE OF CENTROLINO, ALL PLANT WATERA TO BE REMATED WITH AN AUTOMATE OF CENTROLINO, ALL PLANT WATERA TO BE REMATED WITH AN AUTOMATE OF CENTROLINO STETEM AND THE LANDSCAPE OF CENTROLINO.

 1. REPORT WAY CHANGES DESCRIPTION TO SETTEM AND EXCHANGE AND THAT WAS AUTOMATED AND THE AUTOMATED AUTOMATED AND THE AUTOMATED AUTOM

- MATINE BET OF PLANT INITITIES.

 13. ALL SPROOF POTENTIAL WAS THE SERVING BY THE CONTRACTOR AT TIME OF FINAL
 ACCEPTACE, NO SECTION WAS ARE PREVENTED TO COMPLETE THEIR WOOK.

 OF THIS WAS ARE SECTION OF THE PLANT OF THE WAS AND AND AND AND ADDRESS.

 IN SUPER Y AND PLACE SECTION ACCORDINACY WITH DISS 2013 75 TO AN ANNUAL DEFTH

 15. SUPER Y AND PLACE SECTION ACCORDINACY WITH DISS 2013 75 TO MATERIS OTHERWISE.

 15. SUPER Y AND PLACE SECTION ACCORDINACY WITH DISS 2013 75 TO MATERIS OTHERWISE.

 16. SUPER Y AND PLACE SECTION ACCORDINACY WITH DISS 2013 75 TO MATERIS OTHERWISE.

 17. SUPER Y AND PLACE SECTION ACCORDINACY WITH DISS 2013 75 TO MATERIS OTHERWISE.

 18. SUPER Y AND PLACE SECTION ACCORDINACY WITH DISS 2013 75 TO MATERIS OTHERWISE.

 19. SUPER Y AND PLACE SECTION ACCORDINATION.

 17. FOR CONTRACTOR AND SECTION ACCORDINATION.

 18. CONTRACTOR TO PROVIDE MANUAL WAS AND ACCORDINATION.

 19. SUPER Y AND PLACE SECTION ACCORDINATION.

 19. SUPER Y AND PLACE SECTION ACCORDINATION.

 10. ALL WOOK IN LAKE SECTION ACCORDINATION.

 10. ALL WOOK IN LAKE SECTION ACCORDINATION.

 10. ALL WOOK IN LOCATION.

 11. SUPERVISION ACCORDINATION.

 12. SUPPRIVATE OF LOCATION ACCORDINATION.

 13. SUPERVISION ACCORDINATION.

 14. SUPPRIVATE ACCORDINATION.

 15. SUPPRIVATE ACCORDINATION.

 16. SUPPRIVATE ACCORDINATION.

 16. SUPPRIVATE ACCORDINATION.

 17. SUPPRIVATE ACCORDINATION.

 18. SUPPRIVATE ACCORDINATION.

 18. SUPPRIVATE ACCORDINATION.


 18. SUPPRIVATE ACCORDINATION.


 18. SUPPRIVATE ACCORDINATION.

 19. SUPPRIVATE ACCORDINATION.

 19



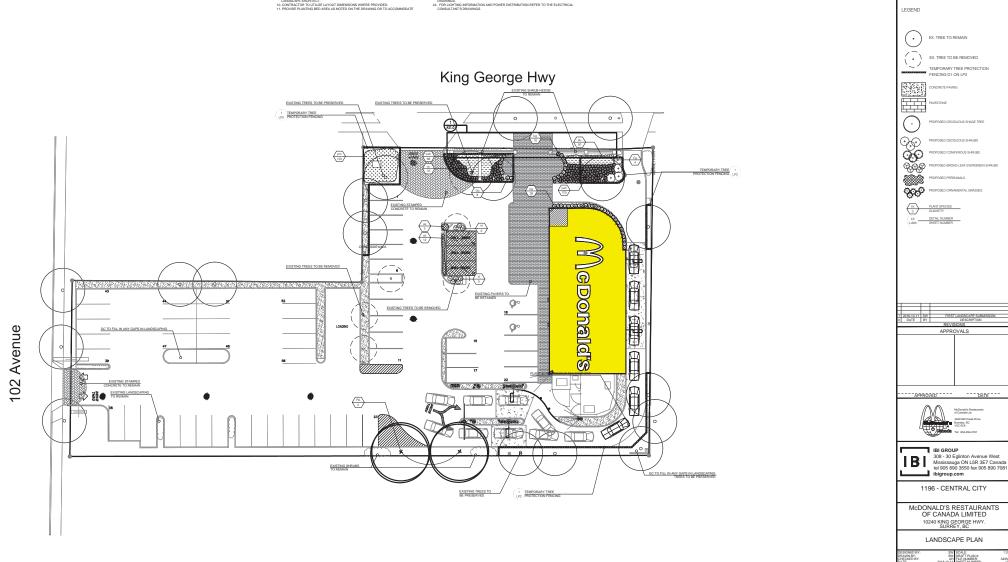

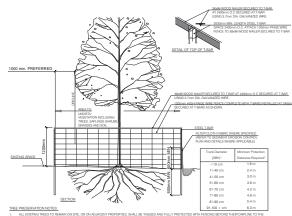



ALL DESTRUCTINES TO REMAIN ON SITE, OR ON AUGUSTS PROPERTIES, BYALL SET FACISED, NON-FLLY PROTECTED WHITE PERCHAS SERVICED THER DRIVEN TO FOR A DESTRUCTION OF THE PERCHAS DESTRUCTION

- 2. FENCES SHALL BE LOCATED AT A MINIMUM OF 0.5 TIMES THE CROWN RADIUS OF THE TREE FROM THE DRIPLINE, 560 DEGREES AROUND THE PERIMETER OF INDIVIDUAL OR
- AREAS WITHIN THE TREE PROTECTION ZONE SHALL NOT BE USED FOR THE STORAGE OF BULLDING MATERIALS, STRUCTURES OR EQUIPMENT. THIS TREE PROTECTION ZONE SHALL BE COMPLETED PRIOR TO THE COMMENCEMENT OF SITE CLEARANCE, DEMOLITION, OR ANY TYPE OF CONSTRUCTION.
- SURPLUS SOIL, EQUIPMENT, VEHICLES, TOOLS, DEBRIS OR MATERIALS SHALL NOT BE PLACED OVER THE ROOT SYSTEMS OF THE TREES WITHIN THE TREE PROTECTION
 ZONE. NO CONTAMINANTS SHALL BE DUMPED OR FLUSHED WHERE FEEDER ROOTS OF TREES EXIST.
- EQUIPMENT SHALL NOT COMPACT SOIL OVER THE ROOT ZONE OF EXISTING TREES, TO AVOID DAMAGE TO TREES THAT AREA TO BE PROTECTED, ACCESS ROUTES MUST BE ESTABLISHED AWAY FROM PROTECTED AREAS, ALL ACCESS ROUTES REQARDLESS OF HOW TEMPORARY, MUST BE IDENTIFIED AND APPROVED BY THE CITY.
- WRITTEN PERMISSION MUST BE DISTAINED FROM THE CITY PRIOR TO COMMENCING WORK SUCH AS TUNNELING, TORPEDDING, DIGGING OR TRENCHING WITHIN THE DRIPLINE OF PARY TREE TO MINIMIZE ROOT INJURY AND AVOID SOIL COMPACTION.
- WHEREVER POSSIBLE AVOID CUTTING SURFACE ROOTS, DURING EXCAVATION F ROOT CUTS ARE NECESSARY, IT SHOULD BE DONE QUICKLY, MAKING FLUSH CLITS WHILE SUPERWISED BY AN INSPECTING ONLY PORESTRY REPRESENTATIVE. THE ROOTS SHALL BE BACKFILLED AND WITEFED BEFORE THEY HAVE A DIANCE TO DIFF OUT, WHERE ROOTS REQUIRE REMOVALL, THERE MAY BE A BUSEPLOKENT DECEMBER WHITH THE TEST CANCEY. BRANCHES SHOULD DIALY BE REMOVED TO BESTACK COLIFS.
- 9. WHERE LIMBS OR PORTIONS OF TREES ARE DAMAGED OR MUST BE REMOVED FROM CITY OWNED TREES TO ACCOMMODATE CONSTRUCTION WORK, CITY FORESTRY PERSONNEL IN ACCORDANCE WITH ACCEPTED ARBORICULTURE PRACTICES, WILL REMOVE THE MEASURES SHALL BE TAKEN TO PREVENT ANY FURTHER DAMAGE.
- 10. BALES AUTORIZES ALL REPORTALES SHALL AREA GENERAL OFFICIAL DEVICES PROJECT FOR A REPORT THE TIER FRONCISCION DOCUMENTO AND AND ADMINISTRATION OF A REPORT OF A
- 11. NO CABLES, ROPES SHALL BE WRAPPED AROUND OR INSTALLED IN OR ON ANY TREE THAT IS TO REMAIN AFTER CONSTRUCTION, NOR SHALL IT HAVE SIGNS OR FENCES NAILED TO IT, OR SURKEY MARKINGS OR PAINT APPLIED TO IT.
- 12. ALL VEGETATION WITHIN THE TREE PROTECTION 2011E, INCLUDING TREES, SHRUBS, GRASSES ARE TO BE WATERED, AND MAINTAINED TO AN ACCEPTABLE LEVEL AS REQUIRED.
- 13. THE CITY SHALL BE NOTIFIED TO INSPECT ALL TREE PROTECTION ZONES. THESE MEASURES SHALL REMAIN IN EFFECT LINTIL THE COMPLETION OF THE WORK, AT WHICH TIME AUTHORIZATION FROM THE CITY MUST BE OBTAINED BEFORE REMOVAL.
- 14. THE CITY MUST BE NOTIFIED IMMEDIATELY WHEN ANY MUNICIPALLY OWNED TREE IS INJURED OR DESTROYED DURING CONSTRUCTION OR DEVELOPMENT.
- 15. ALL CONSTRUCTION WITHIN TREE PROTECTION FENCING IS TO BE HAND-WORKED IND MACHINERY) IN ACCORDANCE WITH THE VEGETATION MANAGEMENT HOTATION PROVIDED WITH THE TEMPORARY FENCING DETAIL CONSULT WITH A QUALIFIED ARBORRET PRICE TO COMMENCEMENT OF WORKS WITHIN THE TIESE PROTECTION.






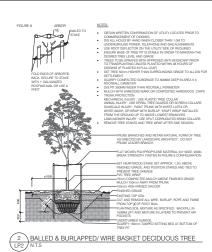

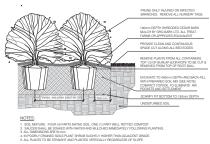


3 BALLED AND BURLAPPED/POTTED SHRUB

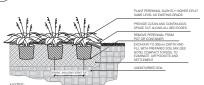

- 1. SOLL MATURE: FOUR (4) PARTS NATIVE SOIL, ONE (1) PART WELL ROTTED COMPOST.
 2. SAUCER SHALL BE SOAKED WITH WATER AND MULCHED IMMEDIATELY FOLLOWING PLANTING.

4 CONTAINER GROWN PERENNIAL/GRASS N.T.S.

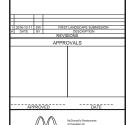



308 - 30 Eglinton Avenue West Mississauga ON L5R 3E7 Canada tel 905 890 3550 fax 905 890 7081 ibigroup.com

1196 - CENTRAL CITY

McDONALD'S RESTAURANTS OF CANADA LIMITED 10240 KING GEORGE HWY. SURREY, BC

LANDSCAPE PLAN