

City of Surrey PLANNING & DEVELOPMENT REPORT File: 7911-0141-00

Planning Report Date: March 12, 2012

PROPOSAL:

• Development Variance Permit


in order to permit the construction of a 44.2 metre (145 ft.) free-standing telecommunication tower.

LOCATION: 4121 King George Boulevard

OWNER: Surrey Topsoil Ltd., Inc. No. 403047

ZONING: A-1

OCP DESIGNATION: Agricultural LAP DESIGNATION: Agricultural

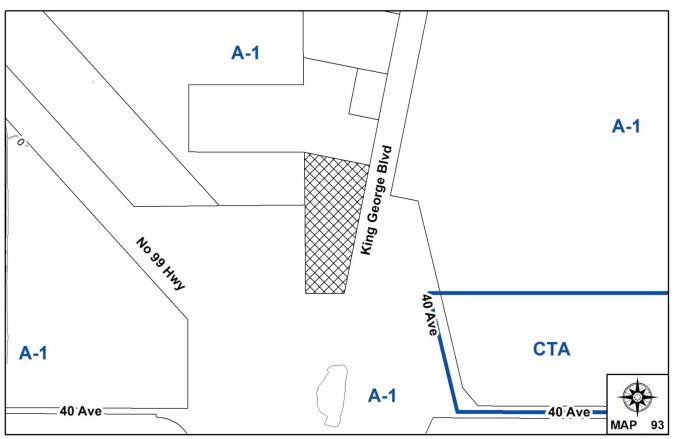

RECOMMENDATION SUMMARY

- Denial of the Development Variance Permit.
- Should Council determine that there is merit in allowing the proposal to proceed, the
 application should be referred back to staff for additional design review and Public
 Information Meeting.

DEVIATION FROM PLANS, POLICIES OR REGULATIONS

The applicant is requesting a variance to increase the height of a free-standing telecommunications tower from 12 metres (40 ft.) to 44.2 metres (145 ft.).

RATIONALE OF RECOMMENDATION

- The proposed monopole is located within 100 metres of a significant BC Hydro transmission tower. The applicant has not been receptive to locating telecommunication equipment on the existing BC Hydro transmission towers located near the proposed tower site.
- Although the proposal is sited in an agricultural area, it is located in close proximity to the Peace Arch RV Park to the east (across King George Boulevard).
- The proposed variance has triggered significant public opposition.
- The capacity issues that have been shown to exist for two carriers in the area may be resolved through installations on existing structures in the area, such as the BC Hydro transmission towers.
- The proposed tower is located in an open area and is highly visible.

RECOMMENDATION

The Planning & Development Department recommends that this application be denied.

Should Council determine that there is merit in allowing the proposal to proceed, the application should be referred back to staff for additional design review and Public Information Meeting.

REFERRALS

Engineering: The Engineering Department has no objection to the proposed

Development Variance Permit (DVP) and there are no additional engineering requirements relative to the issuance of the DVP.

Ministry of Transportation & Infrastructure (MOTI):

The Ministry of Transportation and Infrastructure has no

objections to the project.

Agricultural Advisory Committee (AAC):

The proposed DVP proceeded to the AAC for information only on February 9, 2012. There were no comments related to this proposal. Telecommunications equipment is a permitted use in ALR land, as long as the site is confined to an area no greater than 100 square

metres (1,076 sq.ft.).

SITE CHARACTERISTICS

<u>Existing Land Use:</u> Existing temporary Cell on Wheels (COW) telecommunication structure,

otherwise vacant. Fill has been placed on-site without permit.

Adjacent Area:

Direction	Existing Use	OCP Designation	Existing Zone
North:	Existing blueberry farm, with	Agricultural	A-1
	associated farm buildings.		
East (Across King George	Small parking lot on the King	Agricultural	A-1
Boulevard):	George Boulevard and 40 th		
	Avenue right-of-way.		
South:	Highway No. 99 interchange.	Agricultural	A-1
West:	BC Hydro Utility Corridor.	Agricultural	A-1

APPLICANT'S JUSTIFICATION FOR THE PROPOSED LOCATION

- There is a demonstrated need for increased capacity for two carriers (Mobilicity and Wind) in this area.
- The subject site is located in a non-residential area and is surrounded by agricultural lands, some of which are being actively farmed and others which are being used to accommodate transportation and Hydro infrastructure.
- The proposed monopole will be situated near the south west property line, near the adjacent BC Hydro transmission corridor.
- The proposed monopole is located within 100 metres of a BC Hydro Transmission tower. The City's *Telecommunication Towers Policy* states that, whenever possible, locate proposed telecommunication equipment on existing structures within a radius of 500 metres (1,640 ft.) of the proposed monopole location.
- The site is proposed to be developed as a co-location site to accommodate two new service providers, thereby minimizing the number of installations required to service the area.

DEVELOPMENT CONSIDERATIONS

Background/Proposal

- The subject site, at 4121 King George Boulevard, is zoned General Agricultural Zone (A-1), designated Agricultural in the Official Community Plan (OCP), and within the Agricultural Land Reserve (ALR). The subject property is approximately 2.03 hectares (5.01 acres) in size.
- The property owner has granted authorization to SBA Canada, ULC., to apply for a Development Variance Permit (DVP) application to increase the maximum height of a free-standing telecommunication tower from 12 metres (40 ft.) to 44.2 metres (145 ft.).
- SBA Canada, ULC. is a Third Party provider of wireless communications facilities. The
 company develops, owns and manages the facilities and leases space on its towers to
 various wireless carriers.
- The proposal is for a galvanized steel monopole installation with ancillary equipment cabinets at the base of the mast. The installation is to be located within a 10-metre (33 ft.) by 10-metre (33 ft.) fenced compound at the south west corner of the subject property.
- The applicant has provided written confirmation that two carriers are willing to co-locate on this structure: Mobilicity and Wind. The proposed structure can accommodate up to 4 carriers.
- The applicant has indicated that Mobilicity and Wind require a site in this area due to the considerable vehicular traffic and a growing base of residents and businesses in the area.

• The current proposal is to provide improved coverage and capacity for an area generally bounded by the Serpentine river to the north, the Nicomekl River to the south, the Pacific Ocean to the west, and 160 Street to the east (see Appendix III).

City's Telecommunication Tower Policy

- A City policy on telecommunication towers was developed in conjunction with wireless providers and approved by Council on June 18, 2001 (Policy O-49 Telecommunication Towers). The policy provides parameters on how the towers should be sited and designed.
- The following is an evaluation of the current tower proposal in relation to Policy O-49:

Location and Siting

 When considering the siting of telecommunication tower facilities, every effort should be made to locate new equipment on existing structures such as Hydro transmission line towers, utility poles, roof tops, etc.

The proposed monopole is located within 75 metres of a significant BC Hydro transmission tower corridor.

The applicant has indicated that wireless carriers are not able to locate on the existing BC Hydro transmission tower due to safety concerns. There are many examples in Surrey, however, where telecommunication antennae are mounted atop BC Hydro transmission towers with no negative safety impacts.

Another carrier has installed telecommunication equipment atop the BC Hydro tower located closest(± 75 metres) to the proposed monopole location. Approximately 100 metres from the proposed monopole location is a second BC Hydro transmission tower which could accommodate an additional carrier (Wind or Mobilicity). The BC Hydro transmission tower corridor contains many transmission towers and therefore presents many opportunities for structures upon which telecommunication providers can locate their equipment. The range of coverage provided by the proposed 45.7 metre monopole is larger than the range that can be achieved on the shorter (± 25 metre) BC Hydro transmission towers, thereby requiring the carriers to install multiple antennae on multiple towers. This is not the preferred option of the carriers for economic reasons.

- It is preferable that the new free-standing telecommunication towers be sited in nonresidential locations and preferably in industrial areas.
 - Although the proposal is sited in an agricultural area, it is located in close proximity(± 250 metres) to the Peace Arch RV Park to the east (across King George Boulevard).
- o Towers on prominent natural and cultural features, environmentally sensitive areas or areas with historically significant buildings are discouraged.

The proposed location is located out in the open and not near any significant cultural, environmental or historic areas. However, the proposed tower is located in an open area and is highly visible.

 New free-standing telecommunication towers should be located at a distance from the edge of an existing or future road allowance no less than the height of the tower.

The telecommunications facility is proposed to be located approximately 45 metres (147.6 ft.) from King George Boulevard, which is slightly more than the proposed 44.2 metre (145 ft.) tower height. The proposed location utilizes an existing driveway and the applicant has received approval for access from the Ministry of Transportation and Infrastructure.

o Location of telecommunication towers on sites with mature trees is encouraged.

The proposed tower is not located near any significant tree stands.

O All applicants for free-standing telecommunications structures will be requested to identify any other structure (i.e. Hydro transmission line towers, existing telecommunication towers, etc.) within a radius of 500 metres (1,640 ft.) from the proposed location and to provide reasons why other existing structures within that radius are not acceptable for use (i.e. structural capabilities, safety, available space or failing to meet service coverage needs).

As noted above, the applicant has indicated that the BC Hydro transmission tower located approximately 100 metres from the proposed monopole is not acceptable due to safety concerns. Staff reiterates that there are many examples in Surrey where telecommunication antennae are mounted atop BC Hydro transmission towers with no negative safety impacts.

Another carrier has installed telecommunication equipment atop the BC Hydro tower located closest(\pm 75 metres) to the proposed monopole location. Approximately 100 metres from the proposed monopole location is a second BC Hydro transmission tower which could accommodate an additional carrier (Wind or Mobilicity). The BC Hydro transmission tower corridor contains many transmission towers and therefore presents many opportunities for structures upon which telecommunication providers can locate their equipment. The range of coverage provided by the proposed 44.2 metre (145 ft.) monopole is larger than the range that can be achieved on the shorter (\pm 25 metre) BC Hydro transmission towers, thereby requiring the carriers to install multiple antennae on multiple towers. This is not the preferred option of the carriers for economic reasons.

Co-location

 The carriers and other telecommunication tower owners are encouraged to work cooperatively in reaching agreements which allow for sharing of tower structures so as to minimize the total number of towers in the City. This practice is typically referred to as "co-location".

The applicant has provided written confirmation from Mobilicity and Wind of their interest to co-locate on the monopole. Based on the proposed 44.2 metre (145 ft.) height, the proposed monopole could accommodate up to four carriers.

Tower Design

Towers and ancillary equipment shelters will be designed to fit their surroundings and to minimize their visual impact on surrounding properties.

- The use of monopoles is encouraged. Where a tower is being constructed to accommodate a single user, a monopole design is required.
- Landscaping shall be appropriately placed around a telecommunication tower and ancillary facilities, such as equipment shelters, to minimize their visual impact on the neighbourhood.

The applicant is proposing a monopole design with ancillary equipment shelters at the base, which will be screened by a chainlink fence complete with green slats and surrounded with shrubs.

PRE-NOTIFICATION

Pre-notification letters were sent by the applicant on or about December 9, 2011. The applicant mailed letters to an area encompassing 6 times the height of proposed tower (274 metres/899 feet).

As a result of the applicant's mail out, staff received 5 e-mail responses and 2 phone calls, along with a petition, all in opposition to the proposed telecommunications tower. The petition represented 59 residents (from the Peace Arch RV Park at 14601 40 Avenue).

The concerns raised by area residents are as follows:

- Health effects related to the radiofrequency of the proposed tower.
- The impact of the radiofrequency of the proposed tower on pollinator species.
- The impact of the proposed tower and ancillary equipment on farming.
- The impact of the proposed tower on the adjacent farms (casting shadow on light-sensitive crops).
- The impact of the proposal on property values.
- Increasing the magnitude of non-farm uses on the subject site.
- The visual impact of the proposed tower on the area which is viewed as the "gateway to South Surrey".
- Concerns about the public process and ability to provide comments.
- Concerns that the subject site is already being prepared for the proposed tower (a significant amount of fill has been brought onto the site without a permit).

The applicant has not held a Public Information Meeting (PIM) to date.

The applicant has provided the following responses to the concerns:

Concern about the health effects.

The site will operate within Industry Canada and Health Canada regulations. Industry Canada prohibits health concerns as a reason for denying a tower location.

• Concern about the visual impact.

The compound, equipment and structures will be enclosed within a chainlink fence with green slats and will be surrounded with shrubs.

Concern about the loss of farm land.

The leased area of the site is 10 x 10 metres and occupies an area of the site that is not currently used for agricultural production.

Concern about the impact on property values.

Evidence suggests that property values are not impacted by the proximity of a telecommunications facility.

• Concern about the public process.

SBA Canada ULC. has followed the City of Surrey's Policy (0-49): Telecommunication Towers. In addition, Industry Canada requirements related to public notification have been followed.

BY-LAW VARIANCE AND JUSTIFICATION

(a) Requested Variance:

• To vary the Zoning By-law to increase the maximum height of a free-standing telecommunications tower from 12 metres (40 ft.) to 44.2 metres (145 ft.).

Applicant's Reasons:

- The applicant has submitted some information to demonstrate that there are capacity issues in the area, which a proposed telecommunication structure would assist in resolving.
- The proposed tower will provide co-location opportunities for at least two wireless carriers and could provide an opportunity for two more.

Staff Comments:

- The proposed variance has triggered significant public opposition.
- The capacity issues that have been shown to exist for two carriers in the area may be resolved through installations on the nearby BC Hydro transmission towers.

• The applicant has not been receptive to locating telecommunication equipment on the existing BC Hydro transmission towers located near the proposed tower site.

PROJECT EVALUATION

The following is a summary of the benefits and concerns of supporting the proposed telecommunication tower application:

Pros

- The proposed site addresses wireless coverage and capacity issues in this area of Surrey
 and responds to the increasing consumer demand for wireless services and in particular,
 the ever-growing demand for data transmission. This site is particularly critical for the
 new carriers (Mobilicity and Wind Mobile) who are building their networks.
- The site is being developed as a co-location site to accommodate up to four carriers, therefore minimizing the number of towers required to service the area.
- The proposed site is located in a non-residential location.
- The applicant is proposing a monopole design.

Cons

- Although the site is located in an agricultural area, it is located in close proximity to a large RV Park (Peace Arch RV Park).
- There is no reasonable rationale for why telecommunication equipment cannot be located on the BC Hydro transmission towers located near the proposed tower site.
- The neighbouring residents have been very vocal in their opposition to the proposed telecommunications tower citing a number of concerns including detrimental health effects, loss of productive farm land, and impact on adjacent farms.

RECOMMENDATION SUMMARY

The Planning & Development Department recommends that this application be <u>denied</u>.

Should Council determine that there is merit in allowing the proposal to proceed, the application should be referred back to staff for additional design review and Public Information Meeting.

INFORMATION ATTACHED TO THIS REPORT

The following information is attached to this Report:

Appendix I. Lot Owners, Action Summary

Appendix II. Proposed Site Plan and Building Plans

Appendix III. Coverage Map

Appendix IV. Development Variance Permit No. 7911-0141-00

original signed by Nicholas Lai

Jean Lamontagne General Manager Planning and Development

TH/kms

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Information for City Clerk

Legal Description and Owners of all lots that form part of the application:

1. (a) Agent: Vanessa Cartwright Name:

Scott Telecom Services Inc. Suite 900 - 202 6th Avenue SW Address:

Calgary, AB T2P 2R9

Tel: 403-261-1000

Properties involved in the Application 2.


> 4121 King George Boulevard (a) Civic Address:


(b) Civic Address: 4121 King George Blvd


Surrey Topsoil Ltd., Inc. No. 403047 Owner:


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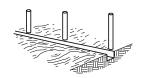
Lot 1 District Lot 161 Group 2 New Westminster District Plan 10071



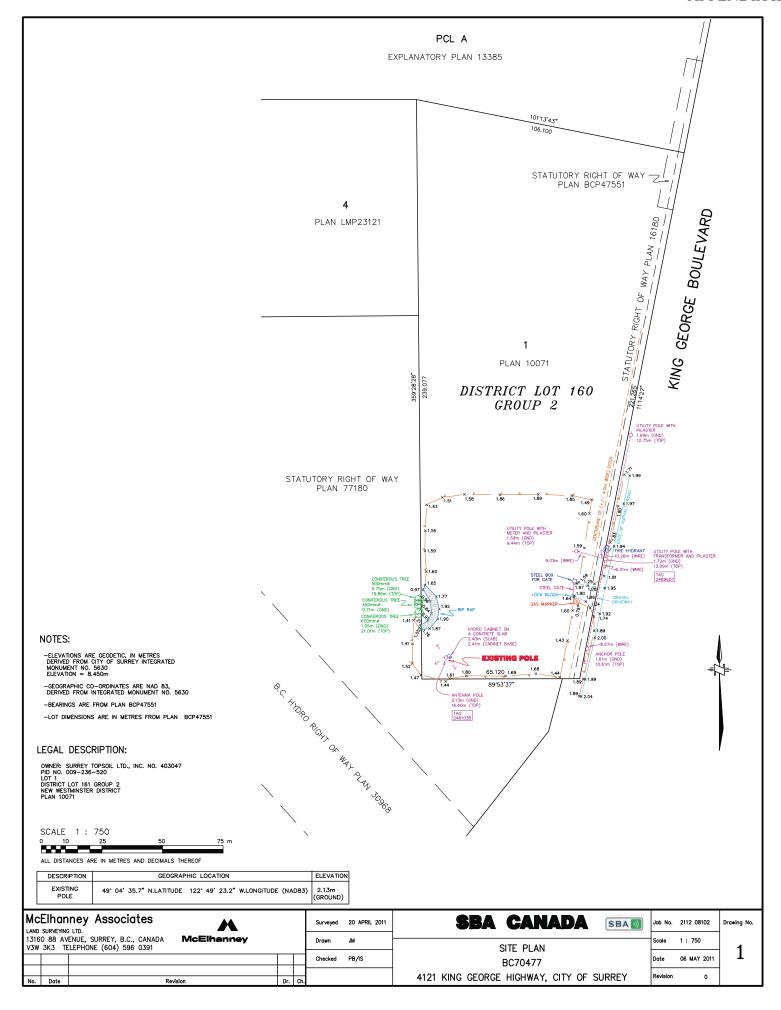

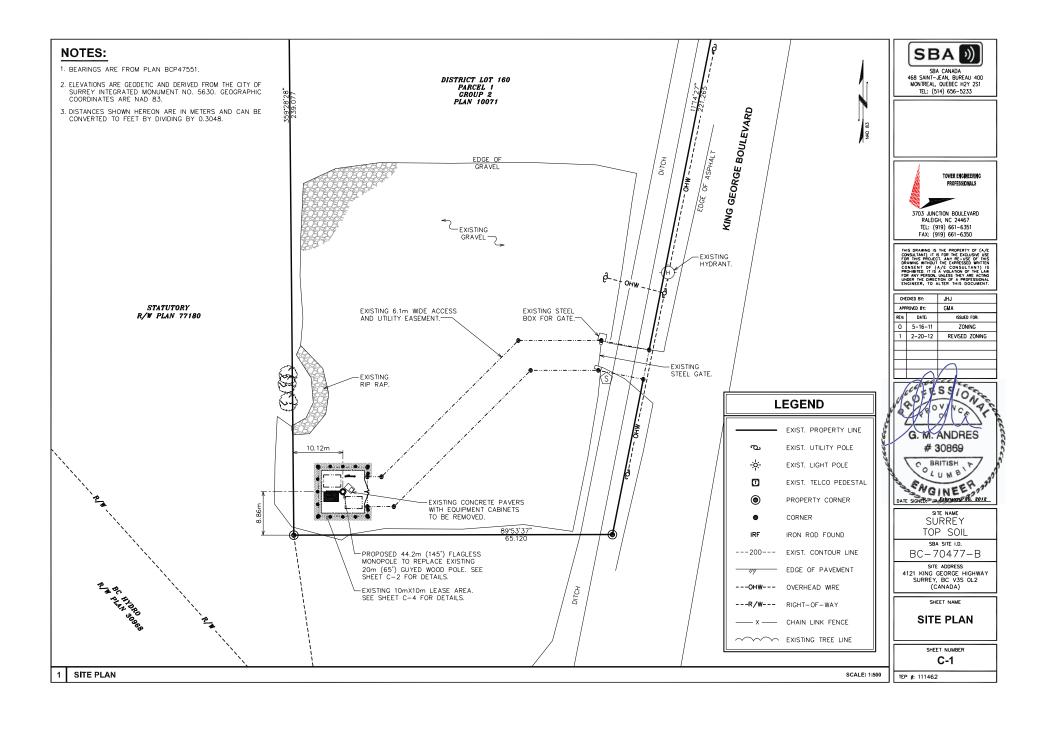


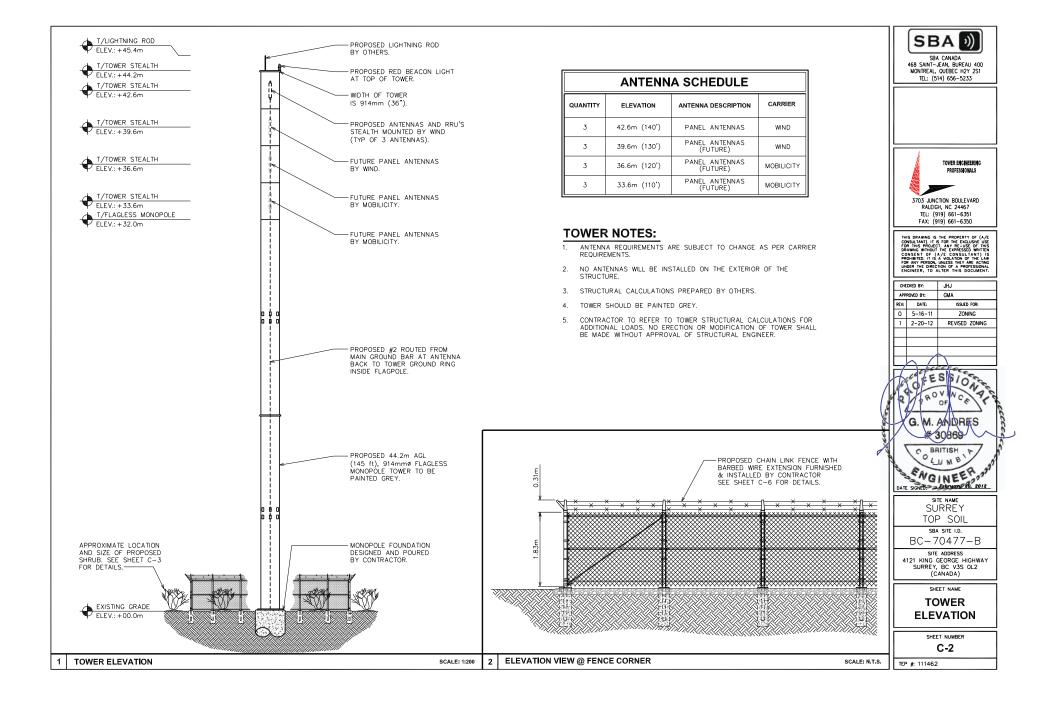

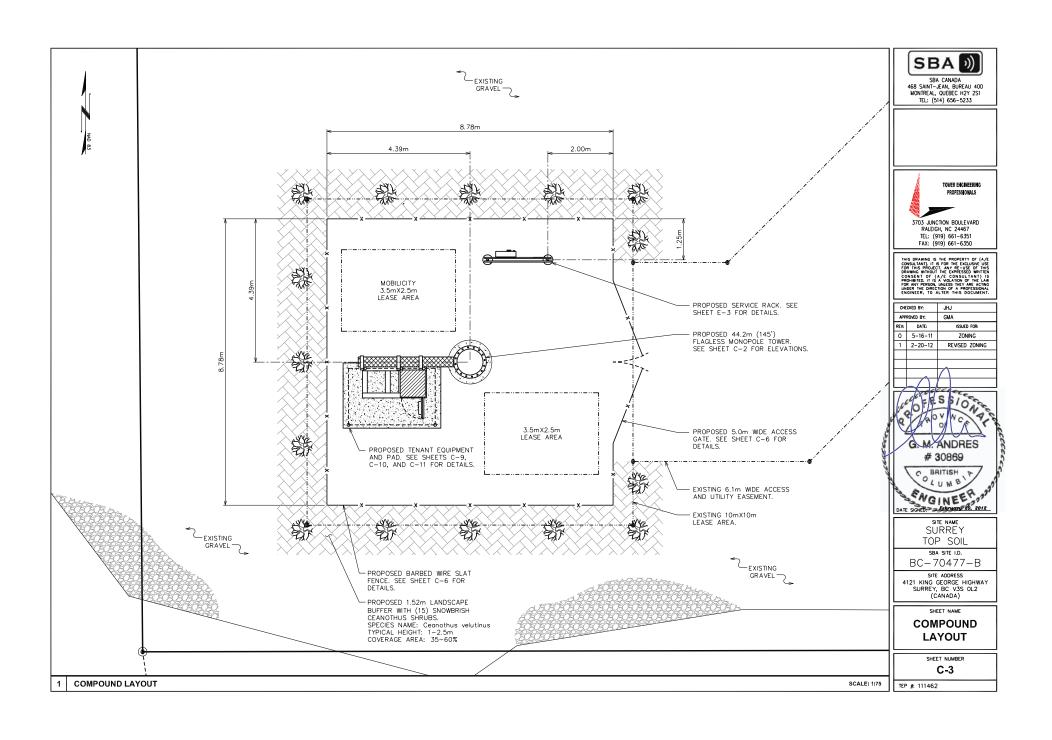





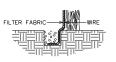

SBA) SBA CANADA 468 SAINT-JEAN, BUREAU 400 MONTREAL, QUEBEC H2Y 2S1 TEL: (514) 656-5233

1. SET POSTS AND EXCAVATE A 0.102m x 0.102m TRENCH UPSLOPE ALONG POSTS.

2. STAPLE WIRE FENCING TO THE LINE OF POSTS.

ATTACH THE FILTER FABRIC TO THE WIRE FENCE AND EXTEND IT INTO THE TRENCH.

4. EXTENSION OF FABRIC AND WIRE INTO THE TRENCH.

TOWER ENGINEERING 3703 JUNCTION BOULEVARD RALEIGH, NC 24467 TEL: (919) 661-6351 FAX: (919) 661-6350

CHE	CKED BY:	JHJ
APP	ROVED BY:	GMA
REV:	DATE:	ISSUED FOR:
0	5-16-11	ZONING
1	2-20-12	REVISED ZONING
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30869 C BRITISH DATE SIGNED: Pebruary 20, 2012

SURREY TOP SOIL SBA SITE I.D.


BC-70477-B SITE ADDRESS


4121 KING GEORGE HIGHWAY SURREY, BC V3S 0L2 (CANADA)


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EROSION CONTROL PLAN


SHEET NUMBER C-4 TEP #: 111462



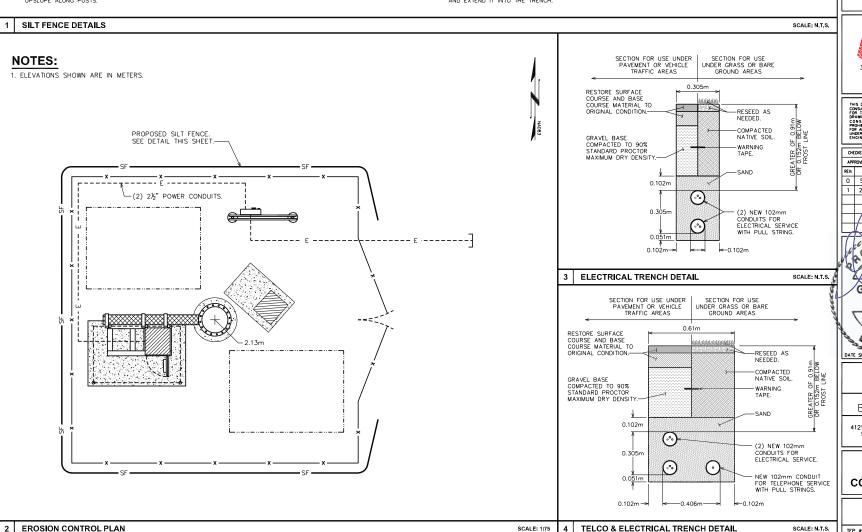

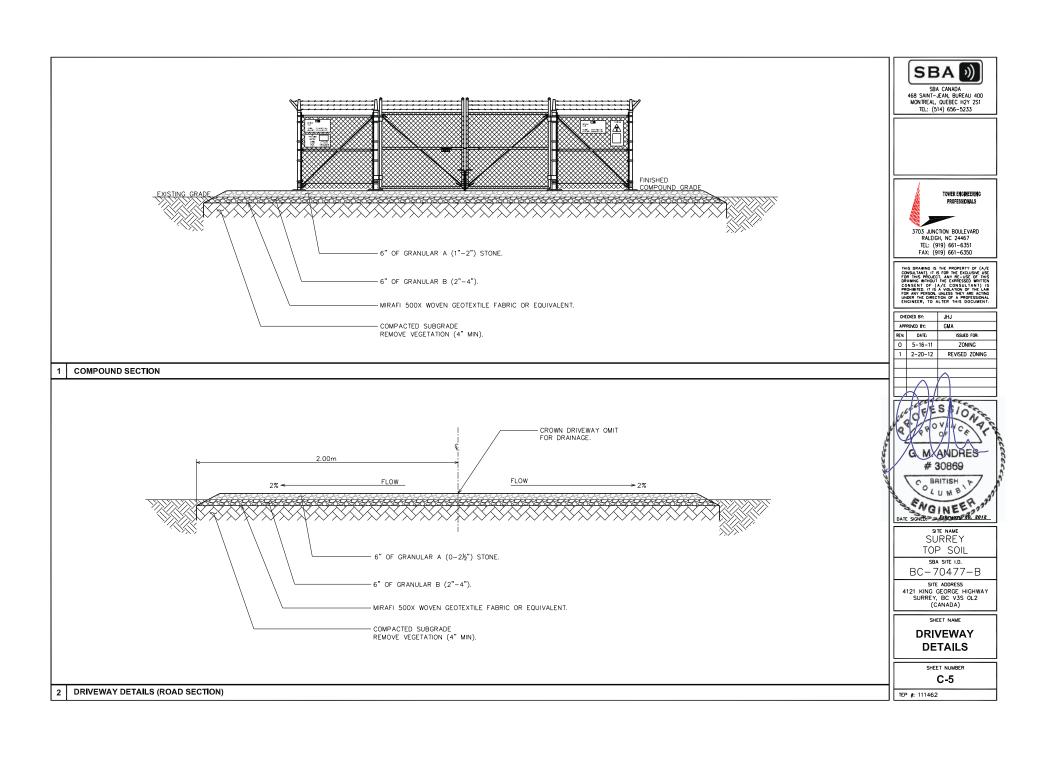

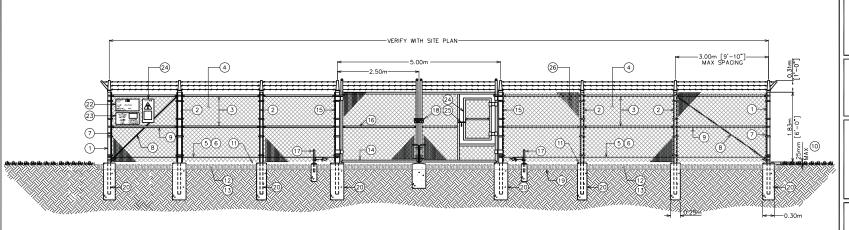SCALE: N.T.S.

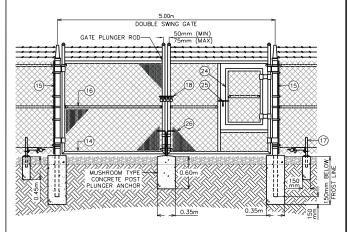

TYPICAL FENCE DETAIL

BALLOON REFERENCE NOTES:

- (1) CORNER, END OR PULL POST: 3½" O.D. SCHEDULE 40 PIPE.
- 2 LINE POST: 2%" NOMINAL SCHEDULE 40 PIPE, PER ASTM-F1083. LINE POSTS SHALL BE EQUALLY SPACED AT MAXIMUM 10'-0" O.C.
- 3) TOP RAIL & BRACE RAIL: 111/16" O.D. STANDARD ROUND PIPE, PER ASTM-F1083.
- (4) FABRIC: 9 GA CORE WIRE SIZE 2" MESH, CONFORMING TO ASTM-A392.
- (5) TIE WIRE: 9 GA ALUMINUM. A SINGLE WRAP OF FABRIC TIE AND AT TENSION WIRE BY HOG RINGS SPACED 12" O.C. POSTS/GATES AND 24" RAILS/WIRE.
- 6) TENSION WIRE: 9 GA ALUMINUM
- 7 ¾6" x ¾" (MIN) FULL HEIGHT STRETCHER BAR.
- 8 % DIAGONAL ROD WITH GALVANIZED STEEL TURNBUCKLE OR DIAGONAL THREADED ROD.
- 9 FENCE CORNER POST BRACE: 1%" NOMINAL PIPE
- (10) 1" MAXIMUM CLEARANCE FROM FINISH GRADE.
- (11) FENCE POST FOUNDATION TO BE 1" FINISH ABOVE FINISHED GRADE
- (12) 6" COMPACTED BASE MATERIAL
- (13) FINISH GRADE SHALL BE UNIFORM AND LEVEL.
- (14) WELDED GATE FRAME: 111/6" O.D., SCHEDULE 40 PIPE, PER ASTM-F1083.
- (15) GATE POST 4½" O.D., SCHEDULE 40 PIPE, PER ASTM-F1083.
- (16) GATE FRAME BRACE RAIL: 11/2" NOMINAL PIPE, PER ASTM-F1083.
- (17) DUCK BILL OPEN GATE HOLDER. 6"-8" FROM FENCE PRIOR TO INSTALLATION.
- $\ensuremath{\textcircled{\mbox{\footnotesize (B)}}}$ Stymie lock multi-tenant locking device with one combo lock supplied by contractor to SBA.
- (19) GEOTEXTILE FABRIC
- 20 CONCRETE FOUNDATION (MIN 3000 PSI). MINIMUM DEPTH: 6" BELOW FROST LINÉ
- (21) 12" x 24" SBA SITE INFORMATION SIGN.
- 22) 12" x 24" NO TRESPASSING SIGN.
- (23) 12" x 24" RF CAUTION SIGN.
- (24) SNOW GATE
- (25) FORK LATCH WITH SBA COMBO LOCK SUPPLIED BY CONTRACTOR
- (26) GREEN SLAT FENCING

GENERAL NOTES:

- 1. INSTALL FENCING PER ASTM F-567
- 2. INSTALL SWING GATES PER ASTM F- 900
- 3. LOCAL ORDINANCE OF BARBED WIRE PERMIT REQUIREMENT SHALL BE COMPLIED IF REQUIRED.
- 4. POST & GATE PIPE SIZES ARE INDUSTRY STANDARDS. ALL PIPE TO BE GALVANIZED (HOT DIP, ASTM A120 GRADE "A" STEEL). ALL GATE FRAMES SHALL BE WELDED. ALL WELDING SHALL BE COATED WITH (3) COATS OF COLD GALV. (OR EQUAL).
- 5. ALL OPEN POSTS SHALL HAVE END-CAPS.
- USE GALVANIZED HOG-RING WIRE TO MOUNT
- ALL SIGNS MUST BE MOUNTED ON INSIDE OF FENCE FABRIC.
- 8. MUSHROOM ANCHOR & PLUNGER REQUIRED FOR GATE.
- ALL FENCING SHALL BE DESIGNED IN ACCORDANCE WITH THE CANADIAN GENERAL STANDARDS BOARDS
 CAN2-138.1 FENCE, CHAIN LINK, FABRIC; CAN2-138.2
 FENCE, CHAIN LINK, FRAMEWORK ZINC COATED STEEL; CAN2-138.4 FENCE, CHAIN LINK, GATES.



468 SAINT-JEAN, BUREAU 400 MONTREAL, QUEBEC H2Y 2S1 TEL: (514) 656-5233



FAX: (919) 661-6350

CHE	CKED BY:	JHJ
APP	ROVED BY:	GMA
REV:	DATE:	ISSUED FOR:
0	5-16-11	ZONING
1	2-20-12	REVISED ZONING
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SURREY TOP SOIL

SBA SITE I.D. BC-70477-B

SITE ADDRESS 4121 KING GEORGE HIGHWAY SURREY, BC V3S OL2 (CANADA)

SHEET NAME


FENCE **DETAILS**


SHEET NUMBER C-6

SCALE: N.T.S.

DOUBLE SWING SPLIT GATE DETAIL SCALE: N.T.S.

FENCE NOTES

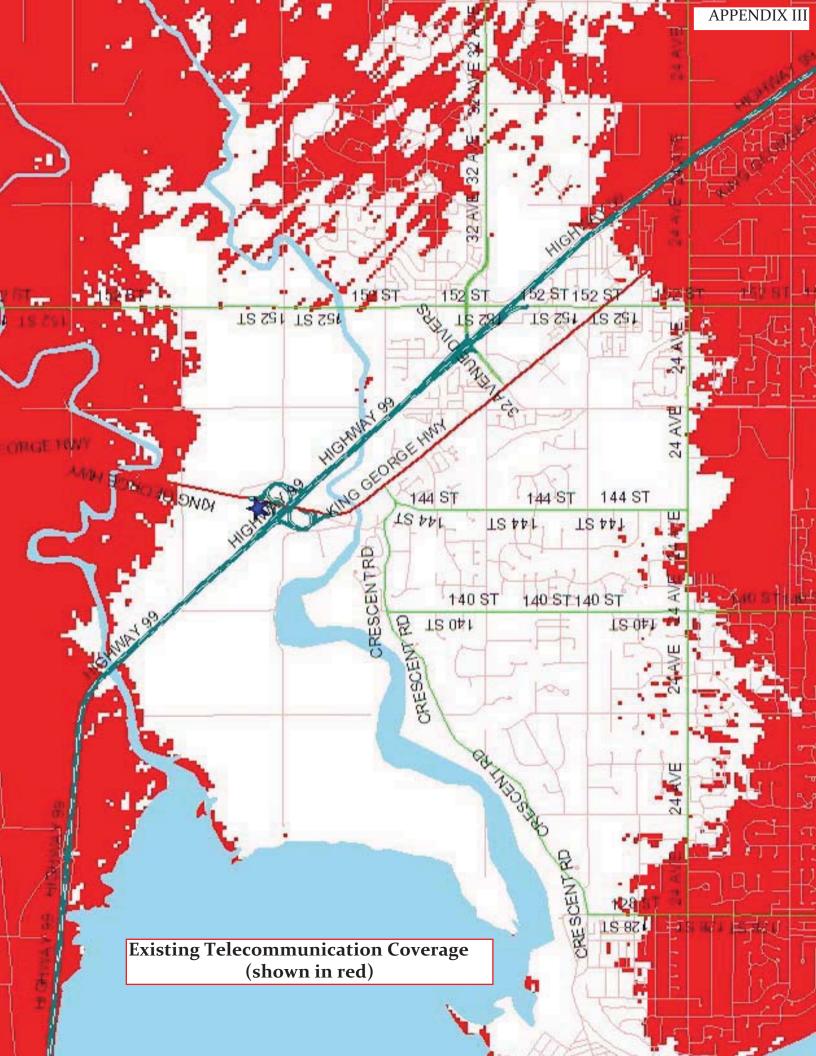

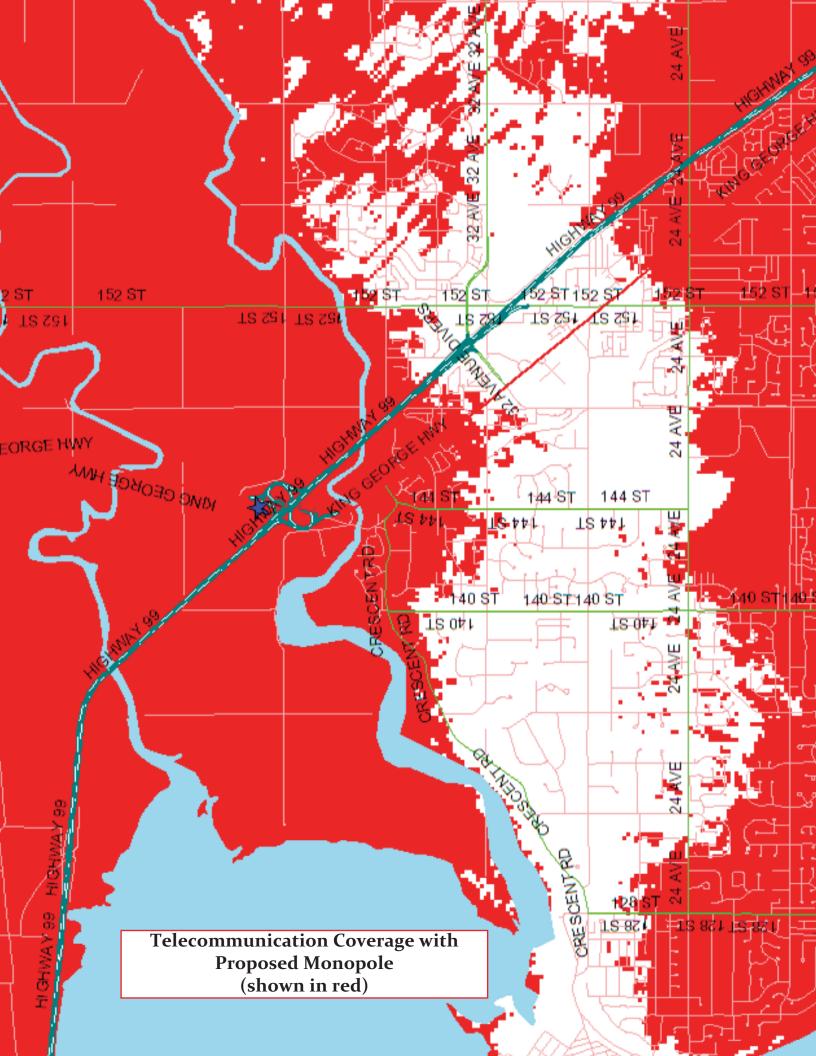

CITY OF SURREY

(the "City")

DEVELOPMENT VARIANCE PERMIT

NO.: 7911-0141-00

Issued To: SURREY TOPSOIL LTD., INC. NO. 403047

("the Owner")

Address of Owner: 3588 - 164A Street

Surrey BC V₃S oM₁

- 1. This development variance permit is issued subject to compliance by the Owner with all statutes, by-laws, orders, regulations or agreements, except as specifically varied by this development variance permit.
- 2. This development variance permit applies to that real property including land with or without improvements located within the City of Surrey, with the legal description and civic address as follows:

Parcel Identifier: 009-236-520 Lot 1 District Lot 161 Group 2 New Westminster District Plan 10071


4121 King George Boulevard


(the "Land")


- 3. Surrey Zoning By-law, 1993, No. 12000, as amended is varied as follows:
- 4. The landscaping and the siting of buildings and structures shall be in accordance with the drawings numbered C1 through to C6 (the "Drawings") which are attached hereto and form part of this development variance permit.
- 5. The Land shall be developed strictly in accordance with the terms and conditions and provisions of this development variance permit.
- 6. This development variance permit shall lapse if the Owner does not substantially start any construction with respect to which this development variance permit is issued, within two (2) years after the date this development variance permit is issued.


7.	The terms of this development variance pern persons who acquire an interest in the Land.	nit or any amendment to it, are binding on all
8.	This development variance permit is not a bu	uilding permit.
	ORIZING RESOLUTION PASSED BY THE CC D THIS DAY OF , 20 .	OUNCIL, THE DAY OF , 20 .
		Mayor – Dianne L. Watts
		City Clerk – Jane Sullivan

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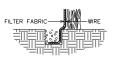


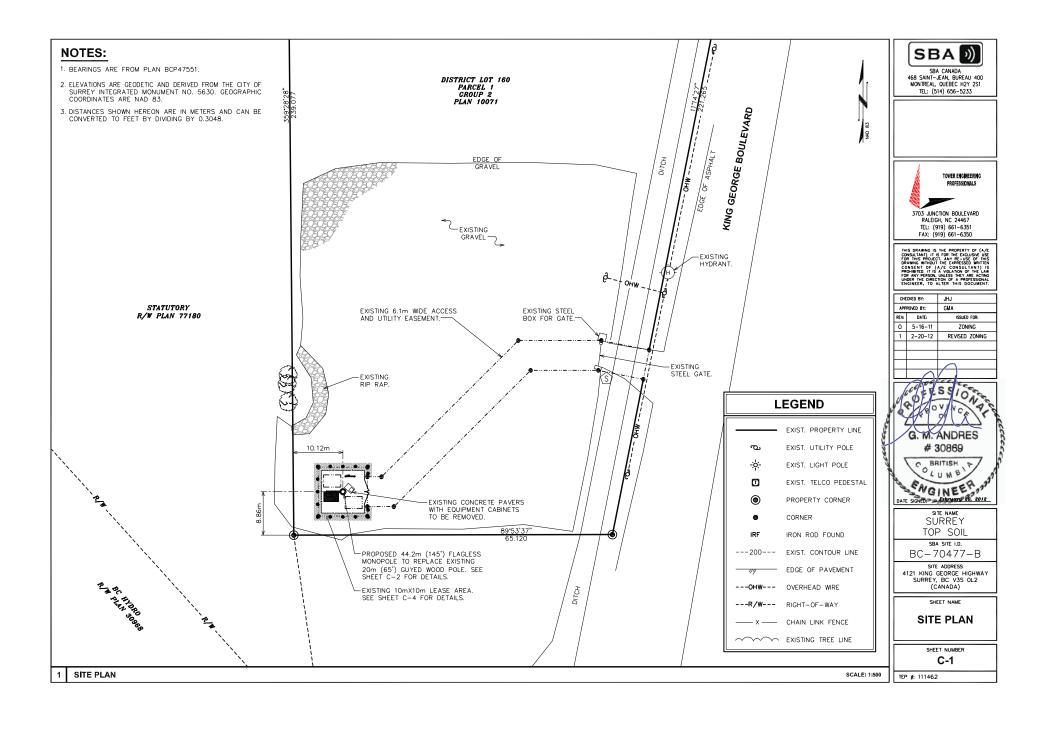

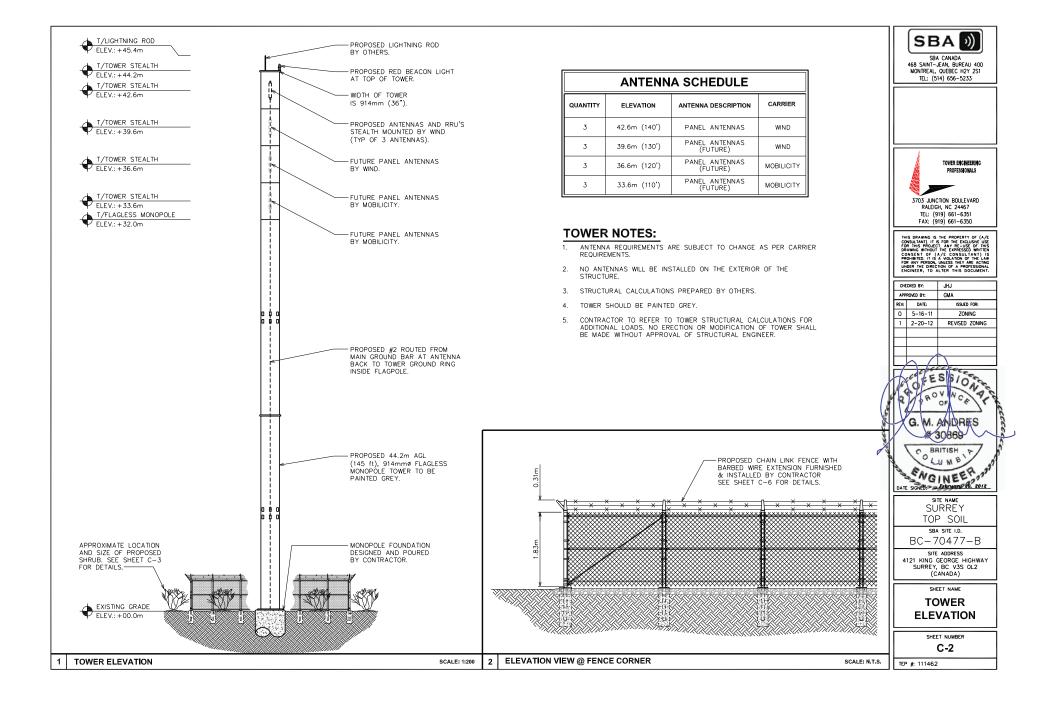

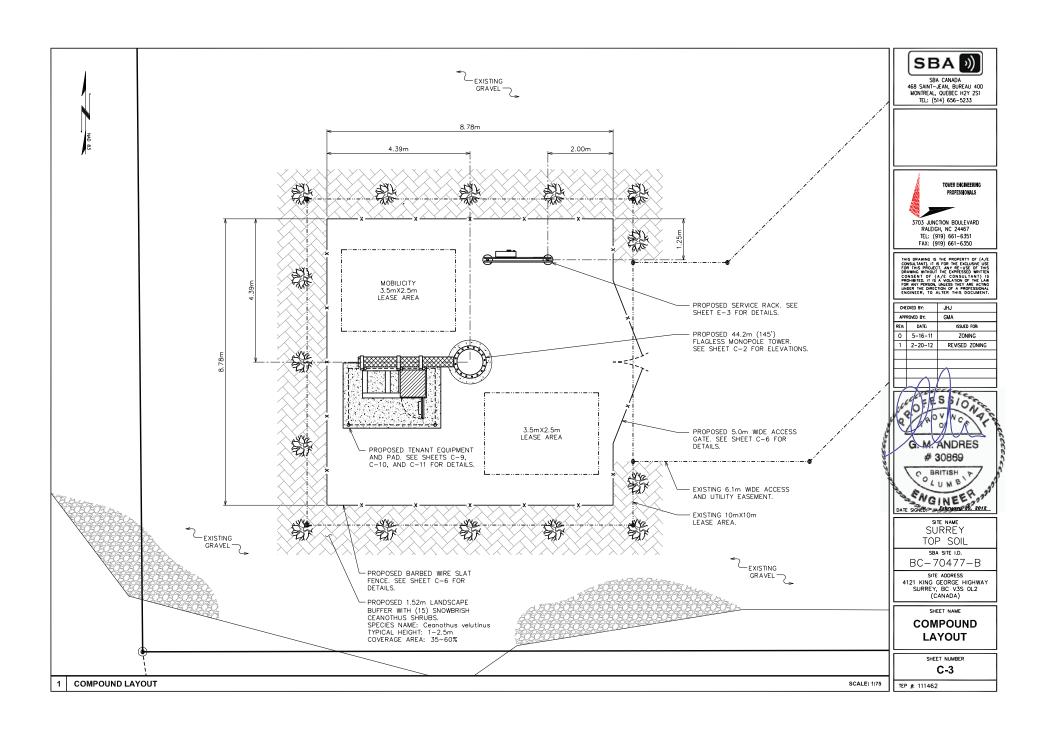
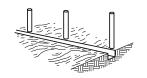
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SBA CANADA
468 SAINT-JEAN, BUREAU 400
MONTREAL, OUEBEC H2Y 2S1
TEL: (514) 656-5233

 SET POSTS AND EXCAVATE A 0.102m x 0.102m TRENCH UPSLOPE ALONG POSTS.

EROSION CONTROL PLAN

2. STAPLE WIRE FENCING TO THE LINE OF POSTS.

 ATTACH THE FILTER FABRIC TO THE WIRE FENCE AND EXTEND IT INTO THE TRENCH. 4. EXTENSION OF FABRIC AND WIRE INTO THE TRENCH.

TELCO & ELECTRICAL TRENCH DETAIL



S DRAWING IS THE PROPERTY OF (A/E ISULTANT) IT IS FOR THE EXCLUSIVE USE IT THIS PROJECT. ANY RE-USE OF THIS THIS PROJECT. ANY RE-USE OF THIS WINDOW WITHOUT THE EXPRESSED WRITTEN NESHT OF (A/E CON SULTANT) IS HIBITED. IT IS A WOLATION OF THE LAW ANY PERSON, UNLESS THEY ARE ACTING DER THE DIRECTION OF A PROFESSIONAL INHER. TO ALTER THIS DOCUMENT.

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G. M. ANDRES
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DATE SORGS - LEGISLATION & 2012

SITE NAME SURREY TOP SOIL SBA SITE I.D.

BC-70477-B


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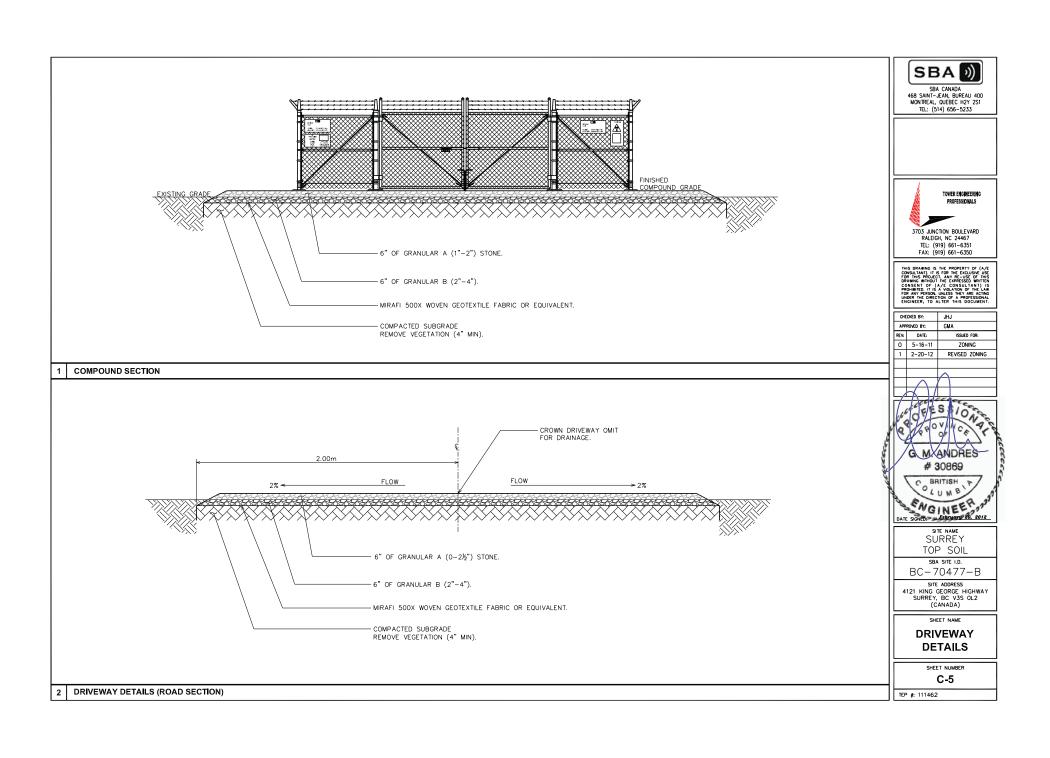
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SURREY, BC V3S 0L2


SURREY, BC V3S OL2 (CANADA)

EROSION CONTROL PLAN


SCALE: N.T.S.



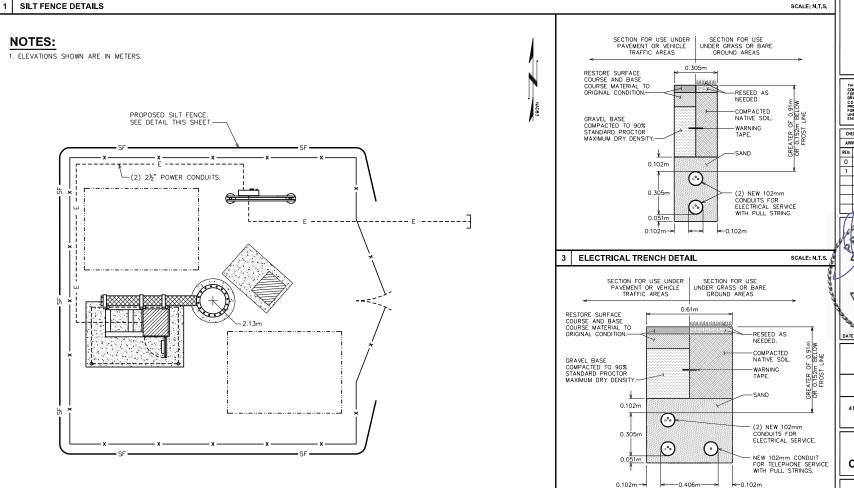

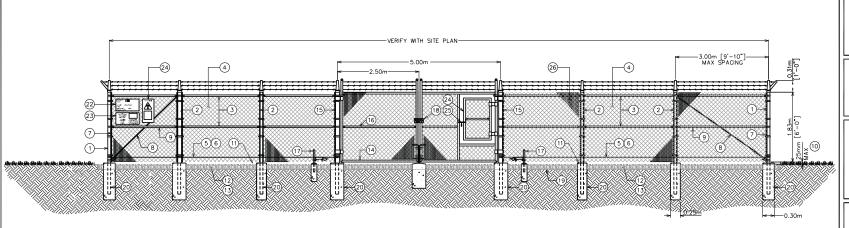

TYPICAL FENCE DETAIL SCALE: N.T.S.

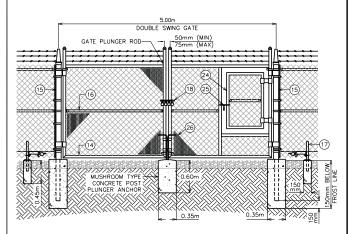

BALLOON REFERENCE NOTES:

- (1) CORNER, END OR PULL POST: 3½" O.D. SCHEDULE 40 PIPE.
- 2 LINE POST: 2%" NOMINAL SCHEDULE 40 PIPE, PER ASTM-F1083. LINE POSTS SHALL BE EQUALLY SPACED AT MAXIMUM 10'-0" O.C.
- 3) TOP RAIL & BRACE RAIL: 111/16" O.D. STANDARD ROUND PIPE, PER ASTM-F1083.
- (4) FABRIC: 9 GA CORE WIRE SIZE 2" MESH, CONFORMING TO ASTM-A392.
- (5) TIE WIRE: 9 GA ALUMINUM. A SINGLE WRAP OF FABRIC TIE AND AT TENSION WIRE BY HOG RINGS SPACED 12" O.C. POSTS/GATES AND 24" RAILS/WIRE.
- 6) TENSION WIRE: 9 GA ALUMINUM
- 7 ¾6" x ¾" (MIN) FULL HEIGHT STRETCHER BAR.
- 8 % DIAGONAL ROD WITH GALVANIZED STEEL TURNBUCKLE OR DIAGONAL THREADED ROD.
- 9 FENCE CORNER POST BRACE: 1%" NOMINAL PIPE
- (10) 1" MAXIMUM CLEARANCE FROM FINISH GRADE.
- (11) FENCE POST FOUNDATION TO BE 1" FINISH ABOVE FINISHED GRADE
- (12) 6" COMPACTED BASE MATERIAL
- (13) FINISH GRADE SHALL BE UNIFORM AND LEVEL.
- (14) WELDED GATE FRAME: 111/6" O.D., SCHEDULE 40 PIPE, PER ASTM-F1083.
- (15) GATE POST 4½" O.D., SCHEDULE 40 PIPE, PER ASTM-F1083.
- (16) GATE FRAME BRACE RAIL: 11/2" NOMINAL PIPE, PER ASTM-F1083.
- (17) DUCK BILL OPEN GATE HOLDER. 6"-8" FROM FENCE PRIOR TO INSTALLATION.
- $\ensuremath{\textcircled{\mbox{\footnotesize (B)}}}$ Stymie lock multi-tenant locking device with one combo lock supplied by contractor to SBA.
- (19) GEOTEXTILE FABRIC
- 20 CONCRETE FOUNDATION (MIN 3000 PSI). MINIMUM DEPTH: 6" BELOW FROST LINÉ
- (21) 12" x 24" SBA SITE INFORMATION SIGN.
- 22) 12" x 24" NO TRESPASSING SIGN.
- (23) 12" x 24" RF CAUTION SIGN.
- (24) SNOW GATE
- (25) FORK LATCH WITH SBA COMBO LOCK SUPPLIED BY CONTRACTOR
- (26) GREEN SLAT FENCING

GENERAL NOTES:

- 1. INSTALL FENCING PER ASTM F-567
- 2. INSTALL SWING GATES PER ASTM F- 900
- 3. LOCAL ORDINANCE OF BARBED WIRE PERMIT REQUIREMENT SHALL BE COMPLIED IF REQUIRED.
- 4. POST & GATE PIPE SIZES ARE INDUSTRY STANDARDS. ALL PIPE TO BE GALVANIZED (HOT DIP, ASTM A120 GRADE "A" STEEL). ALL GATE FRAMES SHALL BE WELDED. ALL WELDING SHALL BE COATED WITH (3) COATS OF COLD GALV. (OR EQUAL).
- 5. ALL OPEN POSTS SHALL HAVE END-CAPS.
- USE GALVANIZED HOG-RING WIRE TO MOUNT
- ALL SIGNS MUST BE MOUNTED ON INSIDE OF FENCE FABRIC.
- 8. MUSHROOM ANCHOR & PLUNGER REQUIRED FOR GATE.
- ALL FENCING SHALL BE DESIGNED IN ACCORDANCE WITH THE CANADIAN GENERAL STANDARDS BOARDS
 CAN2-138.1 FENCE, CHAIN LINK, FABRIC; CAN2-138.2
 FENCE, CHAIN LINK, FRAMEWORK ZINC COATED STEEL; CAN2-138.4 FENCE, CHAIN LINK, GATES.



468 SAINT-JEAN, BUREAU 400 MONTREAL, QUEBEC H2Y 2S1 TEL: (514) 656-5233



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CHE	CKED BY:	JHJ
APP	ROVED BY:	GMA
REV:	DATE:	ISSUED FOR:
0	5-16-11	ZONING
1	2-20-12	REVISED ZONING
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SURREY TOP SOIL

SBA SITE I.D. BC-70477-B

SITE ADDRESS 4121 KING GEORGE HIGHWAY SURREY, BC V3S OL2 (CANADA)

SHEET NAME

FENCE **DETAILS**

SHEET NUMBER C-6

DOUBLE SWING SPLIT GATE DETAIL **FENCE NOTES** SCALE: N.T.S. SCALE: N.T.S.