

# City of Surrey PLANNING & DEVELOPMENT REPORT File: 7911-0291-00

Planning Report Date: April 23, 2012

#### PROPOSAL:

- OCP Amendment of a portion from Suburban to Urban
- Rezoning from RA and RF-12C to RF-12C, RM-23 and RF
- Development Permit

in order to allow subdivision into 4 RF-12C lots with adjoining land, 3 RM-23 lots and 1 remainder lot.

LOCATION: 7241 - 192 Street and Portion of 7259

- 192 Street

**OWNER:** Legendary Developments (Clayton)


Ltd.

**ZONING:** RF-12C and RA

OCP DESIGNATION: Urban and Suburban

NCP DESIGNATION: 6-10 upa (Low Density) and 15-25

upa (Medium-High Density)

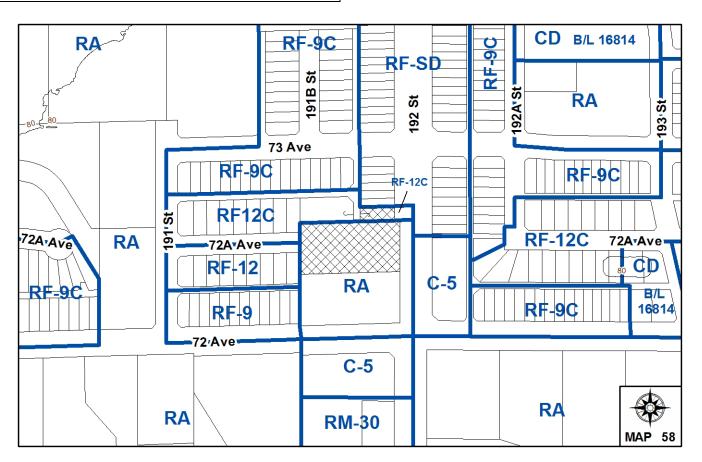

# **RECOMMENDATION SUMMARY**

- By-law Introduction and set date for Public Hearing for:
  - o OCP Amendment; and
  - o Rezoning.

#### DEVIATION FROM PLANS, POLICIES OR REGULATIONS

None

## **RATIONALE OF RECOMMENDATION**

- A redesignation from Suburban to Urban is required for the southern subject property at 7241 192 Street to make the designation of the site consistent with the East Clayton NCP Extension North of 72 Avenue designations and the adjoining land uses.
- Complies with the East Clayton NCP Extension North of 72 Avenue designations of 6-10 upa (Low Density) and 15-25 upa (Medium-High Density).
- The proposed development will continue a pattern of development which has generally been established under Application Nos. 7905-0382-00 and 7910-0177-00 further north.

#### RECOMMENDATION

The Planning & Development Department recommends that:

- a By-law be introduced to amend the OCP for 7241-192 Street, by redesignating the property from Suburban to Urban and a date for Public Hearing be set.
- 2. Council determine the opportunities for consultation with persons, organizations and authorities that are considered to be affected by the proposed amendment to the Official Community Plan, as described in the Report, to be appropriate to meet the requirement of Section 879 of the Local Government Act.
- a By-law be introduced to rezone Blocks A through D as shown on the Survey Plan attached as Appendix I, as follows:
  - (a) Block A on the Survey Plan from "One-Acre Residential Zone (RA)" (By-law No. 12000) to "Single Family Residential (12) Coach House Zone (RF-12C)" (By-law No. 12000);
  - (b) Block B on the Survey Plan from "Single Family Residential (12) Coach House Zone (RF-12C)"(By-law No. 12000) to "Multiple Residential 23 Zone (RM-23)"(By-law No. 12000);
  - (c) Block C on the Survey Plan from "One-Acre Residential Zone (RA)"(By-law No. 12000) to "Multiple Residential 23 Zone (RM-23)" (By-law No. 12000); and
  - (d) Block D on the Survey Plan from "One-Acre Residential Zone (RA)"(By-law No. 12000) to "Single Family Residential Zone (RF)"(By-law No. 12000)

and a date be set for Public Hearing.

- 4. Council instruct staff to resolve the following issues prior to final adoption:
  - (a) ensure that all engineering requirements and issues including restrictive covenants, dedications, and rights-of-way where necessary, are addressed to the satisfaction of the General Manager, Engineering;
  - (b) submission of a subdivision layout to the satisfaction of the Approving Officer;
  - (c) submission of a finalized tree survey and a statement regarding tree preservation to the satisfaction of the City Landscape Architect;
  - (d) submission of a landscaping and landscape buffer plan for proposed Lots 5 to 7 and landscaping cost estimate to the specifications and satisfaction of the Planning and Development Department;
  - (e) removal of existing buildings and structures to the satisfaction of the Planning and Development Department;
  - (f) registration of a Section 219 Restrictive Covenant for "no build" and maintenance of the 3-metre (10 ft.) landscape buffer along 192 Street on proposed Lots 5 to 7;

(g) discharge of "no build" Restrictive Covenant No. BB2004661, currently registered on the northern subject lot at 7259 – 192 Street;

- (h) registration of a Section 219 Restrictive Covenant for "no build" on proposed Lot 8, until future consolidation with the adjacent property to the south at 19175 72 Avenue;
- (i) registration of a party wall and corresponding easement agreements for proposed Lots 5 to 7;
- (j) registration of a Section 219 Restrictive Covenant for a minimum 4.6-metre (15 ft.) building setback, from 192 Street property line to building face, on the proposed RM-23-zoned lots (proposed Lots 5 to 7).

# **REFERRALS**

Engineering: The Engineering Department has no objection to the project,

subject to the completion of Engineering servicing requirements, as

outlined in Appendix III.

School District: **Projected number of students from this development:** 

3 Elementary students at Clayton Elementary School 1 Secondary student at Clayton Heights Secondary School

(Appendix IV)

The applicant has advised that the dwelling units in this project are expected to be constructed and ready for occupancy by March 2013.

Parks, Recreation & Culture:

Parks has no concerns.

# **SITE CHARACTERISTICS**

<u>Existing Land Use:</u> An old barn exists and will be removed.

## Adjacent Area:

Direction	Existing Use	NCP Designation	Existing Zone
North:	Recently approved single	10-15 upa (Medium	RF-9C, RF-12C
	family subdivision under	Density), 15-25 upa	and RF-SD
	Application No. 7910-0177-	(Medium-High	
	00.	Density) and 6-10 upa	
		(Low Density).	
East (Across 192 Street):	Fee simple "duplexes" and	15-25 upa (Medium-	RF-SD and C-5
	neighbourhood commercial	High Density) and	
	development.	Neighbourhood	
		Commercial.	
South:	Single family dwelling on	10-15 upa (Medium	RA
	residential acreage.	Density), 15-25 upa	
		(Medium-High	
		Density) and 6-10 upa	
		(Low Density)	
West	Single family dwellings on	10-15 upa (Medium	RF-12C and RF-
	small lots, with and without	Density) and 6-10 upa	12
	coach houses.	(Low Density)	

#### JUSTIFICATION OF OCP AMENDMENT

- An OCP amendment is proposed from Suburban to Urban for all of the southern subject lot at 7241 192 Street, as shown in Appendix VIII. The northern subject lot, at 7259 192 Street, is already designated Urban in the OCP, approved under Development Application No. 7910-0177-00.
- Council, on July 28, 2004, approved Stage 1 (Corporate Report No. C009), which deals with land use designations and road network in the area of the East Clayton Neighbourhood Concept Plan (NCP) Extension North of 72 Avenue. On June 20, 2005, Council approved the corresponding Stage 2 Report (Corporate Report No. C011).
- Currently, the land use designations that are reflected in the East Clayton NCP Extension North of 72 Avenue require corresponding OCP designation amendments from the current Suburban designation. The approved Stage 2 Report (Corporate Report No. C011) directed staff to bring forward specific OCP amendments on a site-by-site basis concurrently with site-specific rezoning applications.
- The proposed Urban designation in the OCP is consistent with the current 6-10 upa (Low Density) and 15-25 upa (Medium-High Density) designations in the NCP.

# **DEVELOPMENT CONSIDERATIONS**

• The subject site includes two (2) properties located at 7241 and 7259 - 192 Street. The subject site is currently zoned One-Acre Residential Zone (RA) and Single Family Residential (12) Coach House Zone (RF-12C) and is located within the "East Clayton NCP"

Extension – North of 72 Avenue" area. The site is approximately 4,200 square metres (1.0 ac.) in size.

- The applicant, Legendary Developments, has submitted an application for a proposed rezoning from One-Acre Residential Zone (RA) and Single Family Residential (12) Coach House Zone (RF-12C) to Single Family Residential (12) Coach House Zone (RF-12C), Multiple Residential 23 Zone (RM-23) and Single Family Residential Zone (RF), to allow for subdivision into 4 RF-12C lots, 3 RM-23 lots and 1 RF remainder lot (Appendix I).
- The 3 proposed RM-23-zoned lots will accommodate a proposed 3-unit row house development. The design of the proposed row houses has been reviewed by staff and will be secured under a Development Permit.
- Proposed Lot 8 is to be rezoned to Single Family Residential Zone (RF) and a "No Build" restrictive covenant will be registered on this lot, which will be consolidated in the future with the property to the south.
- As no parkland is required at this location, the applicant will be required to provide cashin-lieu of the 5% parkland dedication requirement, as a condition of subdivision.

# Rezoning from RA to RF-12C (Block A)

• Rezoning is proposed for a 9580-square metre (10,312 sq.ft.) portion of the site (shown as Block A) from RA to RF-12C, in order to create 4 RF-12C lots, with land which was already rezoned to RF-12C under Application No. 7910-0177-00.

# Rezoning from RF-12C to RM-23 (Block B)

• Rezoning is proposed for a 396.4-square metre (4,267 sq.ft.) portion of the subject site (shown as Block B) from RF-12C to RM-23 which will allow for the creation of 3 row house fee simple lots, together with the area shown in Block C.

# Rezoning from RA to RM-23 (Block C)

• Rezoning is proposed for a 650.3-square metre (7,000 sq.ft.) portion from RA to RM-23 (Block C), which will allow for the creation of 3 row house fee simple lots, together with the area shown in Block B.

## Rezoning from RA to RF (Block D)

- An RF-zoned remnant lot, proposed Lot 8, which is 0.252 hectare (0.6 ac.) in size, is proposed as part of this application.
- Proposed Lot 8 will have a Section 219 Restrictive Covenant registered on it for "No Build", until the lot can be consolidated with the property to the south.

# Building Design Guidelines and Proposed Lot Grading

- Proposed building design guidelines for proposed Lots 1 to 4 (to be zoned RF-12C) were prepared by Tynan Design Consulting and comply with the General Urban Design Guidelines established for the East Clayton NCP Extension North of 72 Avenue.
- The building design guidelines require additional detailing on the rear elevations of the coach houses, similar to the detailing on the principal dwelling, which will allow for visual interest in the lanes.
- A preliminary lot grading plan has been reviewed by Building Division staff and was determined to be acceptable. The proposed lots will accommodate basements.

# Row House Design

- The proposed row houses, on proposed Lots 5, 6, and 7, will front 192 Street, which is consistent with the pattern of RF-SD-zoned semi-detached units to the north.
- The proposed row houses are subject to a detailed design review through the Development Permit process. See the "Design Proposal and Review" section below for additional information.

# Arborist Assessment and Landscaping Plan

• An arborist assessment prepared by Guy Exley, certified arborist of ACL Arbortech Consulting Ltd. has been submitted. The report indicates that there are five mature trees on the subject site and one City tree affected by the proposed development. It is proposed that two of the on-site trees be retained.

Tree Species	Total No.	Total	Total
	of Trees	Proposed	Proposed
		for Retention	for Removal
	(off-site trees)	(off-site trees)	(off-site trees)
Red Alder	1 (0)	0 (0)	1 (0)
Pear	2 (0)	0 (0)	1 (0)
Birch	1 (1)	1 (0)	0 (1)
Willow	1 (0)	1 (0)	0 (0)
TOTAL	5 (1)	2 (0)	2 (1)

- The Arborist Report and Tree Preservation / Replacement Plans have been reviewed by City staff and require revisions prior to consideration of Final Approval of the rezoning.
- Under the current Tree Preservation By-law, a tree replacement ratio of 1:1 for alder and cottonwood trees and a tree replacement ratio of 2:1 for all other trees is required.
- Small lots can generally only accommodate 1 tree per lot. In the case of this application, a total of 5 replacement trees are required, but 12 trees are proposed.

• As per the East Clayton NCP Extension – North of 72 Avenue, a 3.0-metre (10 ft.) wide landscape buffer is envisioned along 192 Street. This buffer was already established to the north under Application Nos. 7905-0382-00 and 7910-0177-00. This buffer is to be ultimately continued to 72 Avenue.

• A "No Build" Restrictive Covenant will be required to be registered on the three proposed lots (Lots 5 to 7) fronting 192 Street to ensure that the landscape buffer is maintained and that no structures will be constructed within the landscape buffer.

## **PRE-NOTIFICATION**

Pre-notification letters were mailed to the area residents on February 7, 2012 and staff has not received any telephone calls or letters in response.

# PUBLIC CONSULTATION PROCESS FOR OCP AMENDMENT

Pursuant to Section 879 of the <u>Local Government Act</u>, it was determined that it was not necessary to consult with any persons, organizations or authorities with respect to the proposed OCP amendment, other than those contacted as part of the pre-notification process.

## DESIGN PROPOSAL AND REVIEW

- The proposed row housing units require an architectural design review through a Development Permit process. The applicant retained Tynan Design Ltd. to prepare the architectural design drawings and coordinate the preparation of the landscaping plans.
- The proposed row house units have been designed to provide a pedestrian-oriented streetscape along 192 Street, as well as provide a similar form and character to the existing semi-detached lots to the north.
- Proposed cladding materials consist of 7 ¼ inch horizontal hardiplank siding in iron gray and cultured stone siding in limestone charcoal. Architectural features, such as dormer windows, are proposed to be clad in hardipanel siding.
- These materials are complimented by wood trim boards in arctic white and decorative columns that frame the front doorways. "Shake profile" fibreglass laminated shingles in dual black are proposed as the roofing material.
- The proposed landscape buffer along 192 Street consists of a combination of a 4-foot high cedar fence along with trees and shrubs, including species such as Norway maple, Chinese dogwood, crabapple, pink abelia, blue and pink rhododendrons, George Vancouver rose, and salal.
- The rear yard spaces will be predominantly landscaped with sod lawn, with either a Norway maple or Chinese dogwood per yard, and fenced with a 6-foot high cedar privacy fence.

# **INFORMATION ATTACHED TO THIS REPORT**

The following information is attached to this Report:

Appendix I. Lot Owners, Action Summary and Project Data Sheets and Survey Plan

Appendix II. Proposed Subdivision Layout, Site Plan, Building Elevations, Landscape Plans

Appendix III. Engineering Summary
Appendix IV. School District Comments

Appendix V. Building Design Guidelines Summary

Appendix VI. Summary of Tree Survey and Tree Preservation

Appendix VII. NCP Plan

Appendix VIII. OCP Redesignation Map

original signed by Judith Robertson

Jean Lamontagne General Manager Planning and Development

# SAL/kms

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# Information for City Clerk

Legal Description and Owners of all lots that form part of the application:

1. (a) Agent: Name: Maggie Koka

Aplin & Martin Consultants Ltd.

Address: Unit 201, 12448 - 82 Avenue

Surrey, BC V<sub>3</sub>W<sub>3</sub>E<sub>9</sub>

Tel: 604-597-9058 - Primary

2. Properties involved in the Application

(a) Civic Address: 7241 and Portion of 7259 - 192 Street

(b) Civic Address: 7241 - 192 Street

Owner: Legendary Developments (Clayton) Ltd., Inc. No. BCo897820

PID: 005-654-840

Lot 65 Section 21 Township 8 New Westminster District Plan 58169

(c) Civic Address: Portion of 7259 -1 92 Street

Owner: Legendary Developments (Clayton) Ltd., Inc. No. BCo897820

Portion of PID: 001-435-434


Lot 9 Section 21 Township 8 New Westminster District Plan BCP49823


- 3. Summary of Actions for City Clerk's Office
  - (a) Introduce a By-law to amend the Official Community Plan to redesignate the property at 7241-192 Street from Suburban to Urban.
  - (b) Introduce a By-law to rezone the subject site.


# **SUBDIVISION DATA SHEET**

Proposed Zoning: RF-12C, RM-23 and RF

Requires Project Data	Proposed
GROSS SITE AREA	<b>*</b>
Acres	
Hectares	
NUMBER OF LOTS	
Existing	2
Proposed	8
SIZE OF LOTS	
Range of lot widths (metres)	
Range of lot areas (square metres)	
D. D. V. COLINIA	
DENSITY	
Lots/Hectare & Lots/Acre (Gross)	
Lots/Hectare & Lots/Acre (Net)	
SITE COVERAGE (in % of gross site area)	
Maximum Coverage of Principal &	
Accessory Building	
Estimated Road, Lane & Driveway Coverage	
Total Site Coverage	
3	
PARKLAND	
Area (square metres)	Cash-in-lieu
% of Gross Site	Cash-in-lieu
	Required
PARKLAND	
5% money in lieu	YES
TENER CLUDY TENER COEFFCO AT LITT	VIDO
TREE SURVEY/ASSESSMENT	YES
MODEL BUILDING SCHEME	YES
MODEL BUILDING SCHEME	TES
HERITAGE SITE Retention	NO
The state of the s	110
BOUNDARY HEALTH Approval	NO
DEV. VARIANCE PERMIT required	
Road Length/Standards	YES/NO
Works and Services	YES/NO
Building Retention	YES/NO
Others	YES/NO

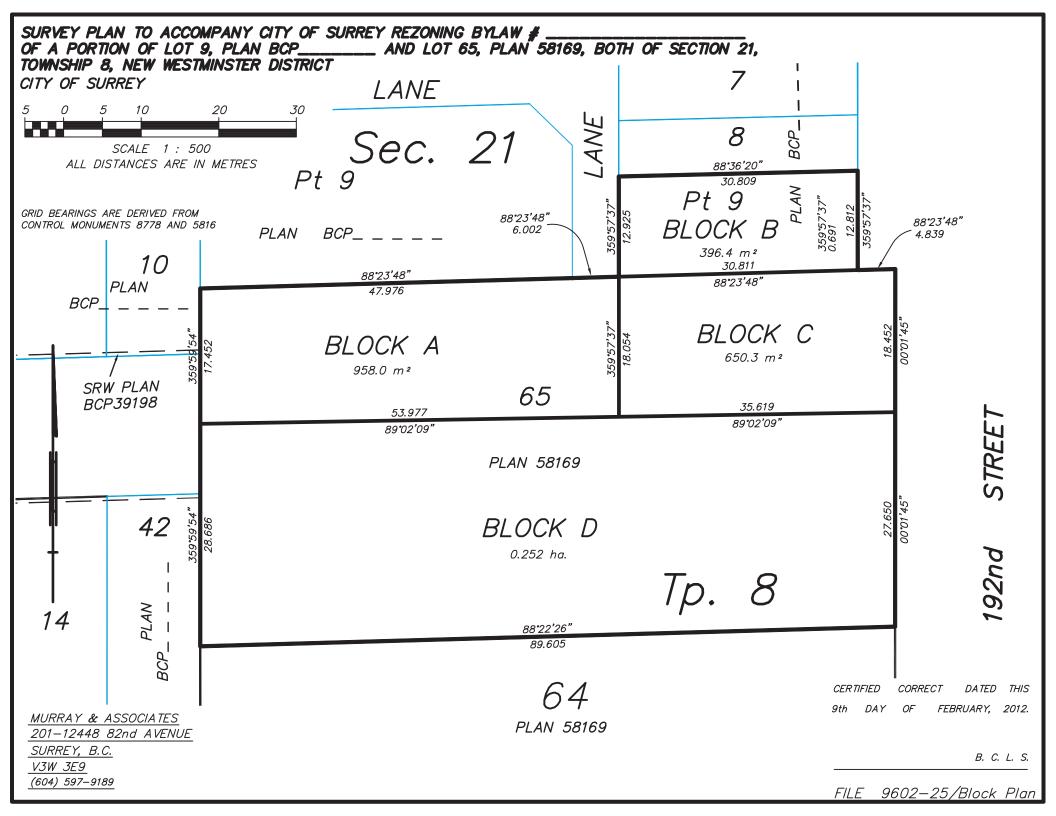

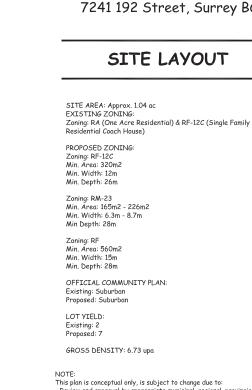

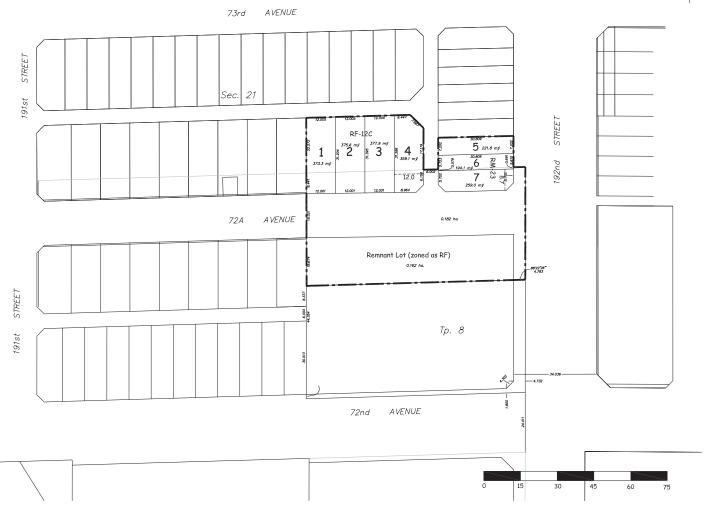


# Legendary Developments Residential Development 7241 192 Street, Surrey BC

- Review and approval by appropriate municipal, regional, provincial and federal governments and outside agencies
- Full environmental, geotechnical and soil assessments - Legal and topographical survey.
- Tree survey and assessment.
- Park dedication requirements or cash in lieu of.
- School site acquisition requirements and/or charges. - Storm water detention requirements.
- Road dedication requirements.
- Environmentally sensitive areas and setback requirements.
- Building locations.
- Right-of-way and/or easement requirements.





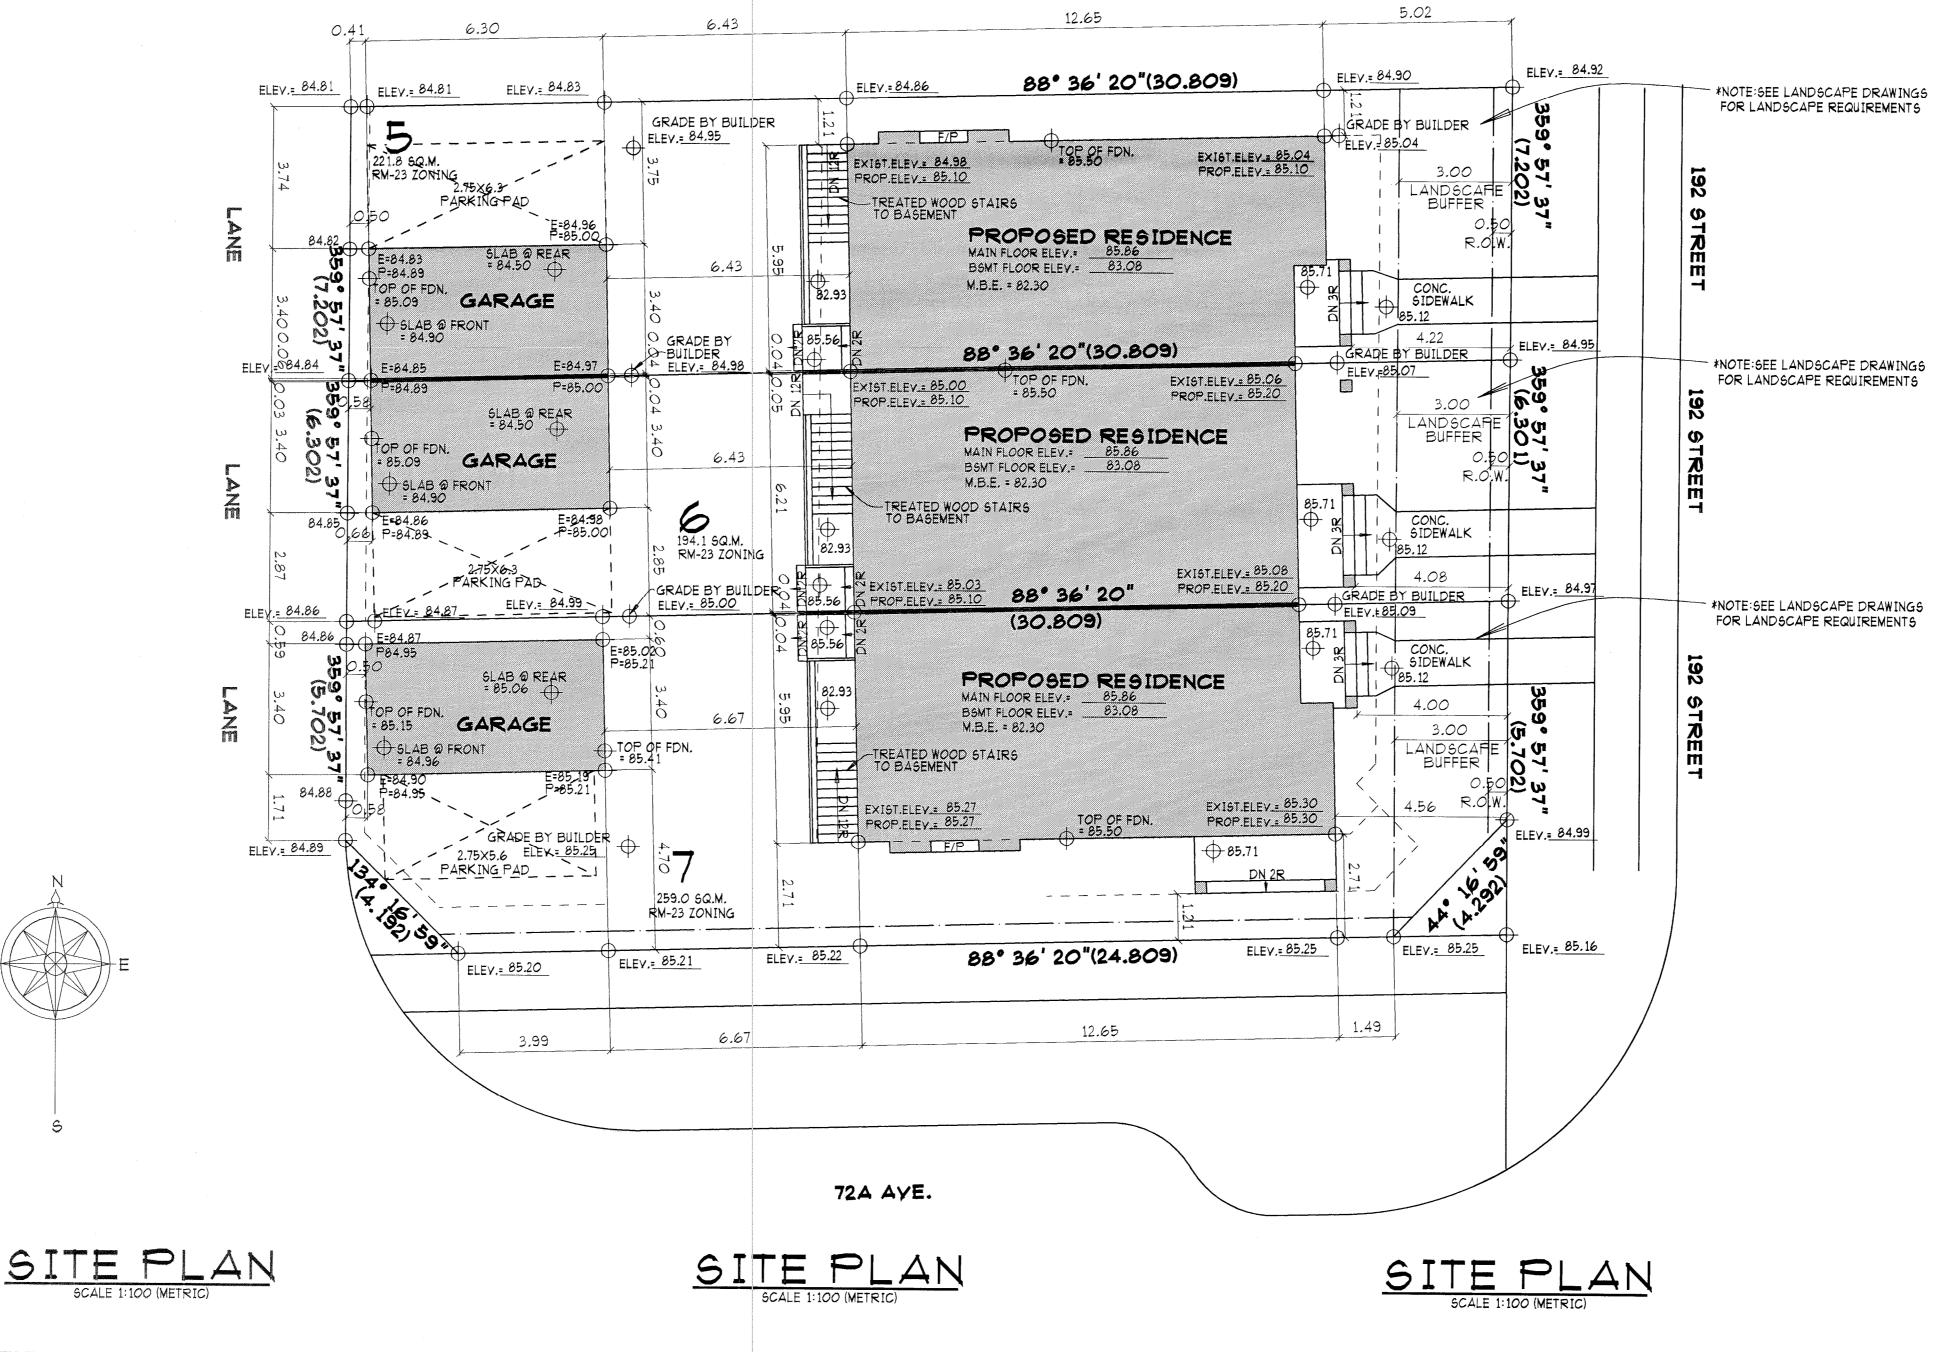

LOT CALCULATIONS: (LOT 5) RM-23 ZONING LOT CALCULATIONS: (LOT 6) RM-23 ZONING LOT CALCULATIONS: (LOT 7) RM-23 ZONING LOT AREA = 221.8 SQ.M. (2387.4 SQ.FT.) LOT AREA = 194.1 SQ.M. (2089.3 SQ.FT.) LOT AREA = 259.0 SQ.M. (2787.8 SQ.FT.) FLOOR AREA RATIO: FLOOR AREA RATIO: FLOOR AREA RATIO: MAX. ALLOWABLE FLOOR AREA = 1550.0 SQ.FT. MAX. ALLOWABLE FLOOR AREA = 1550.0 SQ.FT. MAX. ALLOWABLE FLOOR AREA = 1550.0 SQ.FT. PROPOSED : PROPOSED : PROPOSED : HOUSE = 1548 HOUSE = 1550 HOUSE = 1548 GARAGE = 234 (COUNT O) GARAGE = 234 (COUNT O) GARAGE = 231 (COUNT O) TOTAL = 1548 SQ.FT. TOTAL = 1550 SQ.FT. TOTAL = 1548 9Q.FT. SITE COVERAGE: SITE COYERAGE: SITE COYERAGE: MAX. ALLOWABLE @ 0.60 = 1432.4 SQ.FT. MAX. ALLOWABLE @ 0.60 = 1253.5 SQ.FT. MAX. ALLOWABLE @ 0.50 = 1393.9 SQ.FT. PROPOSED = 1072.3 SQ.FT. PROPOSED = 1119.7 SQ.FT. PROPOSED = 1129.5 SQ.FT. UNDERGROUND BASEMENT YOLUME: UNDERGROUND BASEMENT YOLUME: UNDERGROUND BASEMENT YOLUME: AYG. EXISTING BLDG. GRADE = AYG. EXISTING BLDG. GRADE = AYG. EXISTING BLDG. GRADE = (84.98+ 85.04+ 85.00+ 85.06) / 4 = 85.02 (85.00+ 85.06+ 85.03+ 85.08) / 4 = 85.04 (85.03+ 85.08+ 85.27+ 85.30) / 4 = 85.17 50% UNDERGROUND ACHIEVED AT SLAB LEYEL 50% UNDERGROUND ACHIEVED AT SLAB LEVEL 50% UNDERGROUND ACHIEVED AT SLAB LEVEL (85.02 - 1.39) = 83.63(85.04-1.39) = 83.65 (85.17-1.39) = 83.78 BASEMENT SLAB = 83.08 (69.8% UNDERGROUND EXISTING) BASEMENT SLAB = 83.08 (70.5% UNDERGROUND EXISTING) BASEMENT SLAB = 83.08 (75.2% UNDERGROUND EXISTING) UNDERGROUND BASEMENT YOLUME: UNDERGROUND BASEMENT YOLUME: UNDERGROUND BASEMENT YOLUME: AYG. PROPOSED BLDG. GRADE = AVG. PROPOSED BLDG. GRADE = AYG. PROPOSED BLDG. GRADE = (85.10+85.10+85.10+85.20) / 4 = 85.125 (85.10+ 85.20+ 85.10+ 85.20) / 4 = 85.15 (85.10+ 85.20+ 85.27+ 85.30) / 4 = 85.217 50% UNDERGROUND ACHIEVED AT SLAB LEVEL 50% UNDERGROUND ACHIEVED AT SLAB LEVEL 50% UNDERGROUND ACHIEVED AT SLAB LEYEL (85.125 - 1.39) = 83.73(85.15 - 1.39) = 83.76(85.217 - 1.39) = 83.82BASEMENT SLAB = 83.08 (73.5% UNDERGROUND PROPOSED) BASEMENT SLAB = 83.08 (74.4% UNDERGROUND PROPOSED) BASEMENT SLAB = 83.08 (76.8% UNDERGROUND PROPOSED)

# GENERAL:

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# THE BUILDING SITE:

LOT GEOMETRY AND TOPOGRAPHICAL INFORMATION HAS BEEN OBTAINED FROM SOURCES BELIEVED TO BE RELIABLE. HOWEVER, ERRORS CAN AND DO OCCUR ON LEGAL AND TOPGRAPHICAL SURVEYS. AS WE RELY ON THIS INFORMATION, WE ARE NOT RESPONSIBLE FOR ANY ERRORS WHICH OCCUR AS A RESULT OF THE USE OF INACCURATE SITE DATA, IT IS THE OWNER'S RESPONSIBILITY TO ENSURE THAT SITE DATA IS CORRECT.

EXISTING GRADES INDICATED AT THE CORNERS OF THE STRUCTURE ARE BASED ON LINEAR INTERPOLATION OF THE TOPOGRAPHICAL DATA PROVIDED TO US. THOUGH THIS IS A GENERALLY ACCEPTED METHOD OF DETERMINING EXISTING ELEVATIONS AT THE CORNERS OF THE STRUCTURE IT IS NOT PERFECT AS THERE IS SELDOM A PERFECT LINEAR RELATIONSHIP BETWEEN ANY TWO POINTS ON THE SITE. FOR EXAMPLE, A NOLE OR DEPRESSION OCCURRING BETWEEN ANY TWO POINTS ON THE SITE WOULD NOT BE ANTICIPATED BY THE LINEAR INTERPOLATION METHOD. IF YOU REQUIRE PERFECTLY ACCURATE EXISTING GRADE INFORMATION, YOU MUST EMPLOY A REGISTERED LAND SURVEYOR TO MEASURE THE ACTUAL ELEVATION AT WHICH THE EXTERIOR CORNERS OF THE STRUCTURE INTERSECT THE LOT.

THE OWNER OR BUILDER IS TO SUPPLY ANY MISSING DIMENSIONS REQUIRED ON THE SITE PLAN IN ADDITION TO THE LEGAL DESCRIPTION NAME OF STREETS, NORTH ARROW, LOCATION OF SERVICES, ETC. ALL DIMENSIONS SHOWN ON THE SITE PLAN AND THE LOCATION OF ANY EASEMENTS OR RIGHT OF WAYS ARE TO BE APPROVED BY BUILDING AUTHORITIES BEFORE COMMENCING CONSTRUCTION.

GRADE IS TO SLOPE A MINIMUM OF TWO PERCENT AWAY FROM THE STRUCTURE FOR SURFACE WATER RUN-OFF. THE BUILDER IS RESPONSIBLE FOR REQUIRED SWALES, AND TO ENSURE THAT ELEVATIONS SHOWN ON THE SITE PLAN ARE ACCURATE BEFORE EXCAVATION TAKES PLACE. THIS IS EXTREMELY IMPORTANT TO ENSURE THAT EXISTING OVERLAND WATER FLOW PATTERNS ARE

ANY RETAINING WALLS REQUIRED ARE TO BE BUILT ACCORDING TO GOOD PRACTICE, AND ARE ENTIRELY THE RESPONSIBILITY OF OTHERS.

THE DESIGNER SHALL NOT BE RESPONSIBLE FOR SITE CONDITIONS SUCH AS SOIL BEARING CAPACITY, DEPTH OF FROST LINES, WATER TABLES, UNDERGROUND SPRINGS, BURIED STRUCTURES, OR BURIED ORGANIC MATERIAL, FOUNDATIONS SLIPPAGE DUE TO CLAY OR OTHER MATERIALS, OR FOUNDATION CRACKING DUE TO SITING A HOME ON UNEVEN BEARING.

# CLIMATE AND SOIL:

SLIMATIC VALUES REQUIRED FOR THE DESIGN OF THIS STRUCTURE SHALL BE IN CONFORMANCE WITH THE VALUES ESTABLISHED BY THE AUTHORITY HAVING JURISDICTION. THESE DRAWINGS MAY NEED TO BE ALTERED IN CON-SIDERATION OF GROUND SNOW LOADS, RAIN LOADS, WIND LOADS, SEISMIC ZONE, SOIL CONDITIONS, FROST PENETRATION LEVELS, AND OTHER FACTORS BEYOND THE SCOPE OF THESE DRAWINGS. IT IS THE RESPONSIBILITY OF THE OWNER TO DETERMINE THESE CONDITIONS AND TO HIRE THE APPROPRIATE LOCAL PROFESSIONA TO MAKE ANY NECESSARY ADJUSTMENTS TO THESE PLANS. ASSUMED VALUES: GROUND SNOW LOAD: 60 PSF RAIN LOAD: 8 PSF

WIND LOAD: MAX 80 KPH (50 MPH)

TO U.S. SEISMIC ZONE 4 STANDARD

FROST PENETRATION: 450mm (1'-6")


SOIL BEARING CAPACITY: 1500 PSF

0				
	CIVIC ADDRESS:	BUILDING CODE: THESE PLANS CONFORM TO THE BRITISH COLUMBIA BUILDING CO 2006 EDITION. (OCCUPANCY GROUP		
		CUSTOMER LEGE		HOME
	LEGAL	DESIGN:	MS	
	DESCRIPTION:	DRAWN:	DY	120316
	LOT #5,6,7	CHECKED:	MS	120319
		SCA	ALE: 1:100 (	METRIC)
00000				

-10C

SHEET 1 OF 6 REV: 0

 $\boldsymbol{\omega}$ SEIZMIC: NOT RATED-INQUIRE ABOUT UPGRADE **|--||||** 

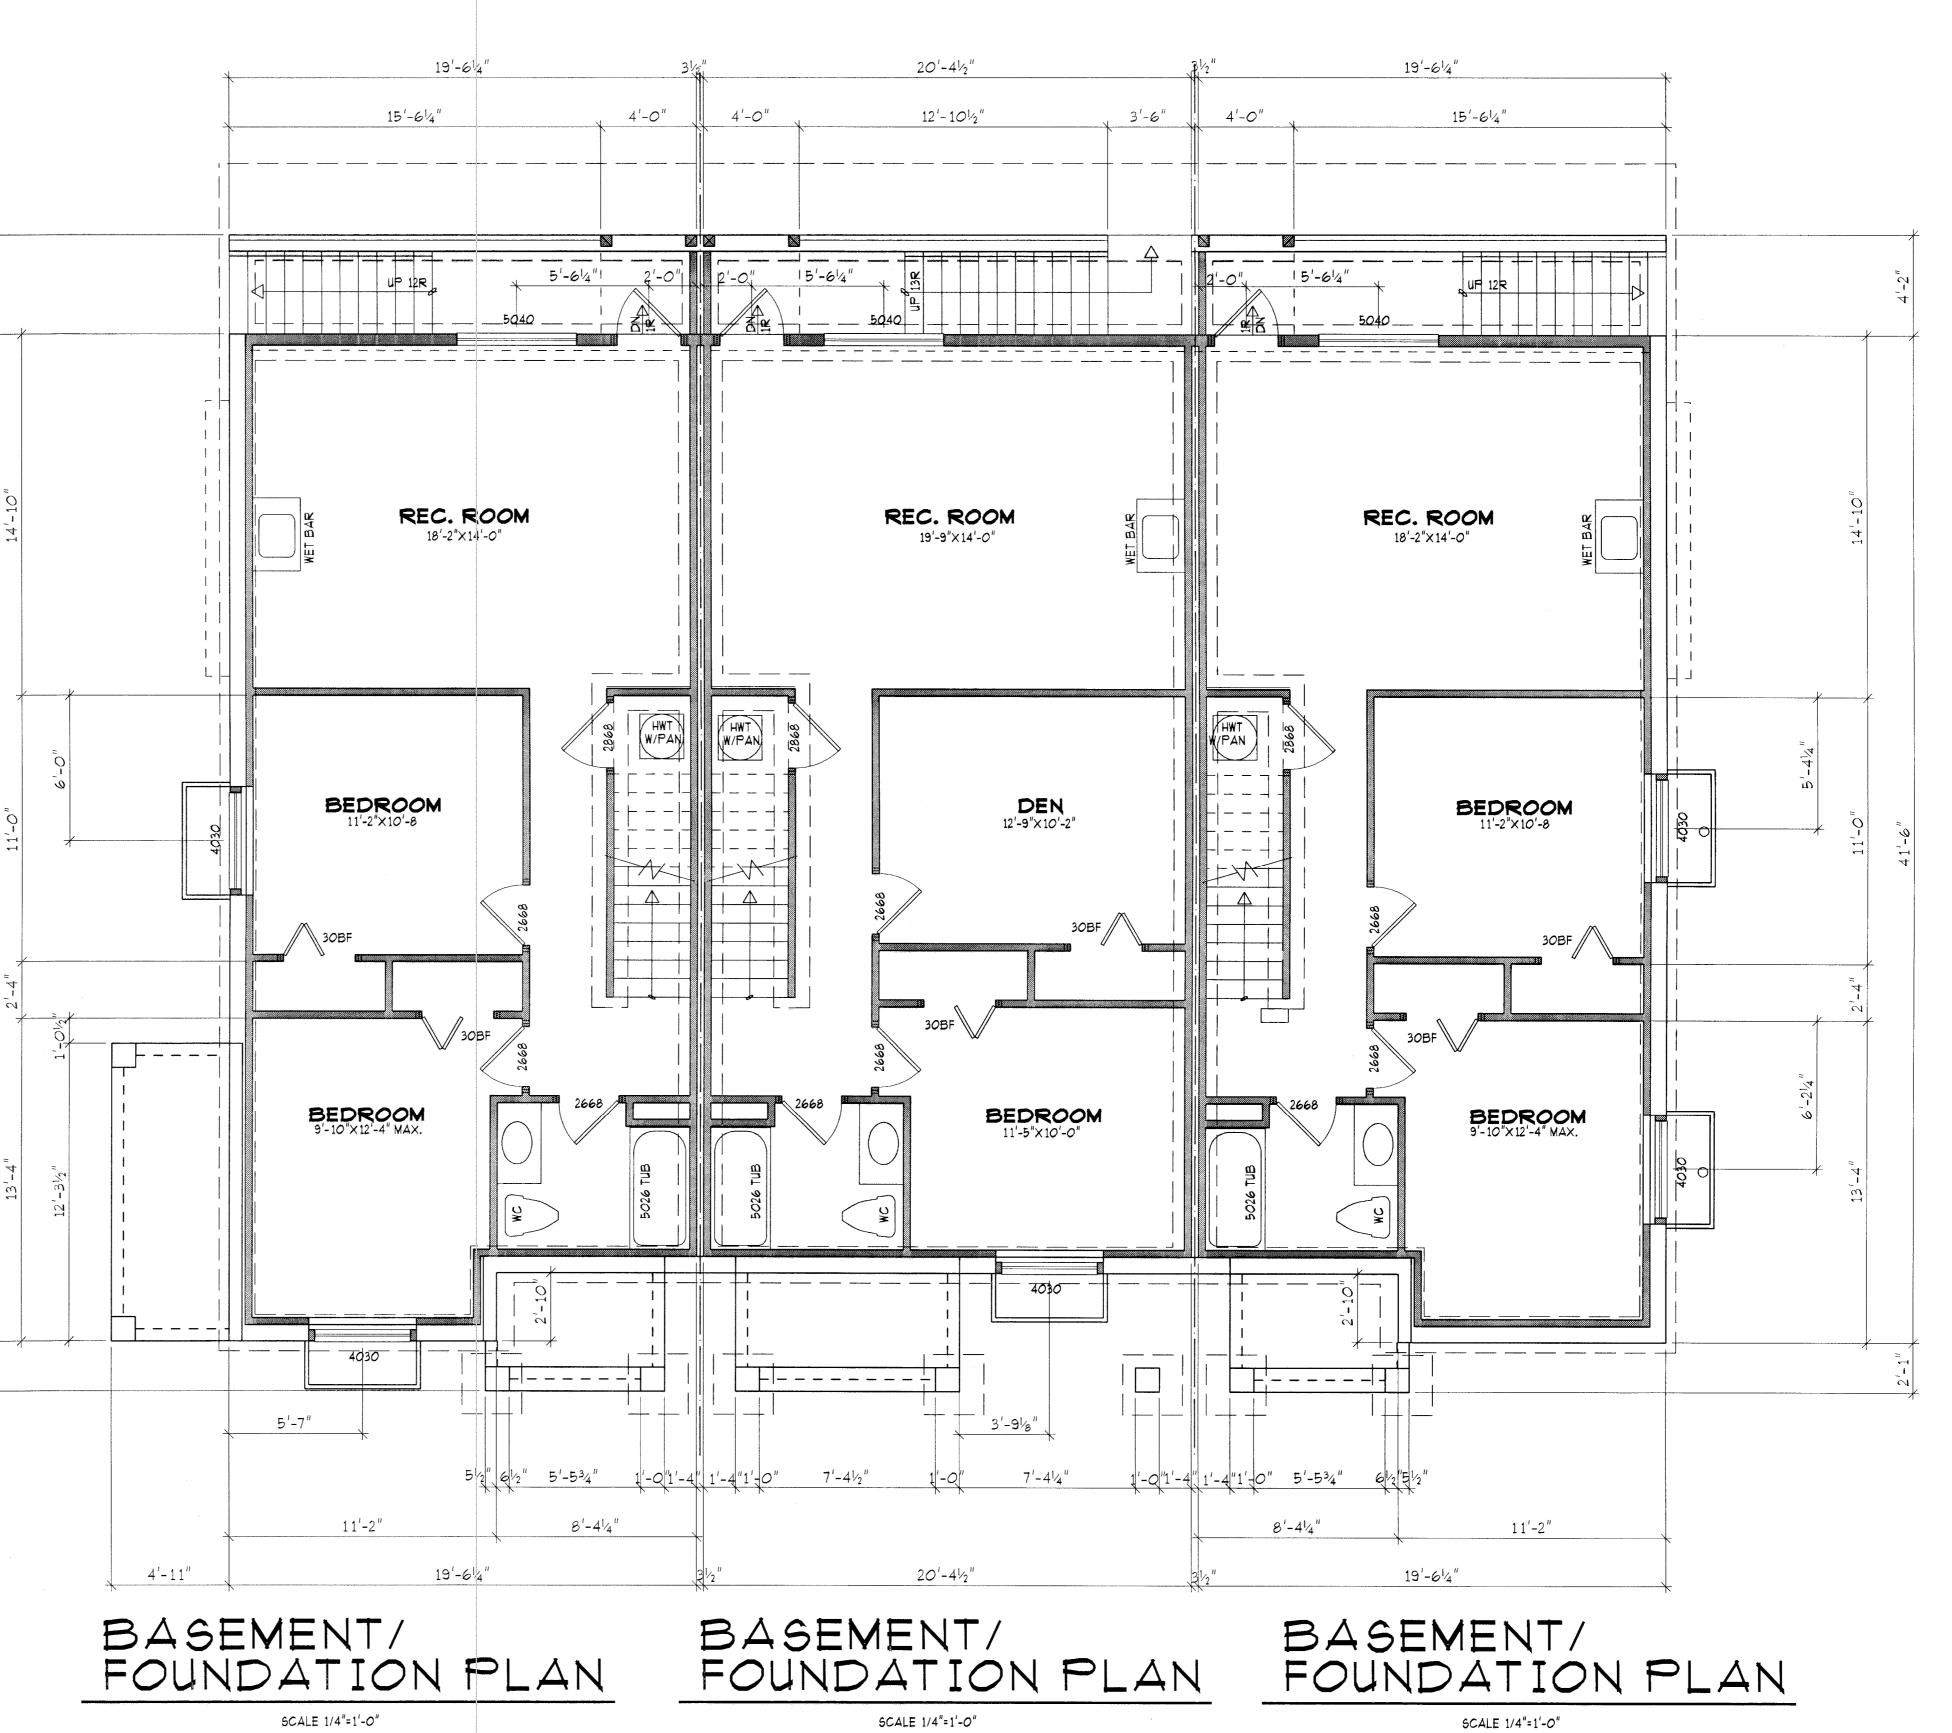

SCALE 1/4"=1'-0" 799 SQ. FT.

792 SQ. FT.

792 SQ. FT.

BUILDING CODE:
THESE PLANS CONFORM TO THE
BRITISH COLUMBIA BUILDING CODE
2006 EDITION. (OCCUPANCY GROUP C)


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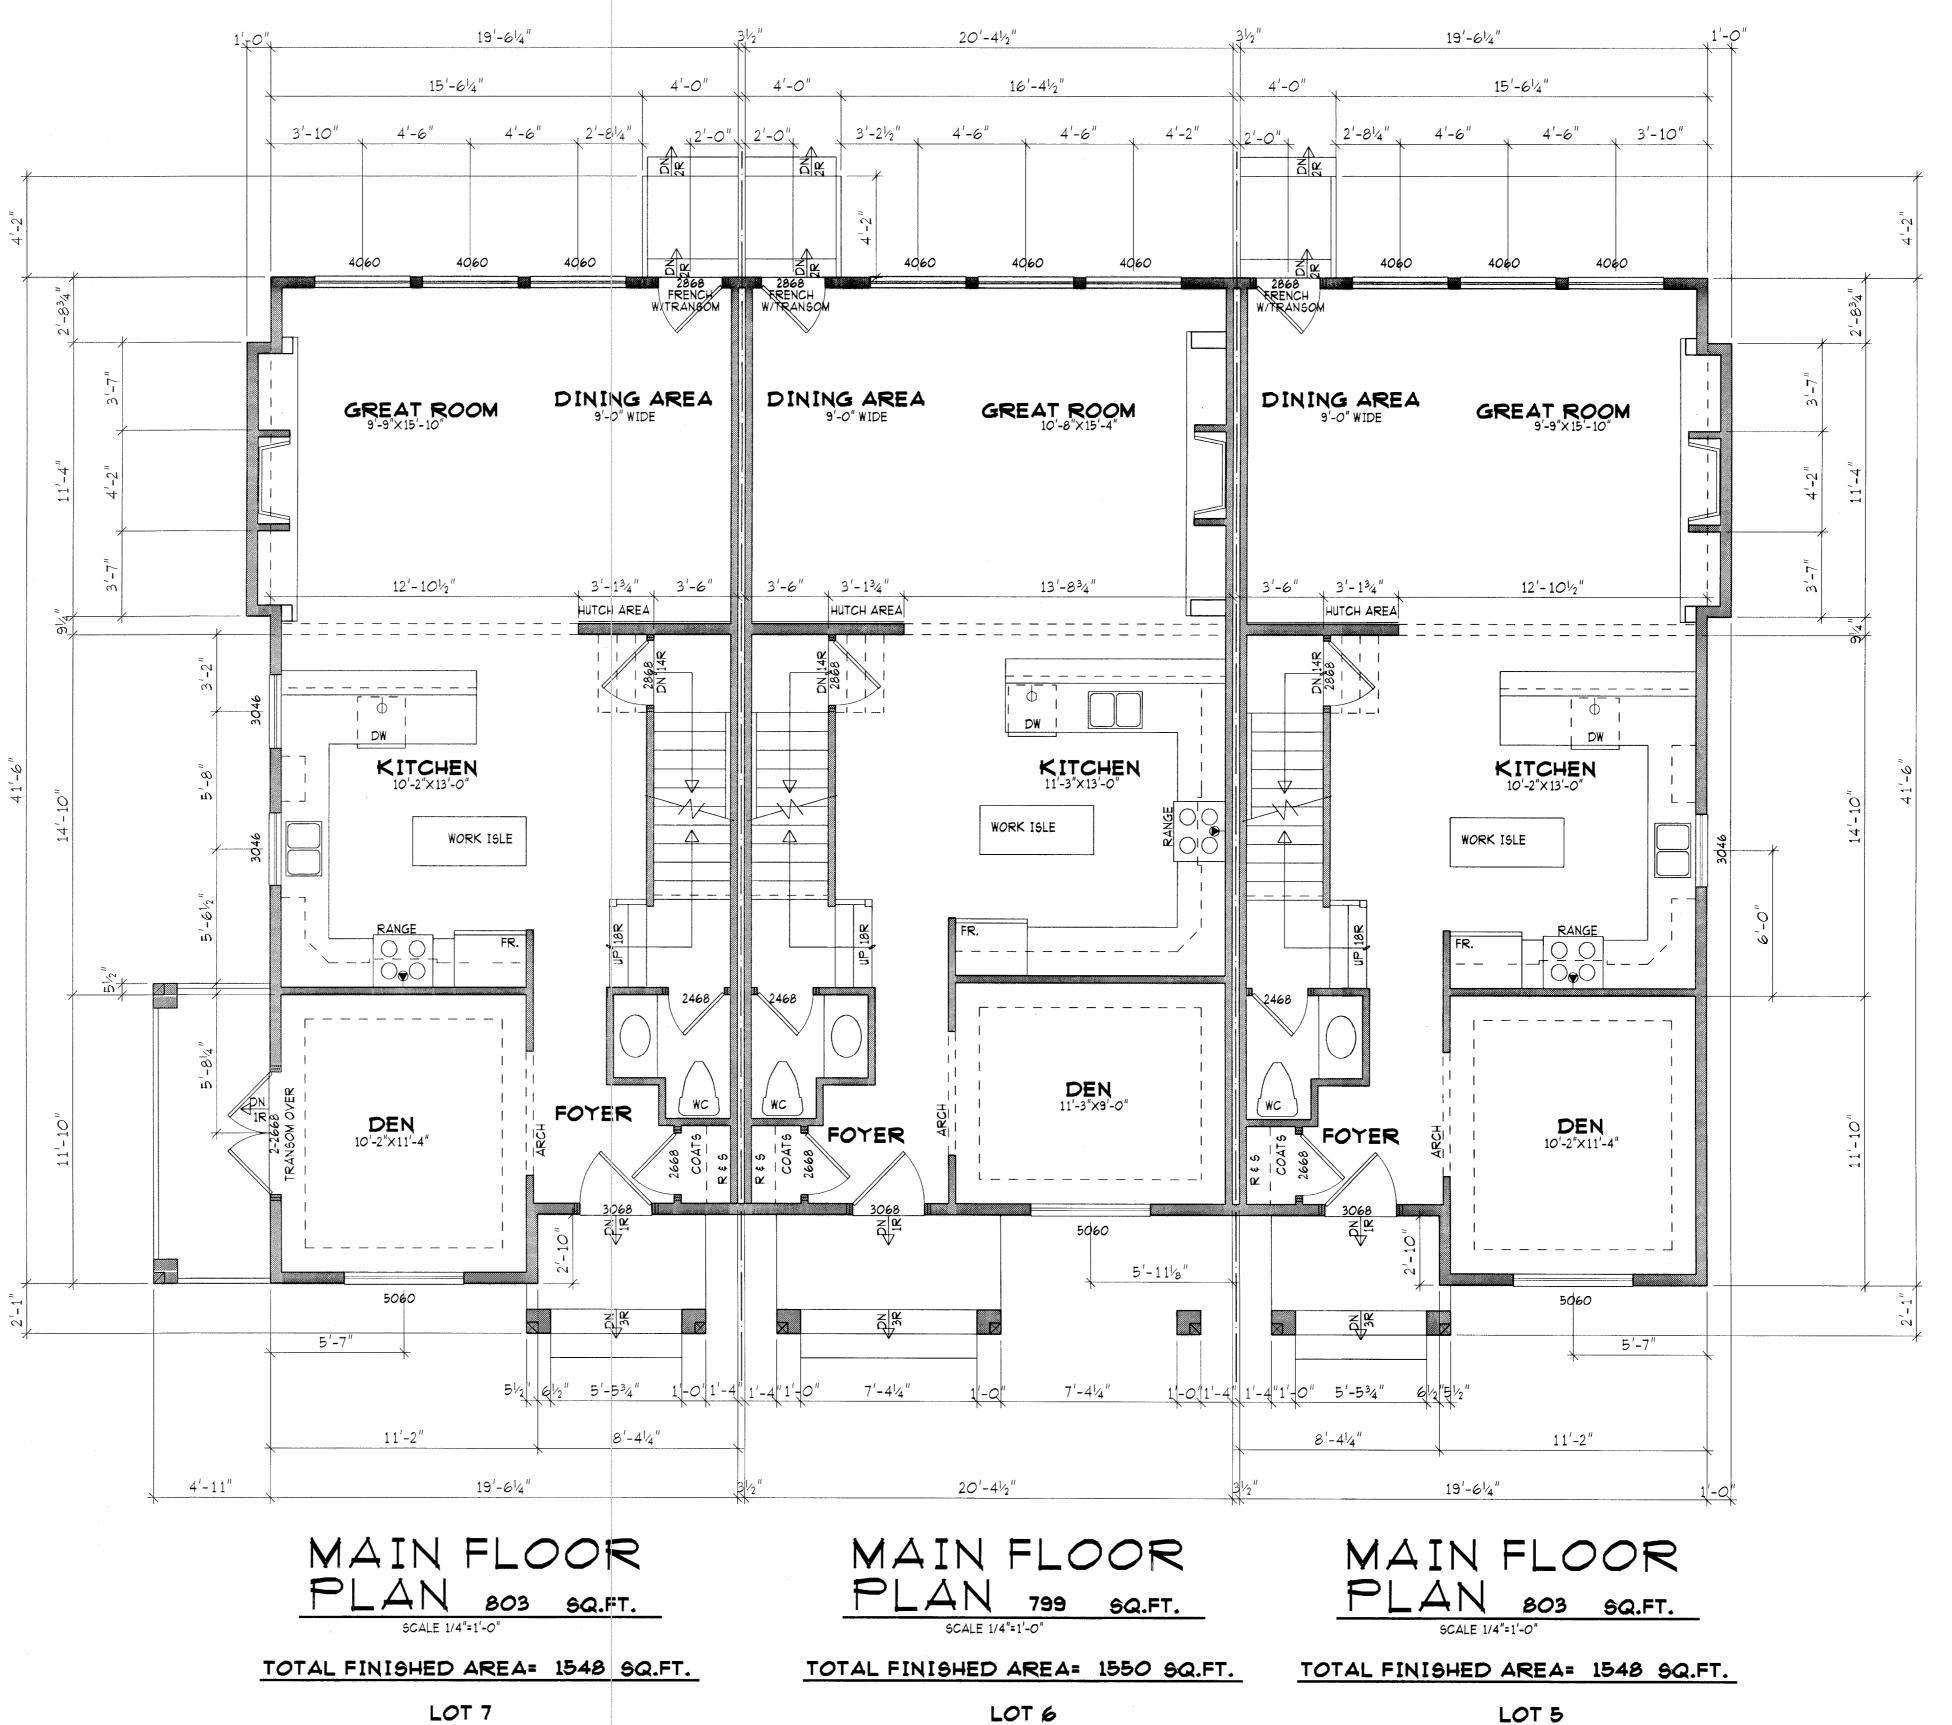
CUSTOMER: LEGENDARY HOMES DESIGN: DRAWN: DV CHECKED: MS SCALE: 1/4" = 1'-0"

T-100

REVISED: 120410 SHEET 2 OF 6 REV: O





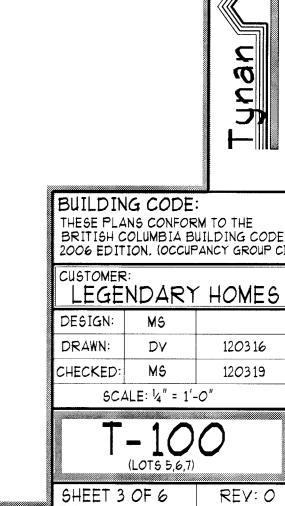


LOT 6


LOT 5

REVISED: 120410-WDW @ KIT.



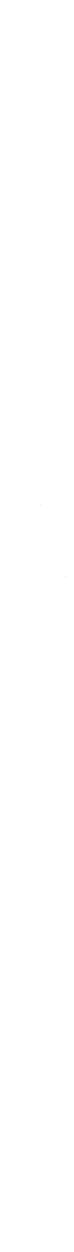




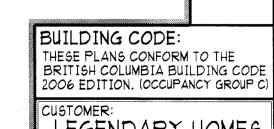

CUSTOMER:	IDARY	HOME
DESIGN:	MS	
DRAWN:	DV	120316
CHECKED:	MS	120319
	E: 1/4" = 1'	-0"

T-100 SHEET 4 OF 6 REV: O

REVISED: 120410

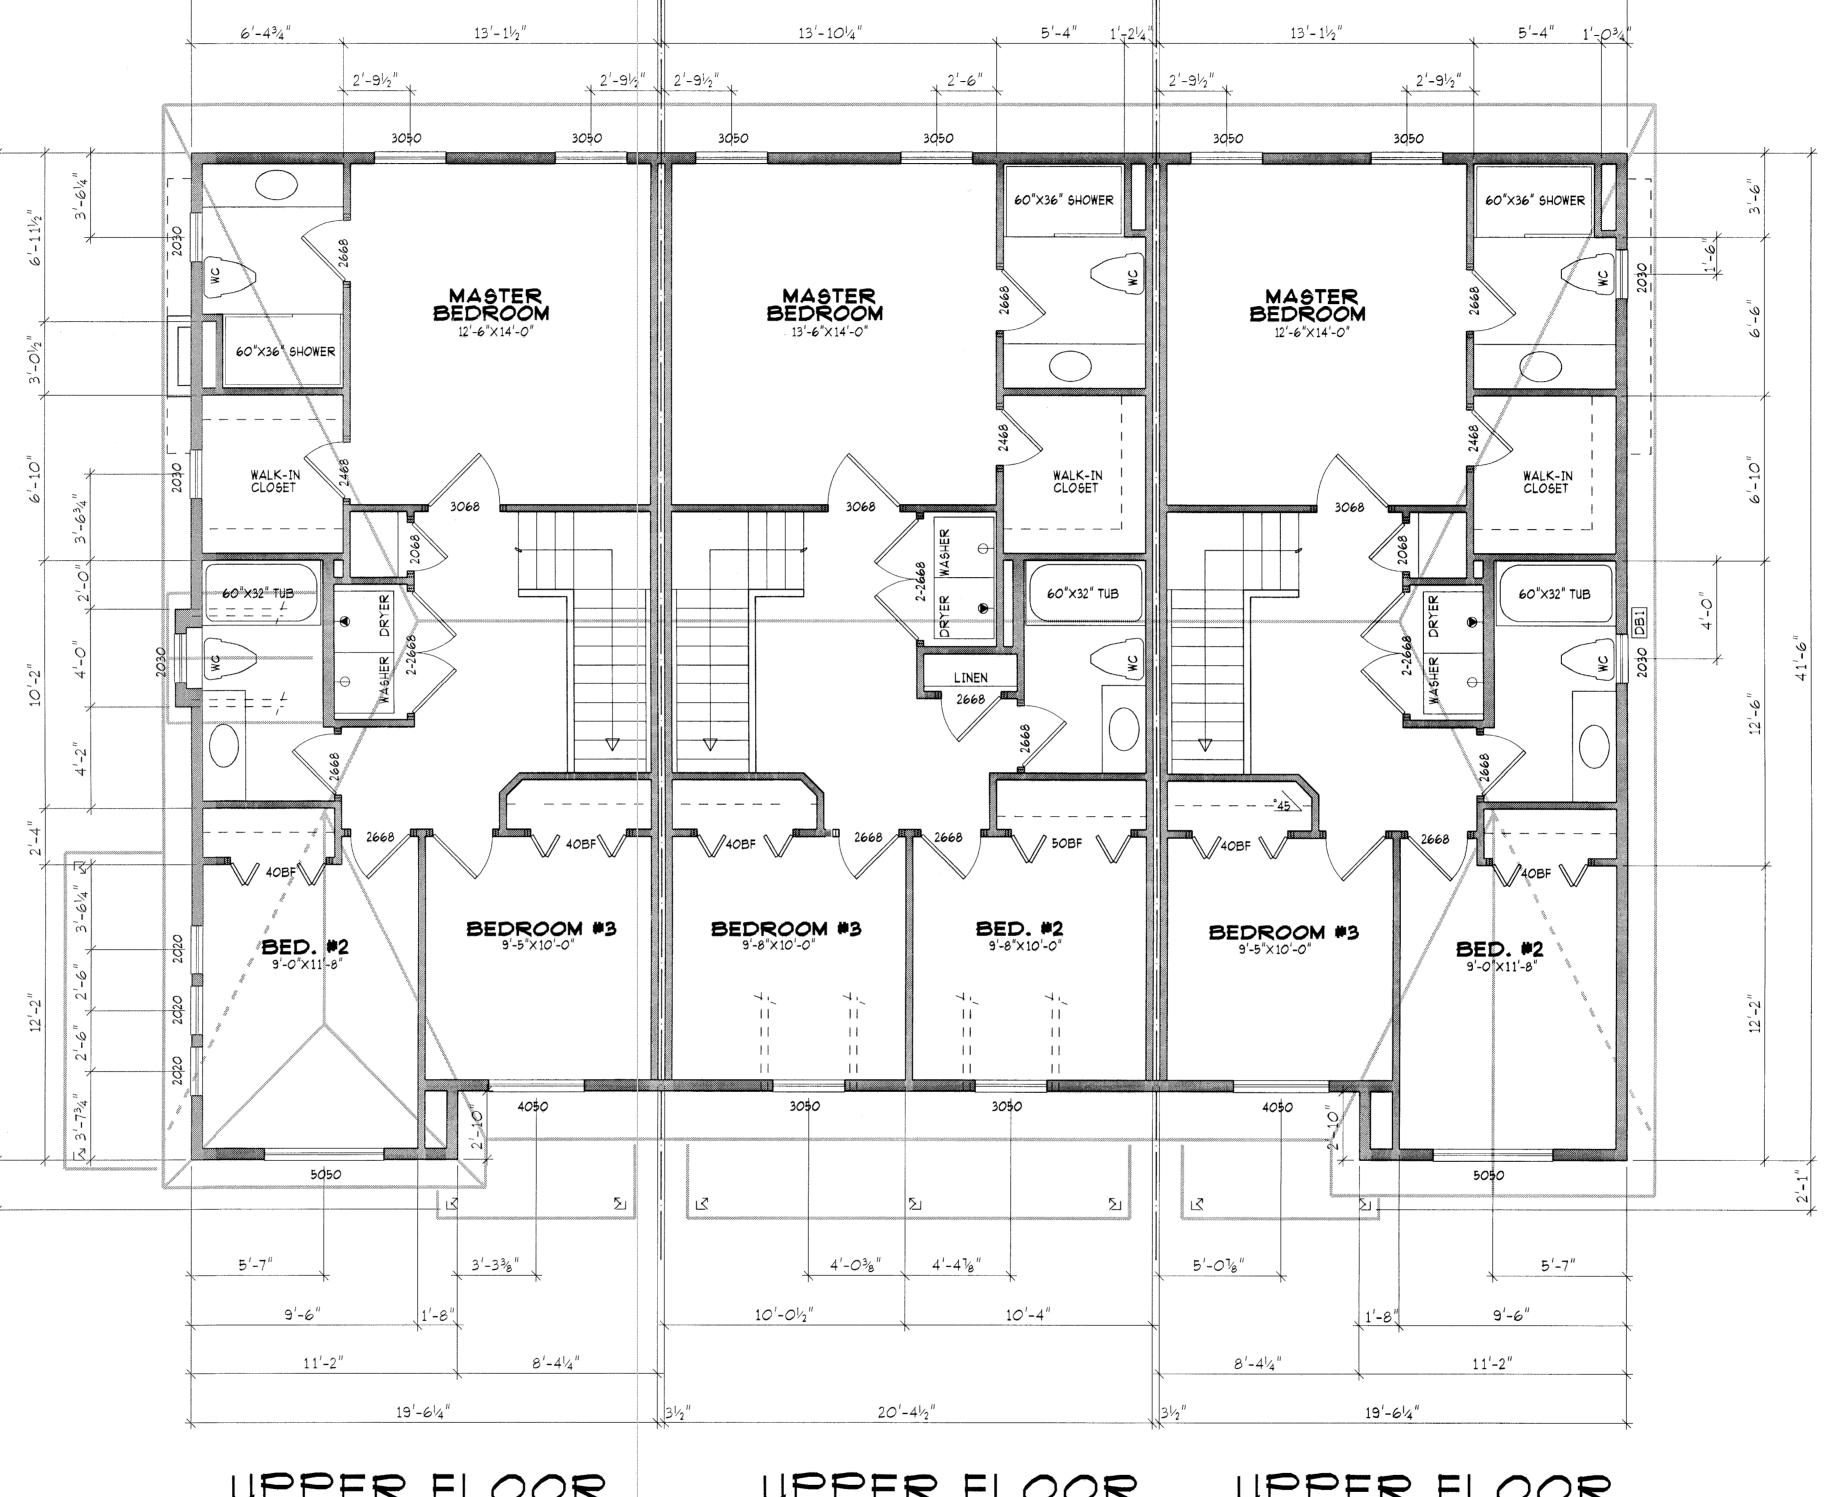

20'-41/2"

UPPER FLOOR
PLAN 745 9Q.FT.

9CALE 1/4"=1'-0"

19'-614"

UPPER FLOOR
PLAN 751 SQ.FT.

UPPER FLOOR
PLAN 745 9Q.FT.

19'-614"



BUILDING CODE:
THESE PLANS CONFORM TO THE
BRITISH COLUMBIA BUILDING CODE
2006 EDITION. (OCCUPANCY GROUP C)

CUSTOMER:
LEGENDARY HOMES

DESIGN: MS
DRAWN: DY 120316

S

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1—1

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4

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DESIGN: MS

DRAWN: DV 120316

CHECKED: MS 120319

SCALE: 1/4" = 1'-0"

T-100

REVISED: 120410

SHEET 5 OF 6 REV: O



Tynan

S

BUILDING CODE:
THESE PLANS CONFORM TO THE
BRITISH COLUMBIA BUILDING CODE
2006 EDITION. (OCCUPANCY GROUP C)

CUSTOMER:
LEGENDARY HOMES

DESIGN: MS

DRAWN: DV 120316

CHECKED: MS 120319


SCALE: 1/4" = 1'-0"


T - 100
(LOTS 5,6,7)


(LOTS 5,6,7)


REVISED: 1204 10

SHEET 6 OF 6 REV: 0

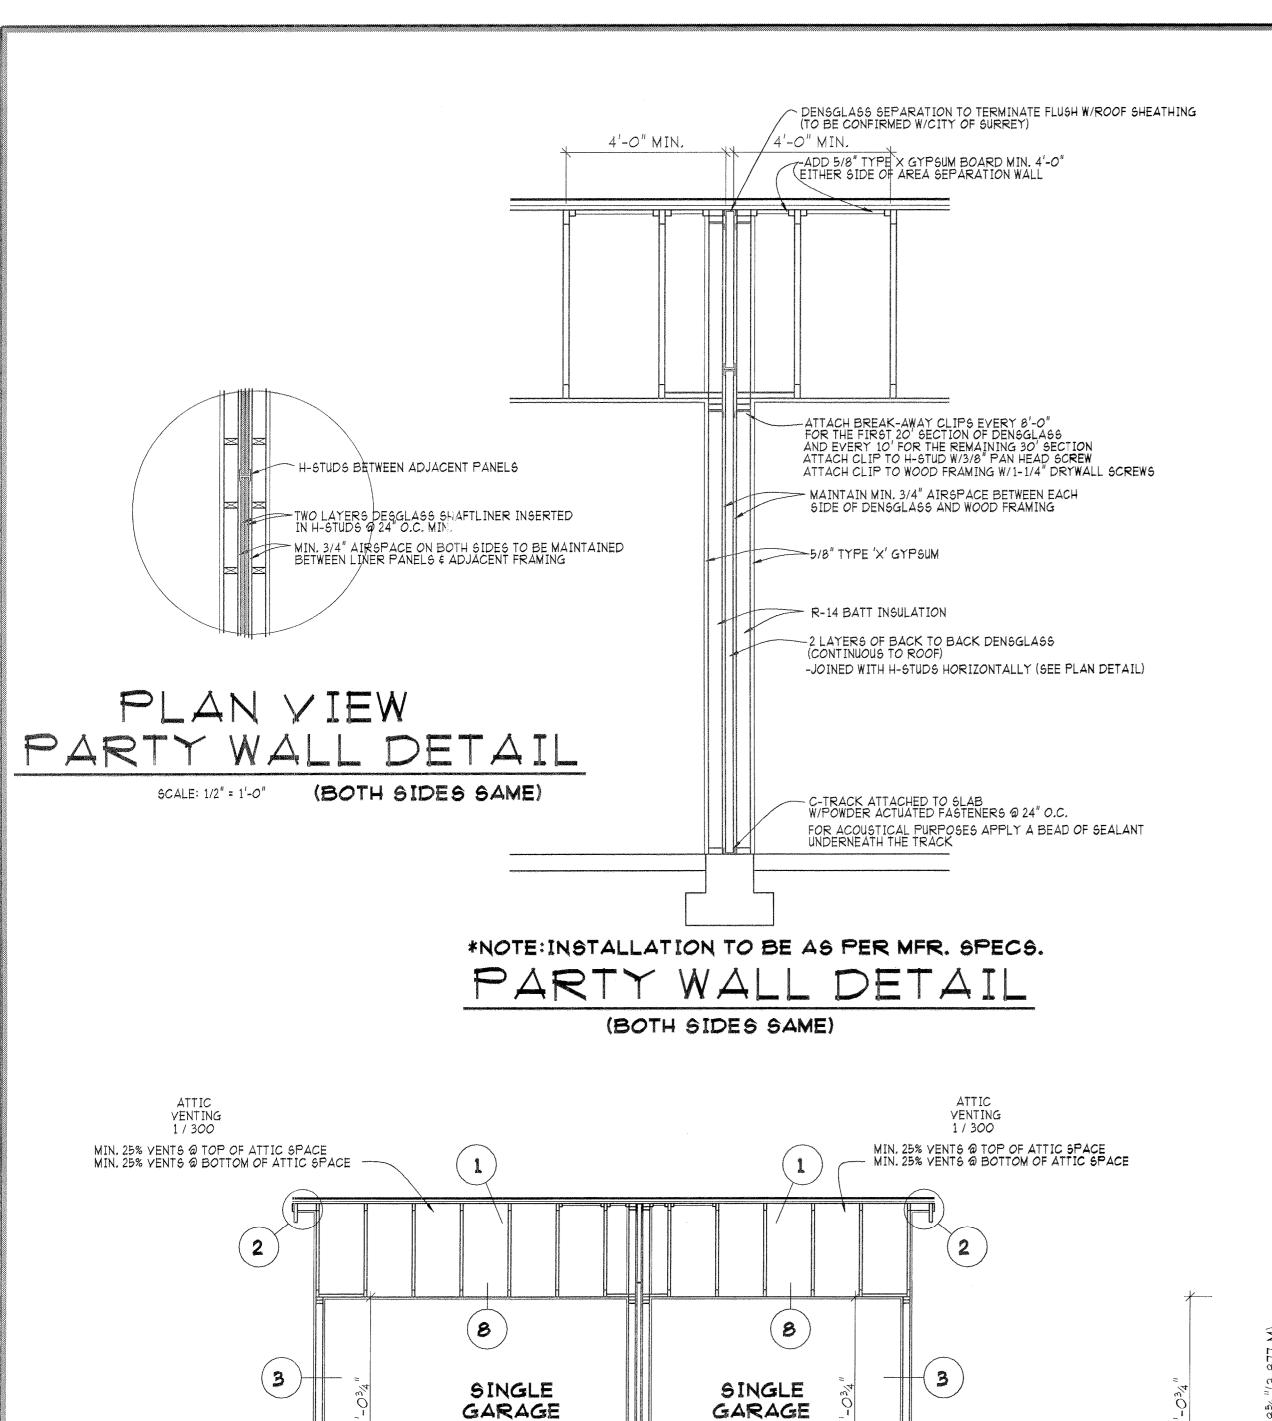


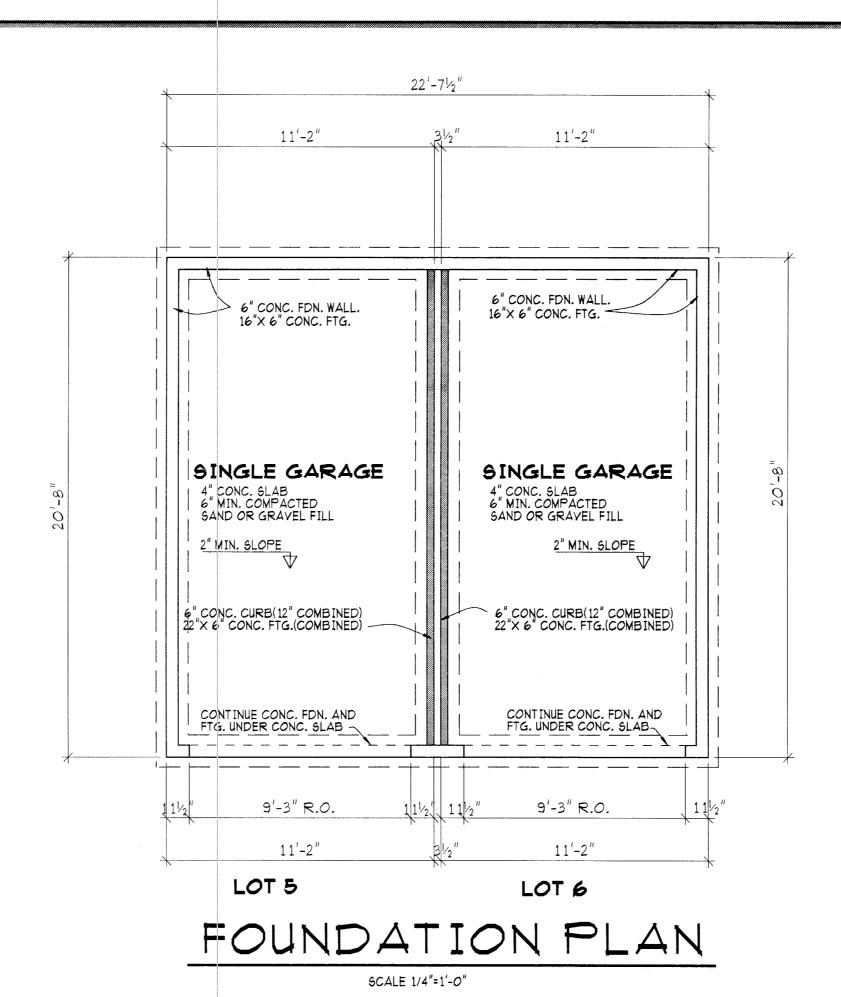

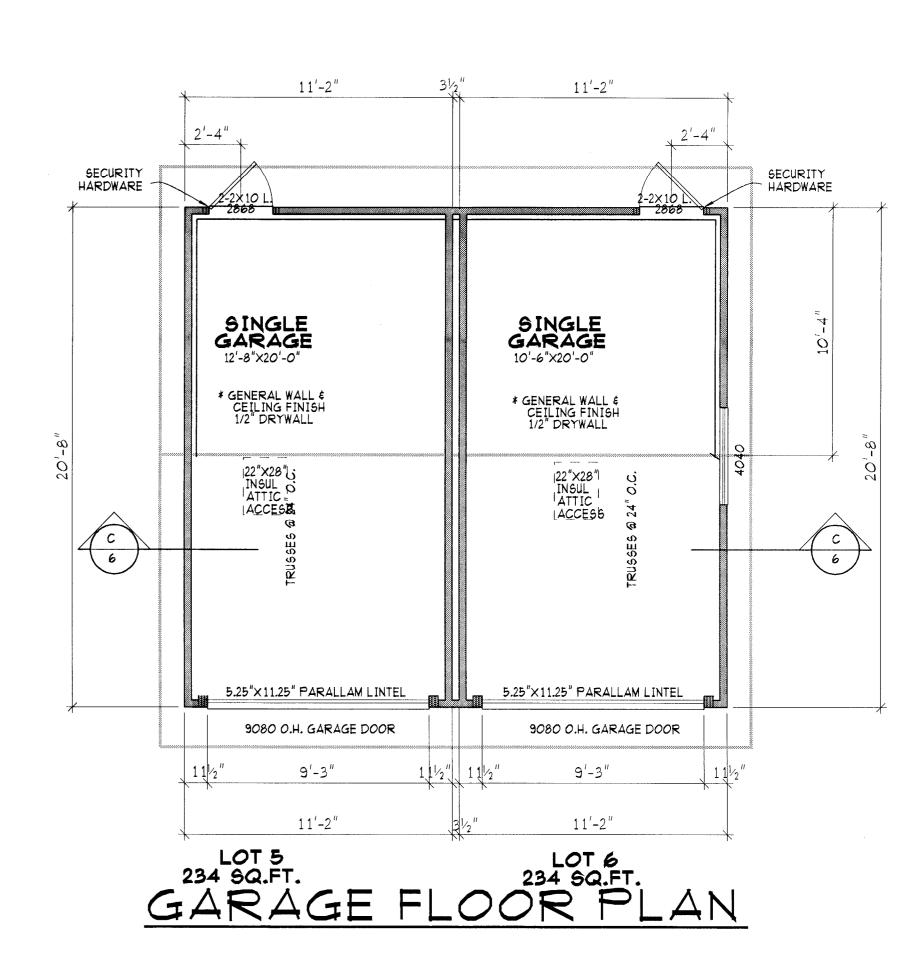


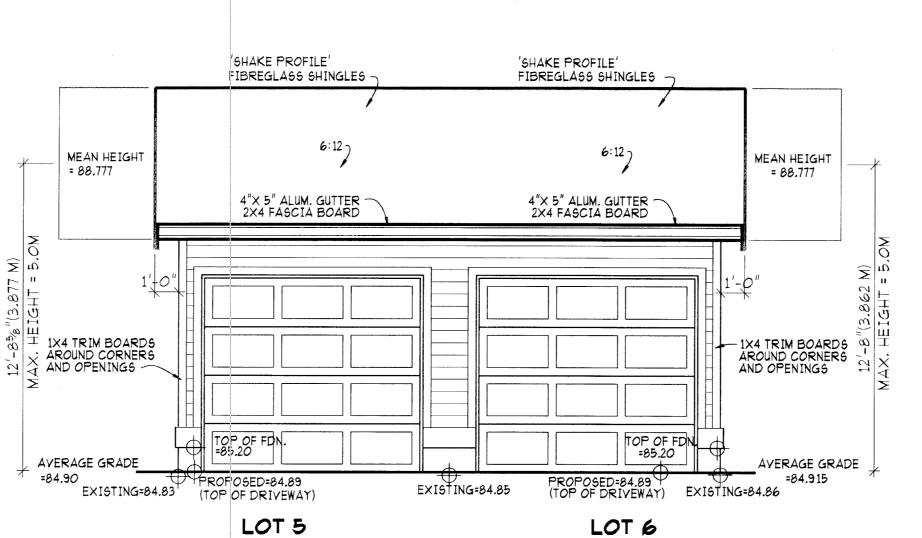


FRONT ELEVATION

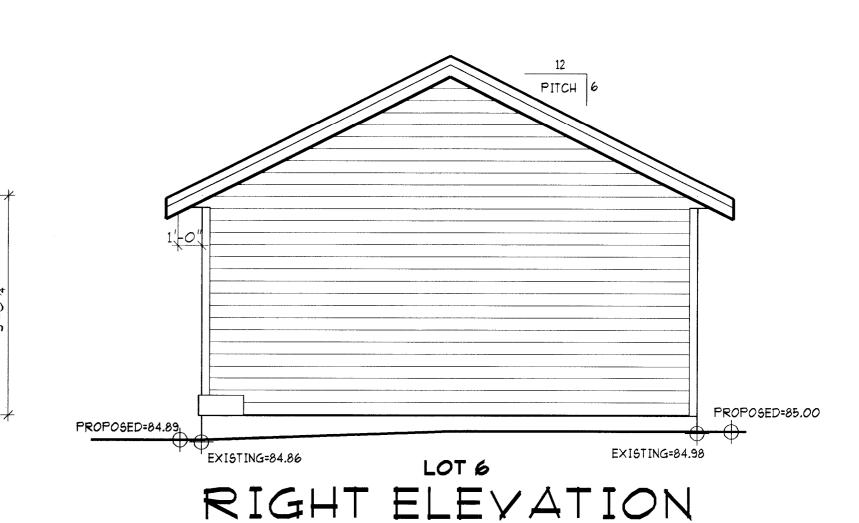

SCALE 1/4"=1'-0"

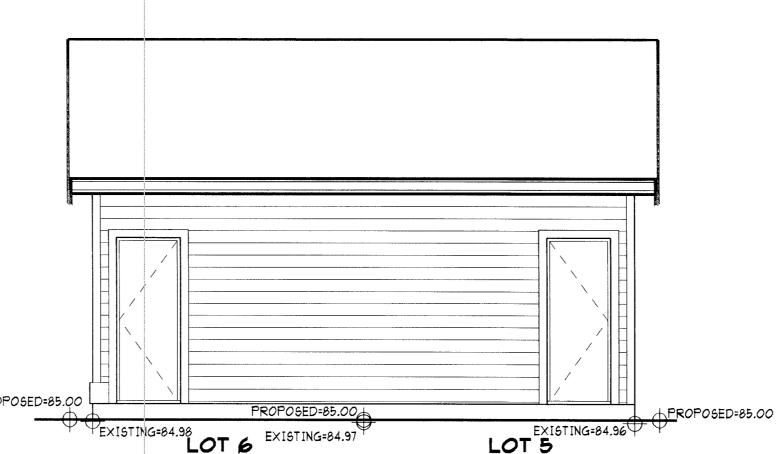

PROPOSED=85,00 PROPOSED=84.89 EXISTING=84.96 EXISTING=84.83 LOT 5 LEFT ELEVATION

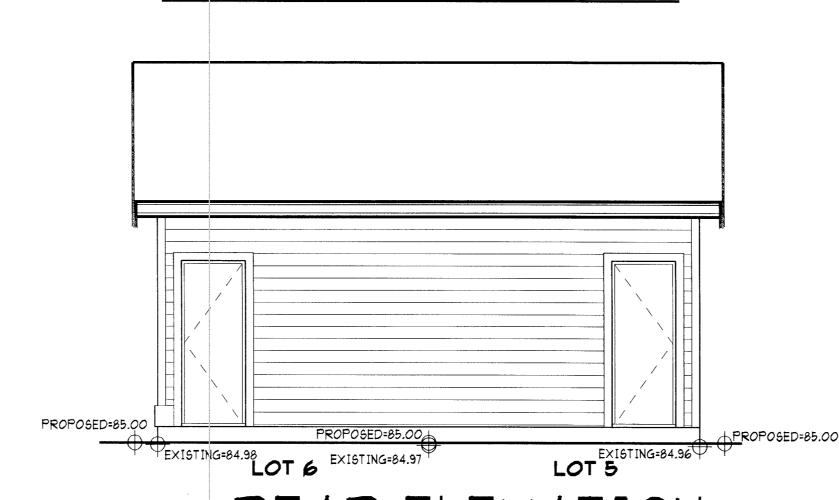

<u>\_\_\_PROPOSED=85.00</u> REAR ELEVATION

# SECTION C-C SCALE: 1/4" = 1'-0" SPECIFICATIONS:

- --- 'SHAKE PROFILE' FIBREGLASS SHINGLES FELT UNDERLAY 1/2" PLYWOOD SHEATHING ROOF TRUSSES @ 24" O.C.
- -- 4"imes5" ALUM GUTTER (OR AS NOTED) 2X4 FASCIA BOARD VENTED ALUM OR VINYL SOFFIT (NOTE: PROVIDE INSULATION BAFFLES BETWEEN EACH TRUSS W/ MIN 2.1/2" CLEAR AIRSPACE)
- EXTERIOR WALL: (3) FINISH MATERIAL - SEE ELEVATION STRAPPING AS PER 2006 BCBC BUILDING PAPER 3/8" PLYWOOD SHEATHING R-14 BATT INSULATION (OPTIONAL) 2×4 STUDS @ 16" O.C.
- EXTERIOR FOUNDATION WALL:

  APPROVED WATERPROOF MEMBRANE APPLY TO EXTERIOR PERIMETER UP TO GRADE 6" CONCRETE FOUNDATION WALL (OR AS NOTED) 16"X6" CONCRETE FOOTING
- PLATE TO FOUNDATION CONNECTION: - 2x6 (OR 2x4 AS REQ'D) SILL PLATE 6 MIL POLY OR 45# FELT DAMP-PROOFING 1/2" DIA ANCHOR BOLTS @ 6'-0" O.C. MAX
- 4" DRAIN TILE 12" MIN DRAIN ROCK
- MIN R-40 BATT OR LOOSE-FILL INSULATION (OPTIONAL) MIN 6 MIL POLY V.B. 5/8" GYPSUM BOARD
- --- 4" CONC SLAB (MIN 4" BELOW TOP OF FDN WALL) 6" MIN COMPACT SAND OR GRAVEL FILL


BUILDING CODE: THESE PLANS CONFORM TO THE BRITISH COLUMBIA BUILDING CODE 2006 EDITION. (OCCUPANCY GROUP C CUSTOMER: LEGENDARY HOMES DESIGN: DRAWN: DY 111201 CHECKED: MS 111205


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SCALE: 1/4" = 1'-0" T-100

SHEET 6 OF 6 REV: O




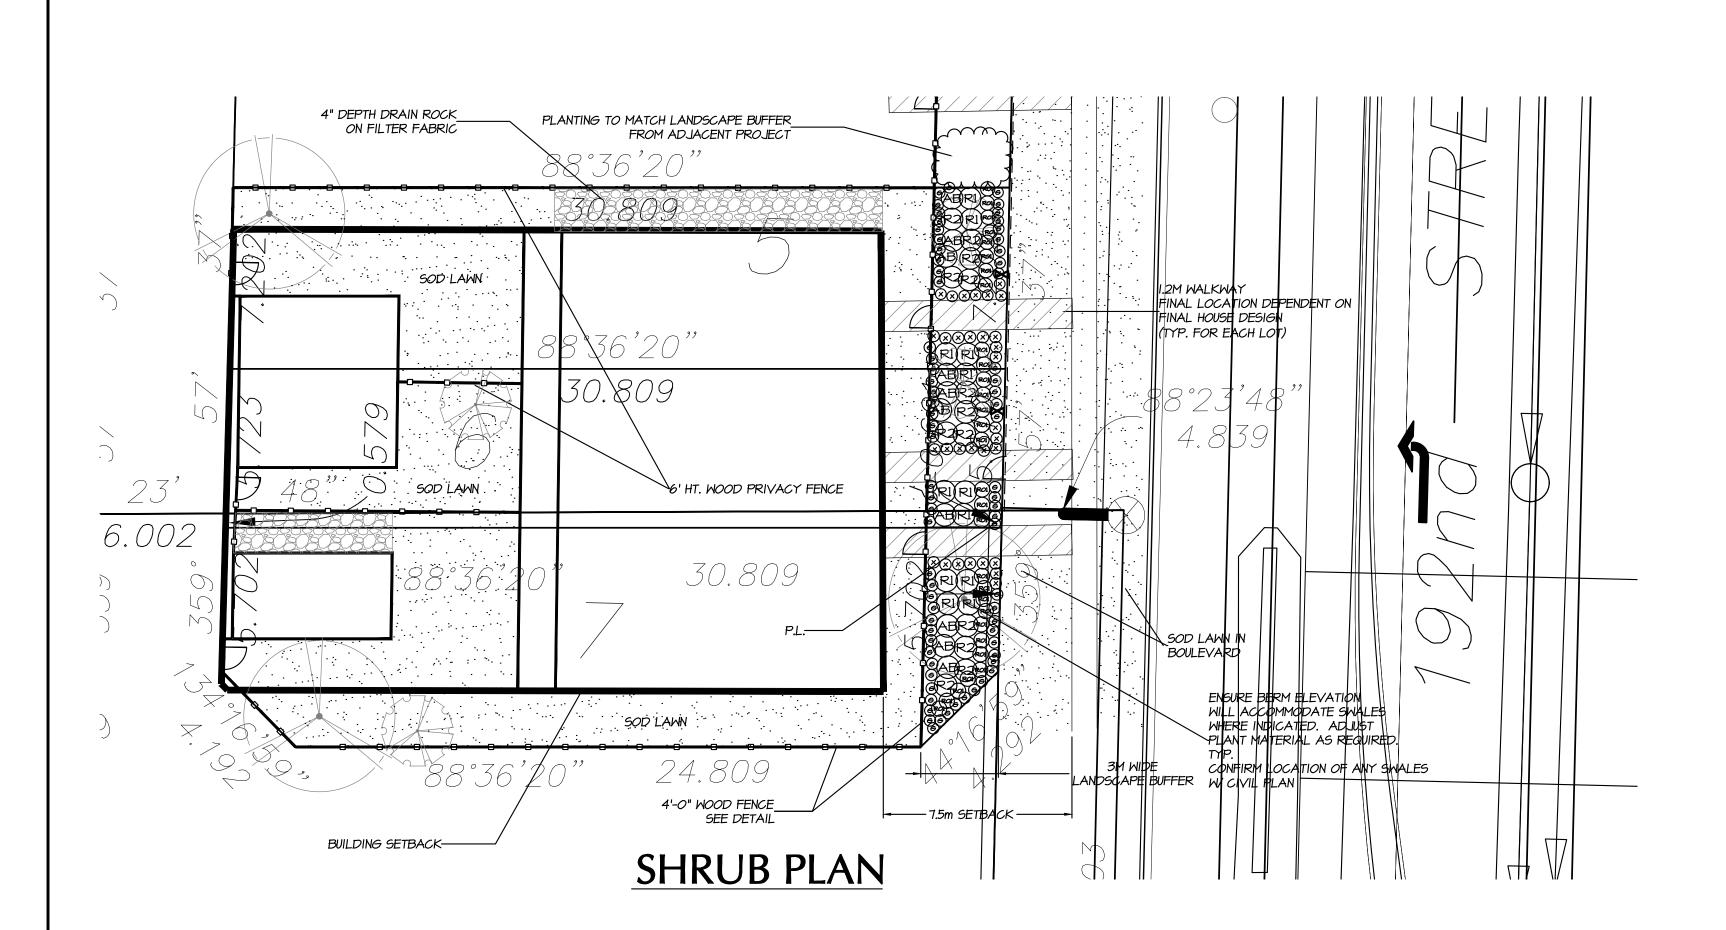


PLANT SCHEDULE DMG JOB NUMBER: 12-043 KEY QTY BOTANICAL NAME COMMON NAME PLANTED SIZE / REMARKS ACER PLATANOIDES NORWAY MAPLE 6CM CAL; I.8M STD; B&B CORNUS KOUSA 'CHINENSIS' CHINESE DOGWOOD 2.75M HT; BUSH FORM; B&B MALUS FLORABUNDA CRABAPPLE 6CM CAL; I.5M STD; B&B PINK ABELIA #3 POT; 50CM AB 1*0* ABELIA EDWARD GOUCHER RHODODENDRON; BLUE; APRIL RHODODENDRON 'BLUE DIAMOND' #2 POT; 20CM RHODODENDRON 'BOW BELLS' RHODODENDRON; PINK #2 POT; 20CM ROI 30 ROSA EXPLORER 'GEORGE VANCOUVER' GEORGE VANCOUVER ROSE; DEEP FUSCHIA #2 POT; 40CM X 32 ARCTOSTAPHYLOS UVA-URSI KINNIKINNICK #I POT; 20CM GAULTHERIA SHALLON #I POT; 20CM

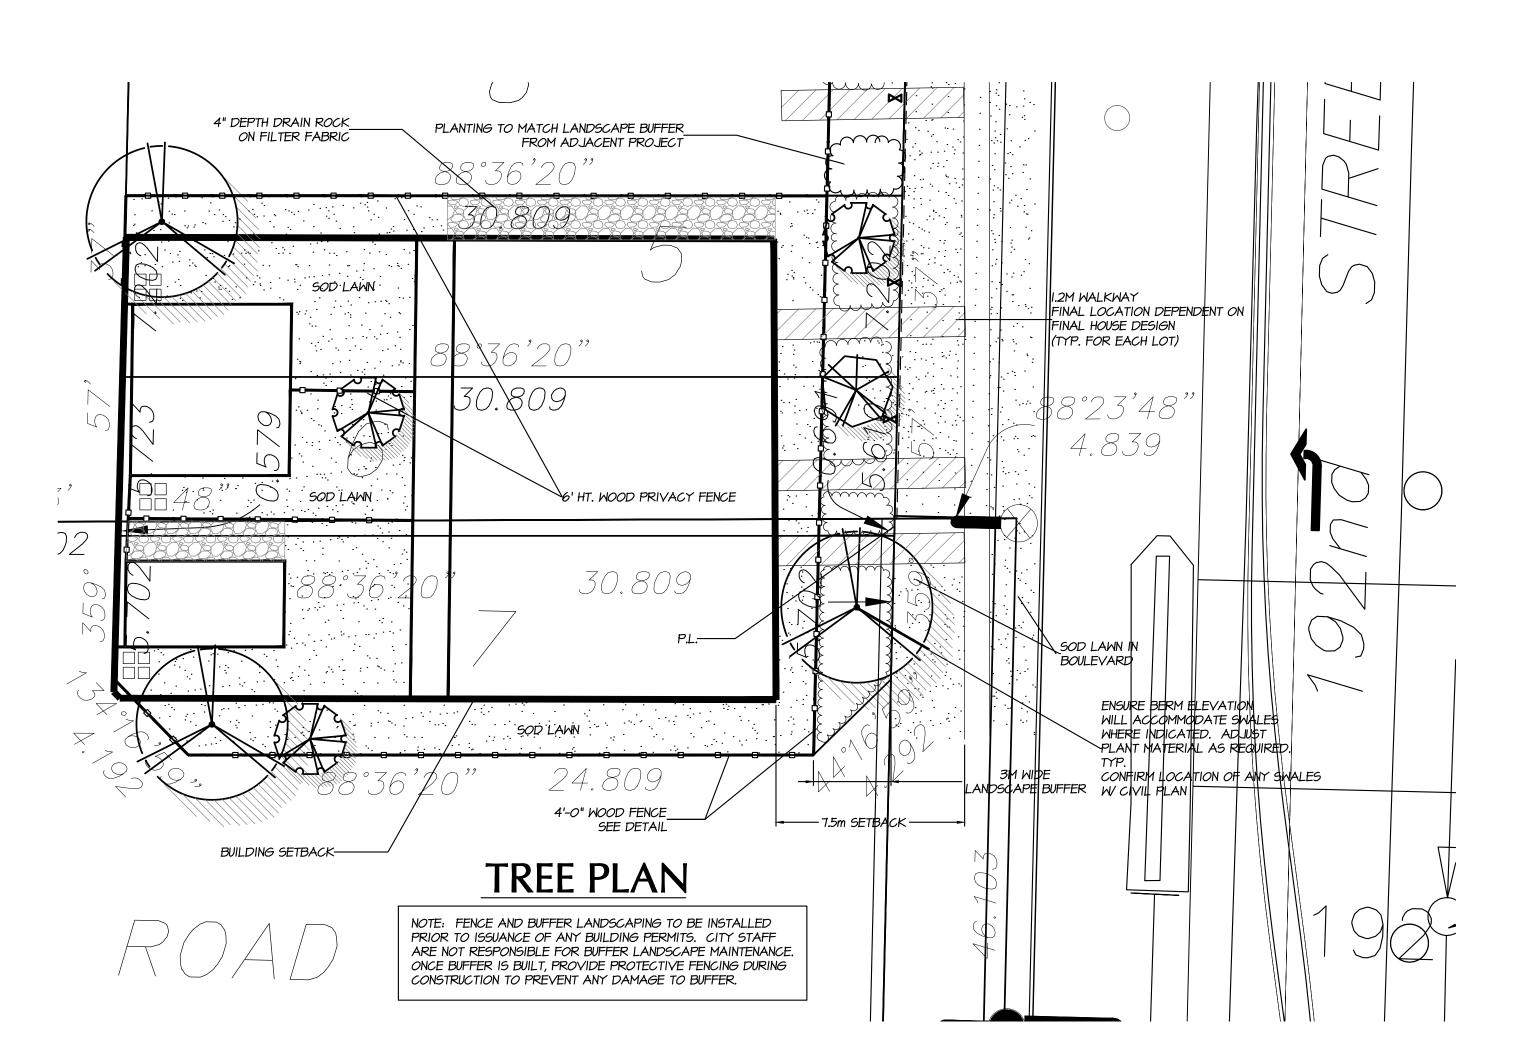
NOTES: \* PLANT SIZES IN THIS LIST ARE SPECIFIED ACCORDING TO THE BC LANDSCAPE STANDARD, LATEST EDITION. CONTAINER SIZES SPECIFIED AS PER CNTA STANDARDS. BOTH PLANT SIZE AND CONTAINER SIZE ARE THE MINIMUM ACCEPTABLE SIZES. \* REFER TO SPECIFICATIONS FOR DEFINED CONTAINER MEASUREMENTS AND OTHER PLANT MATERIAL REQUIREMENTS. \* SEARCH AND REVIEW: MAKE PLANT MATERIAL AVAILABLE FOR OPTIONAL REVIEW BY LANDSCAPE ARCHITECT AT SOURCE OF SUPPLY. AREA OF SEARCH TO INCLUDE LOWER MAINLAND AND FRASER VALLEY. \* SUBSTITUTIONS: OBTAIN WRITTEN APPROVAL FROM THE LANDSCAPE ARCHITECT PRIOR TO MAKING ANY SUBSTITUTIONS TO THE SPECIFIED MATERIAL. UNAPPROVED SUBSTITUTIONS WILL BE REJECTED. ALLOW A MINIMUM OF FIVE DAYS PRIOR TO DELIVERY FOR REQUEST TO SUBSTITUTE. SUBSTITUTIONS ARE SUBJECT TO BC LANDSCAPE STANDARD - DEFINITION OF CONDITIONS OF AVAILABILITY.

ALL PLANT MATERIAL MUST BE PROVIDED FROM CERTIFIED DISEASE FREE NURSERY. PROVIDE CERTIFICATION UPON REQUEST.

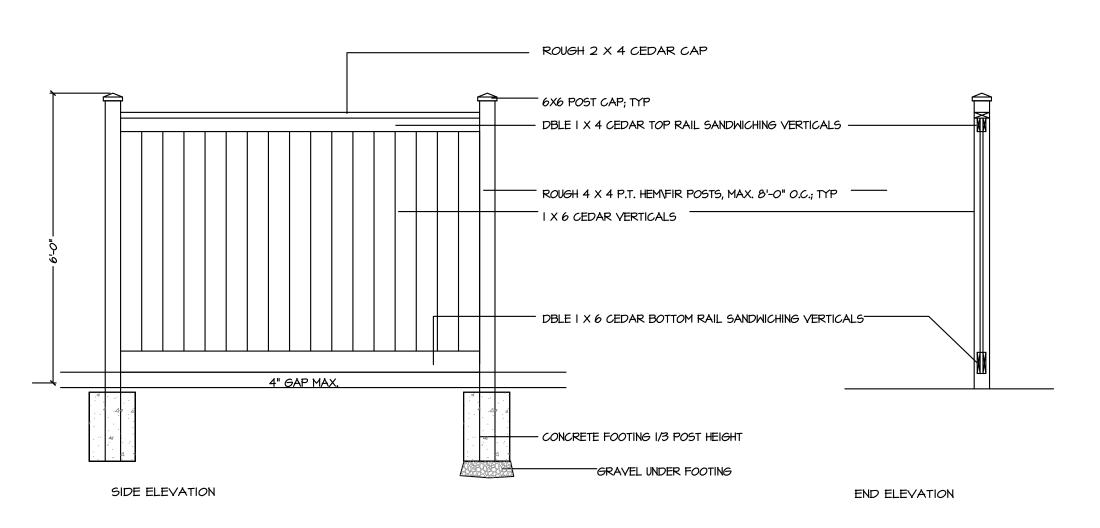



6' HT. PRIVACY FENCE SCALE 1:25

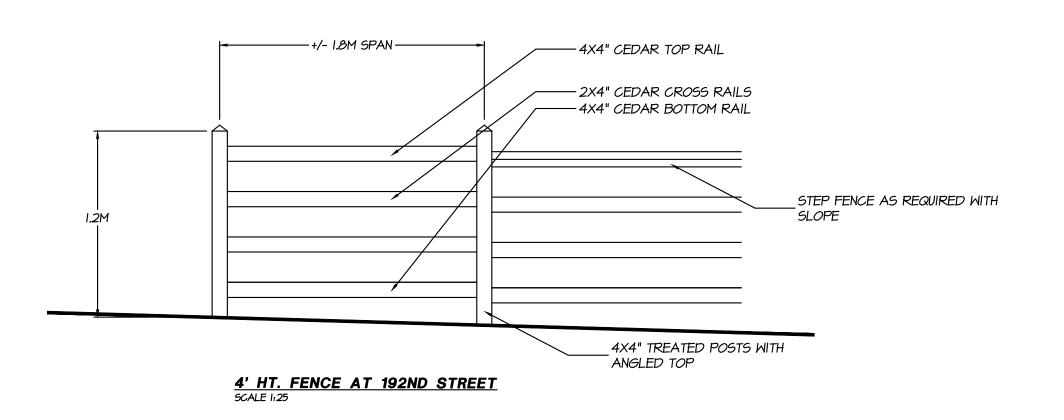

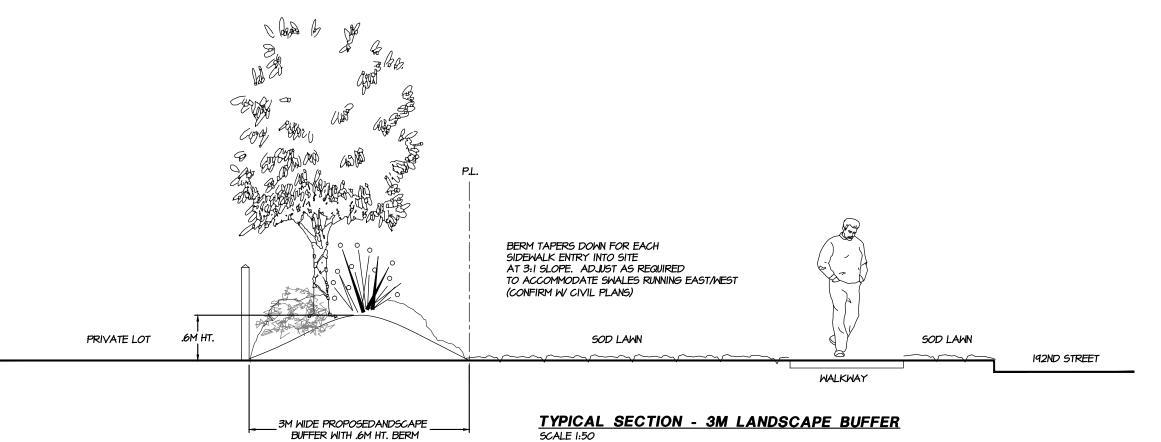

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Suite C100 - 4185 Still Creek Drive Burnaby, British Columbia, V5C 6G9 p: 604 294-0011; f: 604 294-0022

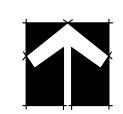PROJECT:

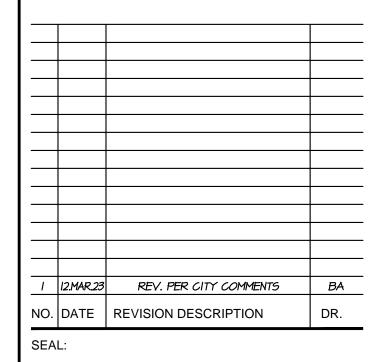3 LOT SUBDIVISION 72nd Ave & 192nd STREET SURREY, BC

DRAWING TITLE:

LANDSCAPE PLAN

DATE:	II.FEB.2I	DRAWING NUMBER:
SCALE:	1:150	
DRAWN:	BA	
DESIGN:	BA	
CHK'D:	PCM	OF 2

12-043

*12043-1.zip* ■ DMG PROJECT NUMBER:



# INTER-OFFICE MEMO

10:

Manager, Area Planning & Development

- North Surrey Division

Planning and Development Department

FROM:

Development Project Engineer, Engineering Department

DATE:

March 23, 2012

PROJECT FILE:

7811-0291-00

RE:

Engineering Requirements Location: 7241/7287 192 St.

#### **OCP AMENDMENT**

There are no engineering requirements relative the OCP Amendment.

# REZONE/SUBDIVISION

# Property and Right-of-Way Requirements

- Dedicate 4.808 metres on 192 Street for a total of 34.000 metres from 7241 192 Street;
- Dedicate 6.942 metres on 192 Street for a total of 34.000 metres from 7287 192 Street;
- Dedicate 18.000 metres for 72A Avenue;
- Dedicate 6.000 metres for north-south lane;
- Dedicate 3.om x 3.om corner cuts at the intersection of 72A Avenue and north-south lane;
- Dedicate 3.om x 3.om corner cuts at the intersection 192 Street and 72A Avenue;
- Provide 0.5 metre wide statutory right-of-way (SROW) on both sides of 72A Avenue.
- Provide 0.5 metre wide SROW along 192 Street new property line;

#### Works and Services

- Construct 72A Avenue Through Local standard;
- Construct north-south lane:
- Construct Multi-Use-Pathway on 192 Street under Development Coordinated Works;
- Construct sanitary sewer main, storm sewer main and watermain to service the development;
- Pay applicable DCC frontender and latecomer payments;
- Double bond for off-site works, as required.

A Servicing Agreement is required prior to Rezone/Subdivision.

# **DEVELOPMENT PERMIT**

There are no engineering requirements relative to issuance of the Development Permit.

Bob Ambardar, P.Eng.

Development Project Engineer

HB



Tuesday, April 10, 2012 Planning

#### THE IMPACT ON SCHOOLS

**APPLICATION #:** 

7911 0291 00

#### **SUMMARY**

The proposed 7 Single family lots are estimated to have the following impact on the following schools:

#### **Projected # of students for this development:**

Elementary Students:	3
Secondary Students:	1

#### September 2011 Enrolment/School Capacity


Clayton Elementary	
Enrolment (K/1-7):	21 K + 123
Capacity (K/1-7):	20 K + 175
Clayton Heights Secondary	
Clayton Heights Secondary Enrolment (8-12):	1263
, ,	1263 1000

#### School Enrolment Projections and Planning Update:


The following tables illustrate the enrolment projections (with current/approved ministry capacity) for the elementary and secondary schools serving the proposed development.

A new elementary school (Hazelgrove Elementary Site #203) opened in September 2009 resulting in enrolment moves from Clayton/East Clayton. Enrolment from Clayton Elementary catchment is projected to grow due to the expansion of E. Clayton NCP Area and anticipated growth of the West Clayton NCP Area (under review). The school district has received capital plan approval of it's #1 capital plan priority, a new elementary school on Site #201 in the E. Clayton NCP Area. The new elementary school is expected to open by 2014 and will relieve overcrowding at Hazelgrove and Clayton. Additional school sites are also being assembled north of 72 Avenue including two new elementary school sites and a new secondary school in the North Clayton Area. The construction of a new elementary and future secondary school North of 72 Ave are subject to capital funding approval by the Province. The proposed development will not have an impact on the long term projections.

#### **Clayton Elementary**

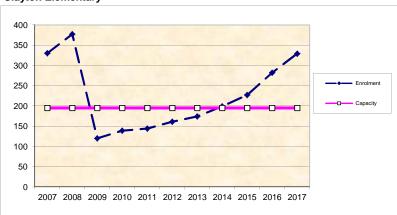

#### **Clayton Heights Secondary**

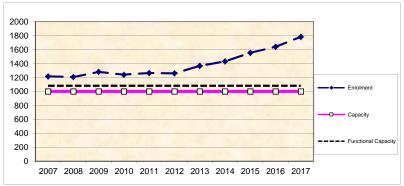

\*Functional Capacity at secondary schools is based on space utilization estimate of 27 students per instructional space. The number of instructional spaces is estimated by dividing nominal facility capacity (Ministry capacity) by 25.

# **BUILDING GUIDELINES SUMMARY**

Surrey Project no: 7911-0291-00

Project Location: 7241 - 192 Street, Surrey, B.C.

Design Consultant: Tynan Consulting Ltd., (Michael E. Tynan)

The draft Building Scheme proposed for this Project has been filed with the City Clerk. The following is a summary of the Residential Character Study and the Design Guidelines which highlight the important features and form the basis of the draft Building Scheme.

# 1. Residential Character

# 1.1 General Description of the Existing and/or Emerging Residential Character of the Subject Site:

The subject site is located in a strong new growth area in East Clayton, which has become defined by hundreds of single family residential compact lot homes in the RF-12, RF-12C, RF-9, and RF-9C zones, in addition to zero lot line dwellings developed under the RF-SD zone. These dwellings are all constructed within the context of the greater sustainable development region in East Clayton which also includes numerous multifamily zonings as well as local light commercial zones. The form and character of East Clayton is now well defined and all new residential developments must now be treated as infill developments to ensure continuity within East Clayton.

East of the subject site (east side of 192 Street) is a C-5 (Neighbourhood Commercial Zone) property that has not yet developed (the site is vacant). Also on the east side of 192 Street, but north of the C-5 site, is a recently completed RF-SD development. The dwellings are all new (year 2010) RF-SD zoned side-by-side zero-lot-line dwellings. These homes can all be considered desirable manifestations of the "Neo-Heritage" style. Each dwelling has a single storey front entrance veranda. The homes have desirable asymmetrical massing designs that makes the structures appear as though two dwellings are one larger single family dwelling. The homes have a 6:12 pitch main common hip roof with street facing gable projections at slopes ranging from 12:12 to 14:12. All homes have a shake profile asphalt shingle roof surface. The homes are clad in vinyl cladding, and have either Hardi-shingles or vertical wood battens over Hardipanel at the gable ends. The trim and detailing standards are high. There is a transparent cross-brace fence design at the front lot line with shrubs forward of fence. These dwellings provide excellent architectural context for the CD dwellings proposed to be located on lots 5,6,7 fronting 192 Street.

Adjacent to the west side of the subject site is a proposed new RF-12 zone development. The property adjacent to the north side of the subject site is a 39 lot RF-9C, RF-12C and RF-SD site, that can be considered Phase 1, with the subject site considered phase 2 of a two phase project. Therefore, to ensure continuity, regulations context for the subject site will be derived from the building scheme for Surrey project 7910-0177-00.

# 1.2 Prevailing Features of the Existing and Surrounding Dwellings Significant to the Proposed Building Scheme:

- 1) <u>Context Homes</u>: Context for RF-12C and RF-9C homes can be found throughout East Clayton. Building scheme regulations for the subject site will be derived substantially from building scheme regulations at the adjacent site to the north; 7910-0177-00.
- 2) <u>Style Character:</u> "Neo-Traditional", "Neo-Heritage" and "Craftsman Heritage" styles define the character of East Clayton including areas near the subject site.
- 3) <u>Home Types</u>: Dominance of Two-Storey home type. All homes in the surrounding area are Two-Storey type. There are no Basement Entry homes in this area.
- 4) <u>Massing Designs</u>: Surrounding new homes provide desirable massing context. The homes are well balanced and correctly proportioned.
- 5) <u>Front Entrance Design</u>: RF-12 and RF-12C homes in the surrounding area have entrances ranging from one to 1 ½ storeys in height.
- 6) <u>Exterior Wall Cladding</u>: Vinyl is clearly dominant. All homes have gable ends articulated with cedar shingles, Hardi shingles, or vertical 1x4 or 1x6 wood battens over Hardipanel.
- 7) Roof surface: All homes have a shake profile asphalt shingle roof surface.
- 8) Roof Slope: Roof pitch on the upper floor roof ranges from 6:12 to 8:12. Roof slopes on street facing feature gable projections range from 8:12 to 14:12.

Dwelling Types/Locations:	Two-Storey	100%
	Basement Entry/Cathedral Entry	0%
	Rancher (bungalow)	0%
	Split Levels	0%

**Exterior Treatment** Context homes are clad in vinyl with wood wall shingles or **/Materials:** Hardipanel with 1x4 vertical wood battens at gable ends.

**Roof Pitch and Materials:** All homes at context site have a shake profile asphalt shingle roof.

Window/Door Details: Rectangular dominant.

Streetscape:

North, west, and south of the subject site are either large land parcels, or vacant lots soon to be developed. East of the subject site are several "Neo-Heritage" style pairs of zero lot line dwellings that have been designed to appear as a larger single family home (rather than appear as a mirror image duplex). The homes have mid-scale massing designs with mass allocations distributed in a proportionally correct and balanced manner across the façade. The homes all have covered entrance verandas. Main roof forms are common hip or common gable at a 6:12 to 8:12 slope. All homes have common gable projections at slopes ranging from 12:12 to 14:12 articulated with either cedar shingles or with Hardiboard and 1x4 vertical wood battens. All homes have a shake profile asphalt shingle roof and all are clad in vinyl. The colour range includes only natural and neutral hues. Landscaping meets a common standard.

# 2. Proposed Design Guidelines

# 2.1 Specific Residential Character and Design Elements these Guidelines Attempt to Preserve and/or Create:

- the new homes are readily identifiable as one of the following styles: "Neo-Traditional", "Neo-Heritage", or "Craftsman-Heritage". Note that the proposed style range is not contained within the building scheme, but is contained within the residential character study which forms the basis for interpreting building scheme regulations.
- a new single family dwelling constructed on any lot meets year 2000's design standards, which
  include the proportionally correct allotment of mass between various street facing elements, the
  overall balanced distribution of mass within the front facade, readily recognizable style-authentic
  design, and a high trim and detailing standard used specifically to reinforce the style objectives
  stated above.
- trim elements will include several of the following: furred out wood posts, articulated wood post bases, wood braces and brackets, louvered wood vents, bold wood window and door trim, highly detailed gable ends, wood dentil details, stone or brick feature accents, covered entrance verandas and other style-specific elements, all used to reinforce the style (i.e. not just decorative).
- the development is internally consistent in theme, representation, and character.
- the entrance element will be limited in height (relative dominance) to 1 to 1 ½ storeys.

# 2.2 Proposed Design Solutions:

Interfacing Treatment with existing dwellings)

New RF-12C homes shall be consistent with other new RF-12C homes in the surrounding area. Homes will therefore be "Neo-Traditional", "Neo-Heritage", and "Craftsman Heritage" styles only. New homes will have: similar home types and sizes, similar massing characteristics, similar roof types, roof pitch, roofing materials, and similar siding materials.

**Exterior Materials/Colours:** 

Stucco, Cedar, Vinyl, Hardiplank, Brick, and Stone. "Natural" colours such as browns, greens, clays, and other earth-tones, and "Neutral" colours such as grey, white, and cream are permitted. "Primary" colours in subdued tones such as navy blue or colonial red can be considered providing neutral trim colours are used, and a comprehensive colour scheme is approved by the consultant. "Warm" colours such as pink, rose, peach, salmon are not permitted. Trim colours: Shade variation of main colour, complementary, or neutral.

Roof Pitch: Minimum 8:12.

Roof Materials/Colours: Only Shake profile asphalt shingles with a raised ridge cap.

Minimum 30 year warranty. Grey or brown only.

**In-ground basements:** Permitted, subject to determination that service invert locations

are sufficiently below grade. Basements will appear

underground from the front.

**Treatment of Corner Lots:** There are no corner lots.

**Landscaping:** Moderate modern urban standard: Tree planting as specified on

Tree Replacement Plan plus minimum 15 shrubs of a minimum 3 gallon pot size. Sod from street to face of home. Driveways (all are rear lane access): exposed aggregate, interlocking masonry pavers, stamped concrete, and broom finish concrete.

Compliance Deposit: \$5,000.00

Summary prepared and submitted by: Tynan Consulting Ltd. Date: Dec 15, 2011

Reviewed and Approved by: Multiple Date: Dec 15, 2011




V

**Appendix** 

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SF

PH4

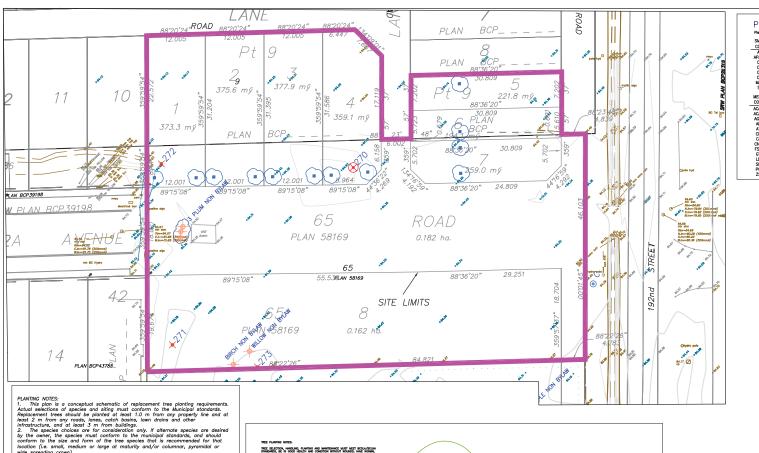


PLANT LIST: COMMON NAME
Vine Maple
Japanese Maple
Flowering Dogwood
Sakatoon Kousa dogwood Purple Giant Filbert MEDIUM MATURE SIZE: CODE CAL/HT B COMMON NAME BOTANICAL NAME CAL/HT

5cm cal.
3.0m
5cm cal.
3.0m
5cm cal.
3.0m
5cm cal. BUTANICAL NAME
Acer compestre
Acer coppadocicum
Acer griseum
Acer rubrum
Acer rubrum
Corpinus betulus "fastigiota"
Carcidipylium japonicum
Chamaeopyparis nootkotensis 'P
Fagus sylvatica 'Danykii
Gleditisia (iraconthos 'Inermis' Hedge Maple Coliseum Maple Paperbark Maple Red Maple Snakebark Maple Fastigate hornbeam ACAM ACAP AGRI AR AT CB CJ CNP FSD GT LL SP PO ZS rastigiate normbeam Katsuratree

'Weeping Yellow Cedar Fastigiate Beech Honey locust var Tamarack Japanese Stewartia Serbian spruce Japanese Zelkova Gleditsia triacantnos iner Larix laricina Stewartia pseudocamellia Picea omorika Zelkova serrata

conform to the size and form of the tree species that is recommended for that location (i.e. small, medium or large at maturity and/or columnar, pyramidal or wide spreading countries. The control of the collection of the preparation handling of plants, planting methods, staking and establishment maintenance. On disturbed sites such as new subdivisions, the underlying oil is usually heavily compacted and organics stripped for and by and reducing compaction by the compaction of the collection of

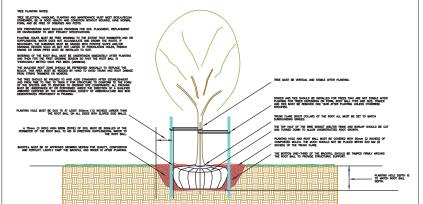

Plan Notes:

1. This pion is based on a topographic and tree location survey provided by the owners' Registered Britlan Columbia Land Surveyor (BCLS) and loyout drawings provided by the ceredii Signiere (\*P. Eng.) and of or beings Consultations.

1. The Columbia Columbia

LEGEND - TREE RETENTION

denotes TREE NUMBER. Refer to tree inventory for type, size and condition data.

denotes BYLAW tree to be RETAINED.


X denotes BYLAW tree to be REMOVED.

⊗ denotes BYLAW ALDER/COTTONWOOD tree to be REMOVED.

+ denotes UNDER BYLAW SIZE TREE to be REMOVED. Species and size as noted.

(subject to city review of protected tree status) denotes OFFSITE\_tree requiring REFERRAL to CITY PARKS DEPARTMENT for

denotes REPLACEMENT TREE to be planted. Refer to plant list for species and size specifications.

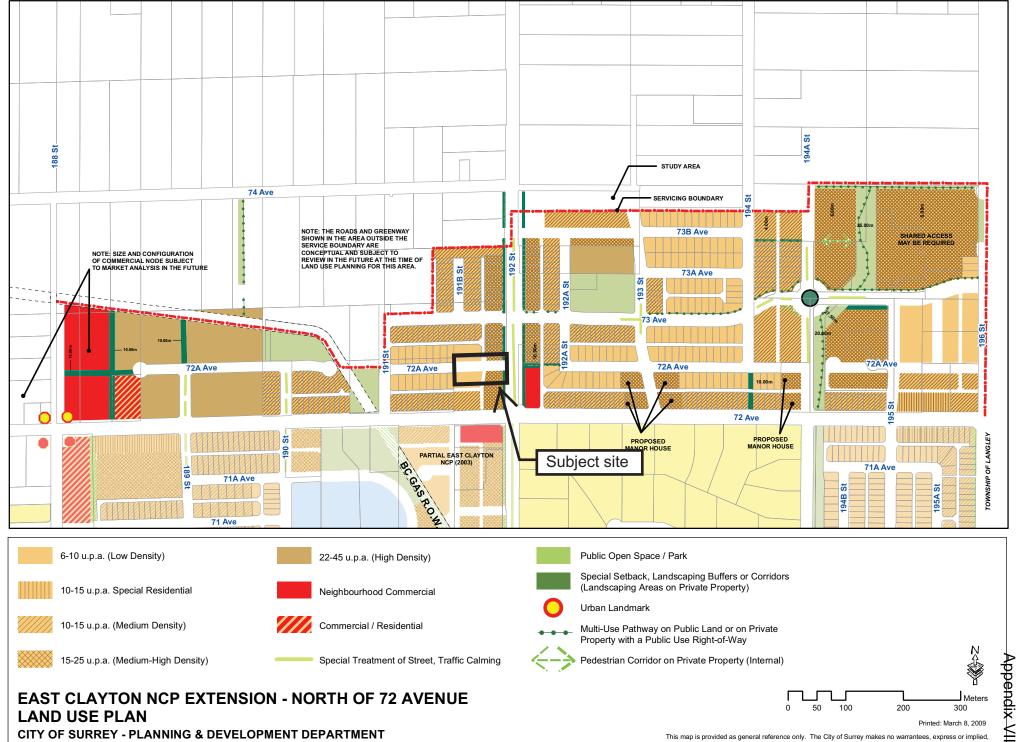

**CITY OF SURREY - PLANNING & DEVELOPMENT DEPARTMENT** 

Approved By Council on June 27, 2005 Amended 14 Dec 2011

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