

City of Surrey PLANNING & DEVELOPMENT REPORT File: 7911-0320-00

Planning Report Date: February 24, 2013

PROPOSAL:

- **Rezoning** portions from RM-D and RF to CD (based on RM-D) and RF-12
- Development Permit
- Development Variance Permit

in order to retain an existing duplex and to allow subdivision into six lots.


LOCATION: 12229 – 96 Avenue

12215 and 12217 - 96 Avenue

OWNERS: Narinder Aujla et al.

ZONING: RM-D and RF

OCP DESIGNATION: Urban

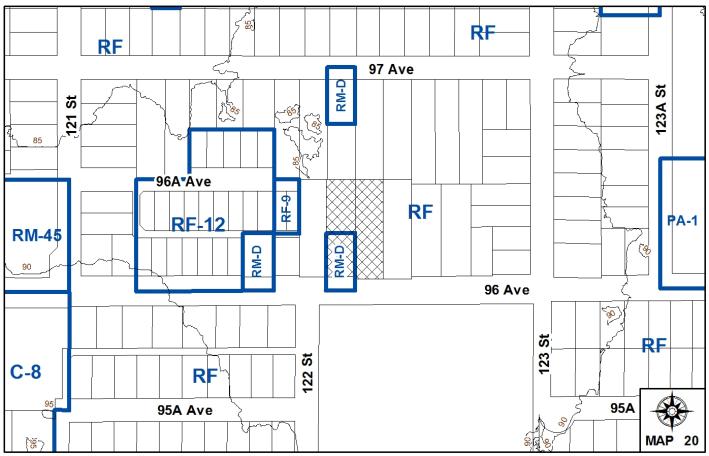

RECOMMENDATION SUMMARY

- By-law Introduction and set date for Public Hearing for:
 - o Rezoning portion to CD (based on RM-D); and
 - o Rezoning to RF-12.
- Approval to draft Development Permit.
- Approval for Development Variance Permit to proceed to Public Notification.

DEVIATION FROM PLANS, POLICIES OR REGULATIONS

• The applicant is seeking rear yard setback relaxations for the two buildings proposed to remain.

RATIONALE OF RECOMMENDATION

- Complies with the Urban designation in the OCP.
- The proposed subdivision is compatible with the existing pattern of development in this area.
- The applicant wants to retain the existing duplex and has agreed to make improvements to the building exterior and the landscaping, in accordance with the proposed Development Permit.
- The existing driveways to the duplex and the single family dwelling on the subject lots along 96 Avenue will be eliminated, with new accesses being provided through a new rear lane.
- Variance is required to retain the 10-year old single family dwelling on proposed Lot 5 that will not conform to the rear yard setback of the RF Zone, once the lane is dedicated.

RECOMMENDATION

The Planning & Development Department recommends that:

- a By-law be introduced to rezone Block A as shown on the Survey Plan (Appendix I) from "Duplex Residential Zone (RM-D)" (By-law No. 12000) to "Comprehensive Development Zone (CD)" (By-law No. 12000) and a date be set for Public Hearing.
- a By-law be introduced to rezone Block B as shown on the Survey Plan (Appendix I) from "Single Family Residential Zone (RF)" (By-law No. 12000) to "Single Family Residential (12) Zone (RF-12)" (By-law No. 12000) and a date be set for Public Hearing.
- 3. Council authorize staff to draft Development Permit No. 7911-0320-00 generally in accordance with the attached drawings (Appendix III).
- 4. Council approve Development Variance Permit No. 7911-0320-00 (Appendix VIII) varying the following, to proceed to Public Notification:
 - (a) to reduce the minimum rear yard setback of the RF Zone from 7.5 metres (25 ft.) to 4.6 metres (15 ft.) for proposed Lot 5; and
 - (b) to reduce the minimum rear yard setback of the proposed CD Zone from 15 metres (50 ft.) to 7.3 metres (24 ft.) for proposed Lot 6.
- 5. Council instruct staff to resolve the following issues prior to final adoption:
 - (a) ensure that all engineering requirements and issues including restrictive covenants, dedications, and rights-of-way where necessary, are addressed to the satisfaction of the General Manager, Engineering;
 - (b) submission of a subdivision layout to the satisfaction of the Approving Officer;
 - (c) submission of an acceptable tree survey and a statement regarding tree preservation;
 - (d) the applicant satisfy the deficiency in tree replacement on the site, to the satisfaction of the Planning and Development Department;
 - (e) submission of a landscaping plan and landscaping cost estimate for proposed Lot
 6, to the specifications and satisfaction of the Planning and Development
 Department;
 - (f) resolution of all urban design issues for proposed Lot 6, to the satisfaction of the Planning and Development Department;
 - (g) the applicant address the concern that the development will place additional pressure on existing park facilities to the satisfaction of the General Manager, Parks, Recreation and Culture;
 - (h) demolition of portions of the existing duplex on proposed Lot 6, to the satisfaction of the Planning and Development Department;

(i) provision of a security bond for the proposed improvements to the existing duplex on proposed Lot 6; and

(j) indication of support by Council for Development Variance Permit No. 7911-0320-00.

REFERRALS

Engineering: The Engineering Department has no objection to the project

subject to the completion of Engineering servicing requirements as

outlined in Appendix IV.

School District: **Projected number of students from this development:**

2 Elementary students at Cedar Hills Elementary School 1 Secondary student at L.A. Matheson Secondary School

(Appendix V)

The applicant has advised that the new dwelling units in this project are expected to be constructed and ready for occupancy by

early 2015.

Parks, Recreation &

Culture:

Parks has some concerns about the pressure this project will place

on existing Parks, Recreation and Culture facilities in the

neighbourhood.

SITE CHARACTERISTICS

Existing Land Use: Duplex and single family dwelling both facing 96 Avenue, which are

intended to remain.

Adjacent Area:

Direction	Existing Use	OCP Designation	Existing Zone
North:	Single family dwellings and a duplex under Application Nos. 7911-0323-00 and 7912-0007-00 (both at Third Reading) to subdivide into RF and RF-12 lots.	Urban	RF

Direction	Existing Use	OCP Designation	Existing Zone
East:	Single family dwelling, under Application No. 7913-0207-00 (Pre-Council) to subdivide into 4 RF-12 lots.	Urban	RF
South (Across 96 Avenue):	L.A. Matheson Secondary School	Urban	RF
West:	Single family dwelling, under Application No. 7907-0391-00 (Third Reading) to subdivide into 3 single family lots.	Urban	RF

DEVELOPMENT CONSIDERATIONS

Background

- The subject site consists of two, 2,000-square metre (0.5 ac.) properties located on the north side of 96 Avenue, west of 123 Street, in Whalley.
- The front portion of the western-most subject lot at 12215/17 96 Avenue, contains a duplex that is to be renovated and retained, and is currently zoned "Duplex Residential Zone (RM-D)". The remaining portions of both subject properties are zoned "Single Family Residential Zone (RF)". Both properties are designated Urban in the Official Community Plan (OCP).
- The eastern-most subject lot at 12229 96 Avenue, contains a single family dwelling that was built in 2004 that will be retained.

Current Proposal

- The applicant proposes to rezone the front portion (Block A on the Survey Plan in Appendix I) of 12215/17 96 Avenue from RM-D to CD (based on RM-D) and to rezone the rear portion (Block B on the Survey Plan in Appendix I) of both properties from RF to RF-12, in order to allow subdivision into five (5) single family lots (4 RF-12 and 1 RF) and one (1) duplex lot (CD).
- The proposed duplex lot and the proposed RF lot will front 96 Avenue, while the four proposed RF-12 lots will front 96A Avenue which will be constructed as part of this application.
- All proposed lots will have vehicle access from a proposed east/west rear lane which will also be constructed as part of this development.
- A Development Permit and Development Variance Permit are required to retain the existing duplex on proposed Lot 6.
- A Development Variance Permit is also required to retain the existing single family dwelling on proposed Lot 5.

Proposed Single Family Lots

- Proposed Lots 1-4 comply with the dimensional requirements of the RF-12 Zone.
- Under completed land development Application No. 7902-0284-00 to the west, a gradation of RF-sized single family lots fronting 97 Avenue to smaller single family lots fronting 96 Avenue and 96A Avenue was created. The proposed development is consistent with this pattern of development, as well as with the following existing applications (Appendix II):
 - o Application No. 7913-0207-00 (Pre-Council) proposes four (4) RF-12 lots.
 - o Application No. 7912-0007-00 (Third Reading on November 5, 2012) proposes one (1) RF and one (1) RF-12 lot.
 - o Application No. 7911-0323-00 (Third Reading on November 5, 2012) proposes three (3) RF lots and three (3) RF-12 lots.
- Proposed Lot 5 complies with the dimensional requirements of the RF Zone, however, a setback variance is needed in order to retain the existing single family dwelling (see By-law Variance section). The applicant has provided a Survey Plan showing the house complies with the Floor Area Ratio (FAR) requirement of the RF Zone on proposed Lot 5.
- All proposed lots will have vehicle access from the proposed rear lane.
- There is no garage for the existing house on proposed Lot 5. The east side yard setback is 7.67 metres (25 ft.) wide and is currently used, and will continue to be used as a parking pad, and can accommodate two vehicles.

Proposed Development Permit to Retain the Existing Duplex on Proposed Lot 6

- The existing duplex is proposed to be retained on proposed Lot 6. Proposed Lot 6 is 766 square metres (8,235 sq. ft.) in size and does not meet the minimum 930-square metre (10,000 sq. ft.) lot size of the RM-D Zone.
- The existing duplex has a floor area of 473 square metres (5,100 sq. ft.) which exceeds the maximum 372 square metre (4,000 sq. ft.) floor area permitted in the RM-D Zone.
- As a result, in order to retain the existing duplex, proposed Lot 6 needs to be rezoned to a Comprehensive Development Zone (CD). A Development Permit will be required to regulate the form and character of the duplex and the landscaping.
- The existing duplex was constructed in the 1960's. Although it is approximately 50 years old, the duplex is still useable and provides a source of income for the applicant. The applicant has indicated it is more economical to retain the duplex, than to demolish the duplex and develop two RF-12 lots fronting 96 Avenue.
- The applicant has agreed to make minor upgrades to the building exterior and the landscaping of the duplex as part of the Development Permit requirements. Some of these improvements include:

- The carports at the front of the duplex as well as an addition at the rear of the duplex will be removed. Vehicles will utilize the proposed rear lane to access the site and will park on parking pads at the rear of the duplex. One parking pad will be provided for each duplex unit and both parking pads will be large enough to accommodate two vehicles.
- o Fresh paint, new trim and decorative posts will be applied to the front façade.
- o The siding will be painted light brown and the trim will be painted a cream colour.
- New shrubs and two new trees will be planted at the front and at the rear of the duplex. An existing Western Red Cedar tree in the front yard will be retained. The existing driveway in the front yard will be removed and replaced with lawn.
- The applicant has agreed to provide a security bond for the cost of the proposed improvements to the duplex and the lot. The removal of the carports and rear addition will be required before consideration of final adoption of the rezoning.

Proposed CD Zone for Existing Duplex

• The following chart shows the differences between the proposed CD Zone and the existing RM-D Zone:

	Proposed CD Zone	RM-D Zone
Minimum Lot Size	765 square metres (8,235 sq.	930 square metres (10,000
	ft.)	sq. ft.)
Rear Yard Setback	15 metres (50 ft.)	7.5 metres (25 ft.)
Floor Area	475 square metres (5,100 sq.	372 square metres (4,000 sq.
	ft.)	ft.)

- The maximum permitted floor area of the proposed CD Zone, including the basement, garage and carport is 475 square metres (5,100 sq. ft.). Currently, a garage, carport, or accessory structure is not proposed for the duplex lot and the existing duplex which does not have a basement, is at the maximum floor area allowed in the proposed CD Zone.
- The existing floor area of the duplex exceeds the floor area permitted in the RM-D Zone by 25%. By limiting the maximum floor area of the existing duplex to its current size, it will prevent further expansion of the duplex.
- The rear yard setback for the principal building in the proposed CD Zone is 15 metres (50 ft.) and as a result, will require a Development Variance Permit (see By-law Variance section) in order to retain the existing duplex. Staff required the rear yard setback of the proposed CD Zone to be increased to 15 metres (50 ft.) to discourage the property owner from constructing a new duplex of the same size in the future. In order to construct a new duplex to the maximum size permitted in the proposed CD Zone, a DVP will be required to reduce the rear yard setback, which will require Council approval. A Development Permit would also be required. The applicant has no objection to this approach.

Building Scheme and Lot Grading

- The applicant for the subject site has retained Tynan Consulting Ltd. as the Design Consultant. The Design Consultant conducted a character study of the surrounding homes and based on the findings of the study, proposed a set of building design guidelines for proposed Lots 1-5 (Appendix VI).
- A preliminary lot grading plan was submitted by Coastland Engineering & Surveying Ltd. and reviewed by staff and was determined to be adequate.
- Based on the proposed grading, basements can be achieved on all four proposed RF-12 lots.
 However, final confirmation whether in-ground basements are achievable will be determined
 once final engineering drawings have been reviewed and accepted by the City's Engineering
 Department.
- The existing single family dwelling on proposed Lot 5 does not have a basement.

Tree Survey and Preservation Plan

- Trevor Cox of Diamond Head Consulting Ltd. prepared the Arborist Report and Tree Preservation/Replacement Plans, which have been reviewed by the City Landscape Architect and deemed generally acceptable.
- The following chart provides a summary of on-site tree retention and removal by species

Tree Species	Total No. of Trees	Total Proposed for Retention	Total Proposed for Removal
Cherry	1	1	0
Douglas-fir	1	1	0
Shore Pine	1	1	0
Western Red	1	1	0
Cedar			
Total	4	4	0

• No trees are proposed for removal, therefore no replacement trees are required. The average number of trees proposed per lot is 0.67, however, the applicant has volunteered to provide up to three trees per lot as shown on the preliminary tree replacement plan in Appendix VII.

PRE-NOTIFICATION

Pre-notification letters were mailed on January 13, 2013, and staff received no responses.

SUSTAINABLE DEVELOPMENT CHECKLIST

The applicant prepared and submitted a sustainable development checklist for the subject site on January 4, 2012. The table below summarizes the applicable development features of the proposal based on the seven (7) criteria listed in the Surrey Sustainable Development Checklist.

Sustainability Criteria	Sustainable Development Features Summary
1. Site Context & Location (A1-A2)	The site in an urban infill area.
2. Density & Diversity (B1-B7)	• Secondary suites will be permitted on the RF-12 and RF lots.
3. Ecology & Stewardship (C1-C4)	Recycling pickup will be available.
4. Sustainable Transport & Mobility (D1-D2)	• N/A
5. Accessibility & Safety (E1-E3)	• N/A
6. Green Certification (F1)	• N/A
7. Education & Awareness (G1-G4)	Pre-notification letters were mailed, a development proposal sign was installed, and a Public Hearing will be held.

BY-LAW VARIANCES AND JUSTIFICATION

(a) Requested Variance:

• To reduce the minimum rear yard setback in the proposed CD Zone from 15 metres (50 ft.) to 7.3 metres (24 ft.) for proposed Lot 6.

Applicant's Reasons:

• The duplex provides a source of rental income for the applicant, and is reportedly more economical to retain than to demolish and subdivide into two (2) RF-12 lots.

Staff Comments:

- As the existing duplex is located 7.3 metres (24 ft.) from the proposed rear property line, a Development Variance Permit (DVP) is required in order to retain the duplex.
- The proposed variance only applies to the existing structure, and not a future or replacement structure.

• The proposed CD Zone permits a duplex up to 475 square metres (5,100 sq. ft.) on a 766-square metre (8,245 sq. ft.) lot. This use is not consistent with the redevelopment pattern of the neighbourhood, which is seeing neighbouring lots subdivide into compact single family lots, nor is it compatible with the massing of neighbouring single family homes. However, the duplex is suitable for retention until it reaches its maximum life span, at which time, it will presumably be removed, and proposed Lot 6 can redevelop into a higher and better use, such as two RF-12 lots.

- In an effort to prevent the same size duplex from being rebuilt in the future, and to encourage redevelopment to a more appropriate and compatible use, the proposed CD Zone increases the rear yard setback to 15 metres (50 ft.), which will require Council to approve a future setback variance if the landowner applies to rebuild the duplex to the maximum size of 475 square metres (5,100 sq. ft.).
- If a future rear yard setback relaxation is not supported, the owner would be able to construct a two-storey duplex with a floor area of approximately 372 square metres (4,000 sq. ft.) which is the maximum floor area permitted for an interior lot in the RM-D Zone.
- Staff support the requested variance.

(b) Requested Variance:

• To reduce the minimum rear yard setback in the RF Zone from 7.5 metres (25 ft.) to 4.6 metres (15 ft.) for proposed Lot 5.

Applicant's Reasons:

• The existing house on proposed Lot 5 was built in accordance with Zoning By-law No. 12000 when the building permit was issued in 2004.

Staff Comments:

- The RM-D Zone was amended on January 9, 2006, by deleting the maximum 0.48 floor area ratio (FAR) and replacing the FAR with a maximum floor area of 372 square metres (4,000 sq. ft.) for interior lots.
- The proposed relaxation for the rear yard setback will not impact any homes to the rear, as the rear portion of the lot is being subdivided into two new RF-12 lots.
- The east side yard setback can accommodate parking for two vehicles.
- Staff support the requested variance.

INFORMATION ATTACHED TO THIS REPORT

The following information is attached to this Report:

Appendix I. Lot Owners, Action Summary, Project Data Sheets and Survey Plan

Appendix II. Proposed Subdivision Layout

Appendix III. Proposed Site Plan, and Building and Landscaping Improvements to the

Existing Duplex

Appendix IV. Engineering Summary
Appendix V. School District Comments

Appendix VI. Building Design Guidelines Summary

Appendix VII. Summary of Tree Survey and Tree Preservation Appendix VIII. Development Variance Permit No. 7911-0320-00

Appendix IX. Aerial Photo

Appendix X. Proposed CD By-law

original signed by Judith Robertson

Jean Lamontagne General Manager Planning and Development

JD/da

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Information for City Clerk

Legal Description and Owners of all lots that form part of the application:

1. (a) Agent: Name: Roger Jawanda

Citiwest Consulting Ltd.

Address: Suite 101, 9030 - King George Blvd

Surrey, BC V₃V₇Y₃

Tel: 604-591-2213 Fax: 604-591-5518

2. Properties involved in the Application

(a) Civic Addresses: 12229 - 96 Avenue

12215 and 12217 - 96 Avenue

(b) Civic Address: 12229 - 96 Avenue

Owner: Gurwinder K Sarai

Tarsem S Sarai Harjit K Randhawa Inderjit S Randhawa

PID: 003-654-761

West Half Lot "A" Section 31 Block 5 North Range 2 West New Westminster District Plan 13298

(c) Civic Address: 12215 and 12217 – 96 Avenue

Owner: Gurpreet Purewal

Harminder S Chahal

Narinder Aujla

PID: 010-415-131

Lot "E" Section 31 Block 5 North Range 2 West New Westminster District Plan 21342

3. Summary of Actions for City Clerk's Office

- (a) Introduce two By-laws, one to rezone Block A on the Survey Plan (Appendix I) from "Duplex Residential Zone (RM-D)" (By-law No. 12000) to "Comprehensive Development Zone (CD)" (By-law No. 12000) and a second to rezone Block B on the Survey Plan (Appendix I) from "Single Family Residential Zone (RF)" (By-law No. 12000) to "Single Family Residential (12) Zone (RF-12)" (By-law No. 12000) and a date be set for Public Hearing for each By-law.
- (b) Proceed with Public Notification for Development Variance Permit No. 7911-0320-00 and bring the Development Variance Permit forward for an indication of support by Council. If supported, the Development Variance Permit will be brought forward for issuance and execution by the Mayor and City Clerk in conjunction with the final adoption of the associated Rezoning By-laws.

SUBDIVISION DATA SHEET

Proposed Zoning: CD (based on RM-D) and RF-12. Existing Zoning: RF

Requires Project Data	Proposed
GROSS SITE AREA	
Acres	1.0
Hectares	.40
NUMBER OF LOTS	
Existing	2
Proposed	6
SIZE OF LOTS	
Range of lot widths (metres)	12 m 24 m
Range of lot areas (square metres)	12 m 24 m. 398 sq. m 760 sq. m.
Kange of for areas (square metres)	390 sq. iii 700 sq. iii.
DENSITY	
Lots/Hectare & Lots/Acre (Gross)	10.95 upha / 4.43 upa
Lots/Hectare & Lots/Acre (Net)	17.74 upha / 7.18 upa
	,,,,
SITE COVERAGE (in % of gross site area)	
Maximum Coverage of Principal &	45%
Accessory Building	.,
Estimated Road, Lane & Driveway Coverage	24%
Total Site Coverage	70%
PARKLAND	
	NA
Area (square metres) % of Gross Site	INA
70 OI GIOSS SILE	
	Required
PARKLAND	Required
5% money in lieu	YES
J/o money in neu	110
TREE SURVEY/ASSESSMENT	YES
TREE SORVETITIOSESSITEIVI	120
MODEL BUILDING SCHEME	YES
HERITAGE SITE Retention	NO
FRASER HEALTH Approval	NO
DEV. VARIANCE PERMIT required	
Road Length/Standards	NO
Works and Services	NO
Building Retention (rear yard setbacks)	YES
Others	NO

DEVELOPMENT DATA SHEET FOR PROPOSED LOT 6

Proposed Zoning: CD based on RM-D

Required Develo	opment Data	Minimum Required / Maximum Allowed	Proposed
LOT AREA (in so	juare metres)		
Gross Total	•		
Road Widen	ing area	70 sq. m.	70 sq. m.
Undevelopal	ole area	295 sq. m.	295 sq. m.
Net Total		365 sq. m.	365 sq. m.
LOT COVERAGE (in % of n		0/	0.7
Buildings & Structur		33%	33%
Paved & Hard Surfac	ced Areas	11.5%	11.5%
Total Site Coverage		44.8%	44.8%
SETBACKS (in metres)			
Front		7.5 m.	7.5 m.
Rear		15 m.	7.3 m.*
Side (east and west)		1.8 m.	1.8 m.
BUILDING HEIGHT (in me	tres/storevs)		
Principal	, , ,	9 m.	7.5 m.
Accessory			NA
NUMBER OF RESIDENTIAL	LINITC		
Bachelor	LUNIIS		
One Bed			
Two Bedroom			
Three Bedroom +			
Total			
FLOOR AREA: Residential		475 sq. m.	475 sq. m.
FLOOR AREA: Commercial			
Retail			
Office			
Total			
FLOOR AREA: Industrial			
FLOOR AREA: Institutiona	1		
TOTAL BUILDING FLOOR	AREA	475 sq. m.	475 sq. m.

^{*} Seeking variance

Development Data Sheet cont'd


Required Development Data	Minimum Required / Maximum Allowed	Proposed
DENSITY		
# of units/ha /# units/acre (gross)		
# of units/ha /# units/acre (net)	8 upha	13.33 upha
FAR (gross)	_	
FAR (net)	475 sq. m.	475 sq. m.
AMENITY SPACE (area in square metres)		
Indoor		
Outdoor		
PARKING (number of stalls)		
Commercial		
Industrial		
Residential Bachelor + 1 Bedroom		
2-Bed	2	2
3-Bed		
Residential Visitors		
Institutional		
Total Number of Parking Spaces	2 per unit	2 per unit
Number of disabled stalls		
Number of small cars		
Tandem Parking Spaces: Number / % of Total Number of Units		
Size of Tandem Parking Spaces width/length		

Heritage Site	NO	Tree Survey/Assessment Provided	YES
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SURVEY PLAN TO ACCOMPANY CITY OF SURREY REZONING BYLAW NO. _____ OF LOT "E", PLAN 21342; THE WEST HALF OF LOT "A" PLAN 13298; BOTH OF SECTION 31, BLOCK 5 NORTH, RANGE 2 WEST, NWD

City of Surrey B.C.G.S. 92G.016

Fax: 604-597-3783

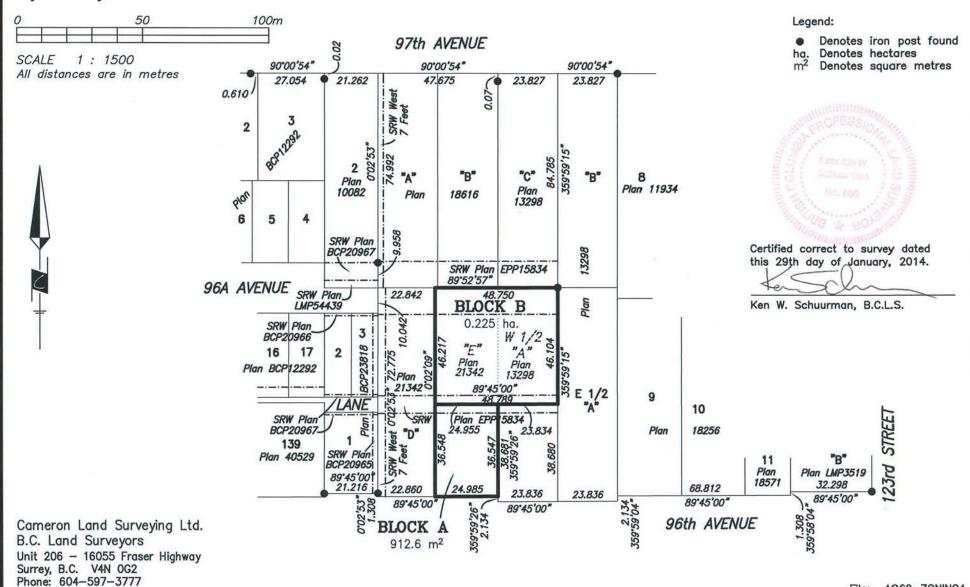

File: 4960-ZONING4

CitiWest

TELEPHONE 604-691-2213 FAX 604-591-5618

E-MAIL: office@citiwest.com

1 13/01/07

REVISED PER CITY COMMENTS

Designed: P.W. P.U.

PRELIMINARY LOT LAYOUT

LOCATED AT 12215/12217/12229 - 96 AVENUE, SURREY, BC

RJ

Job No. 11-2860

Date DEC /11



PROPOSED REZONING & DEVELOPMENT PERMIT AT 12215 &12217 96 AVE

PRO VILLA **DESIGNS LTD.**15030-70 AVE., SURREY, BC PH: 604-825-3547

PROJECT TITLE:

12215 & 12217 - 96 AVE, SURREY

SHEET TITLE: PROPOSED HOUSE

SCALE: NTS

DATE:


DEC 19,2013

DRAWN BY: GS

CHECKED BY: TYNAN DESIGN

APPENDIX III

SHEET NO.:

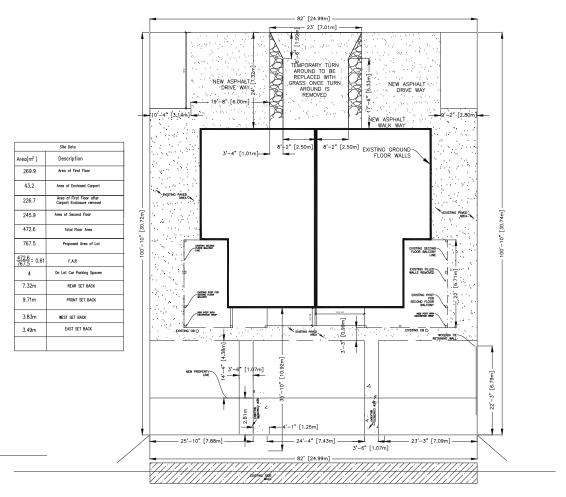

96 AVE

PROPOSED SITE PLAN

SCALE: 1/16"=1'

PRO VILLA DESIGNS LTD.

15030-70 AVE., SURREY, BC PH: 604-825-3547

PROJECT TITLE:

12215 & 12217 - 96 AVE, SURREY

SHEET TITLE:

PROPOSED LANDSCAPE

SCALE: 1 /16" = 1'-0"

DATE:

DEC 19,2013


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A-3

SHEET NO.



96 AVE

ROOF LINE PLAN

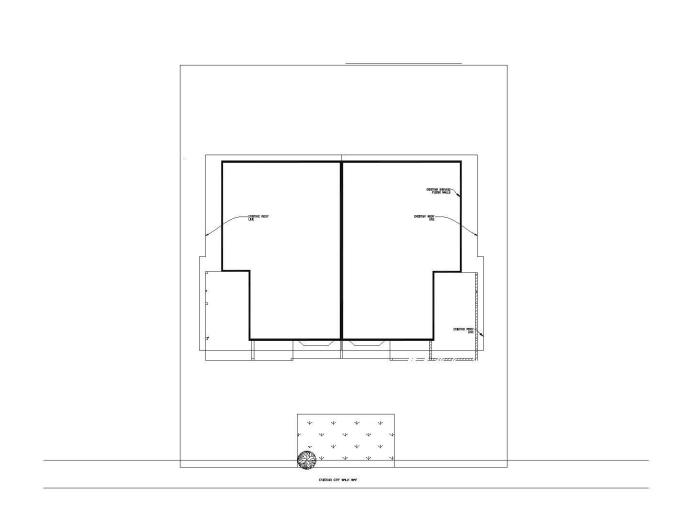SCALE: 1/16"=1'

PRO VILLA DESIGNS LTD. 15030-70 AVE., SURREY, BC PH: 604-825-3547

PROJECT TITLE:

12215 & 12217 - 96 AVE, SURREY

SHEET TITLE: ROOF LINE PLAN

SCALE: 1 /16" = 1'-0"


DATE:

DEC 19,2013

DRAWN BY: SHEET NO.: GS

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A-4



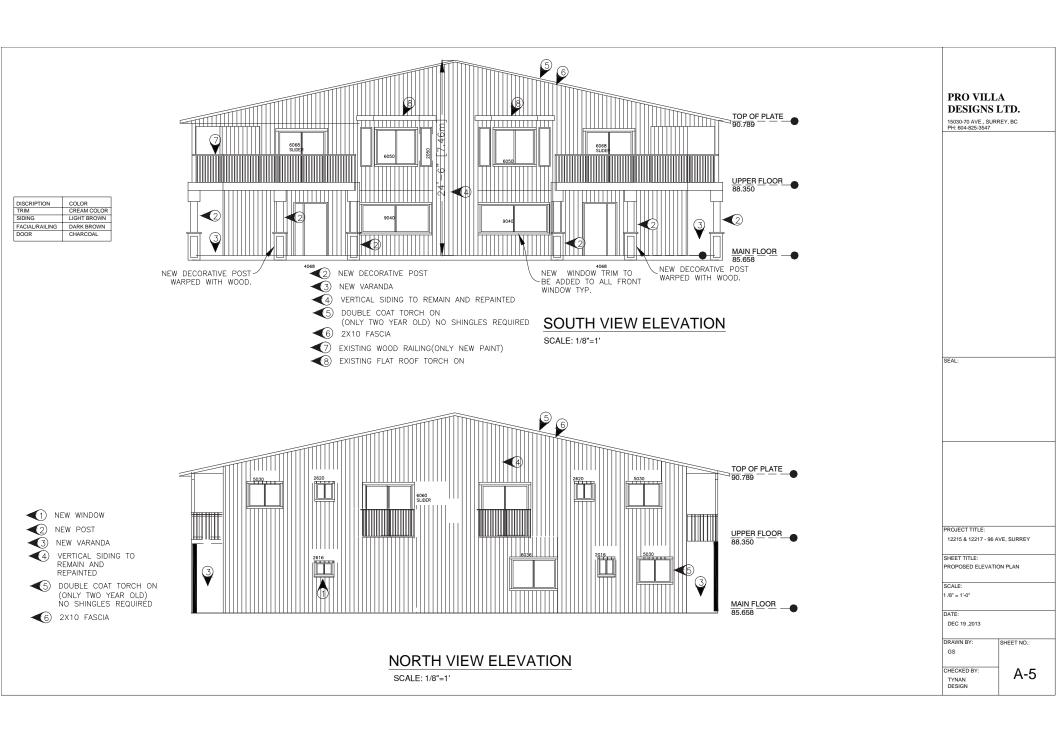

√2 NEW POST

✓ 3 NEW VRANDA

VERTICAL SIDING

DOUBLE COAT TORCH ON (ONLY TWO YEAR OLD) NO SHINGLES REQUIRED

€6 2X10 FASCIA

√7) WOOD RAILING

◆8 2X10 TRIM


6	TOP OF PLATE
5030 4040 2030 2888 2888 33	90.789 — —
EXISTING WALL TO BE REMOVED	- 85.058

WEST VIEW ELEVATION

SCALE: 1/8"=1'

DISCRIPTION	COLOR
TRIM	CREAM COLOR
SIDING	LIGHT BROWN
FACIAL/RAILING	DARK BROWN
DOOR	CHARCOAL

4

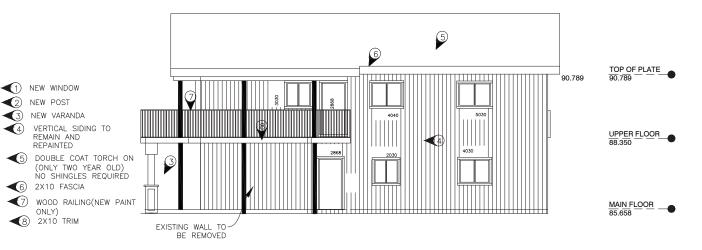

EAST VIEW ELEVATION

SCALE: 1/8"=1'

PRO VILLA DESIGNS LTD.

15030-70 AVE., SURREY, BC PH: 604-825-3547

PROJECT TITLE:

12215 & 12217 - 96 AVE, SURREY

SHEET TITLE:

PROPOSED ELEVATION PLAN

SCALE: 1 /8" = 1'-0"

DATE:

DEC 19,2013


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GS

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A-6

SHEET NO.:



Designer Notes

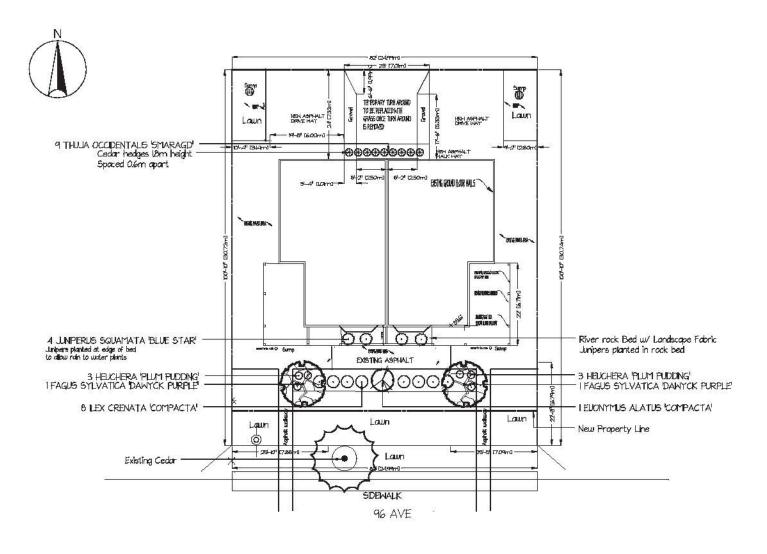- L All Plants shall meet or exceed Quality standards as described in the latest, edition of the BC Landscape Standards
- 2, All Soil products shall meet or exceed Guality standards as described in the latest edition of the BC Landscape Standards
- 3. Planting depths in approved soil media shall meet or exceed standards as described in the latest edition of the BC Landscape Standards
- 4. All Grading and drainage shall be done in accordance with the latest edition of the BC Landscape Standards
- 5, All garden beds to be top dressed with bank mulch
- 6. All trees to be planted must be inside a garden bed or have a Im mulch ring around the trunk

12215 96 Ave, Surrey Duplex Upgrade Landscape Plan



Qty	Botanical Name	Common Name	Size/Condition
Tree	25	,	V.
2	FAGUS SYLVATICA DAWYCK PURPLE	DAWYCK PURPLE BEECH	5CM CAL
Shru	bs		
L	EUONYMUS ALATUS COMPACTA'	BURNING BUSH	#5
8	ILEX CRENATA COMPACTA'	COMPACT JAPANESE HOLLY	#3
4	JUNIPERUS SQUAMATA 'BLUE STAR'	BLUE STAR JUNIPER	#
9	THUJA OCCIDENTALIS SMARAGD	SMARAGD CEDAR	6' B#B
Pere	ennials and Annuals		***************************************
6	HEUCHERA 'PLUM PUDDING'	PLUM PUDDING CORAL BELLS	#

12215 96 AVE LANDSCAPE PLAN Plants, Materials and Labour Estimate

Plants Quantity	Batanical Name	Cammon Name	Size	Price	Total
I	EUONYMUS ALATUS 'COMPACTA'	BURNING BUSH	#5	\$65.00	\$65.00
2	FAGUS SYLVATICA DAWYCK PURPLE	DAWYCK PURPLE BEECH	5CM CAL	\$375,00	\$750.00
6	HEUCHERA "PLUM PUDDING"	PLIM PUDDING CORAL BELLS	#1	\$15,00	\$90,00
පී	LEX CRENATA COMPACTA	COMPACT JAPANESE HOLLY	#3	\$35,00	\$280,00
4	JUNIPERUS SQUAMATA BLUE STAR	BLUE STAR JUNIPER	#1	\$45,00	\$60,00
9	THUJA OCCIDENTALIS ISMARAGDI	SMARAGD CEDAR	6' B#B	\$28,00	\$252.00
Marada				Total	\$1,497,00
Materials Quantity	Botorical Name	Common Name	Unit	Price	Total
li ,	River Rock 3 inches thick	120 sq. ft= 11 cu yd	cu yd	\$65,00	\$7150
L1	Gravel 3 inches thick	120 sq. ft= 11 cu yd	cu yd	\$65.00	\$7150
17	Garden Mix soil 12 inches thick	465 sq. ft = 17 cu yd	cu yd	\$45,00	\$255,00
30	Lawn sail 6 inches thick	2486 sq. ft = 46 au yd	cu yd	\$35,00	\$1,050.00
24	Landscape Fabric	23 ft long bed	per In ft	\$0,30	\$7,20
276	Lawn – sad	2486 sq. ft =276 sq. yd	per sq.yd	\$3.25	\$897,00
				Total	\$2,352,20
Labour	Barana	2000000 (10000)	C!	D.I.	T.1.1
Quantity	Botanical Name	Common Name	Size	Price	Total
	Labour .	50 of Materials & Plants			\$1,92460
				Total	\$5,773,80
				10 contingency	\$577.38
				sub total	\$6,3508
				GST/PST	\$762,14
				Total	\$15,38910





INTER-OFFICE MEMO

TO:

Manager, Area Planning & Development

- North Surrey Division

Planning and Development Department

FROM:

Development Services Manager, Engineering Department

DATE:

September 25, 2013

PROJECT FILE:

7811-0320-00

RE:

Engineering Requirements

Location: 12215 96 Avenue & 12229 96 Avenue

REZONE/SUBDIVISION

Property and Right-of-Way Requirements

- dedicate 2.808-metres and 4.942-metres along 96 Avenue for 30 m Arterial;
- dedicate 10.0-metres for 96A Avenue for 20 m local;
- dedicate 6.o-metres for the lane;
- register o.5-metre statutory right-of-way (SRW) along 96 Avenue; and
- register offsite or onsite SRW for construction of 96A Avenue.

Works and Services

- construct 96A Avenue to match the established cross section to the west;
- construct 6.0-metre lane:
- construct storm main along 96A Avenue and the lane;
- construct water main along 96A Avenue; and
- construct sanitary sewer along 96A Avenue;
- provide each lot and each duplex unit with a storm, water, and sanitary service connection.

A Servicing Agreement is required prior to Rezone/Subdivision. Note that logical completion and implementation of these works are contingent on coordination of design and construction with adjacent development applications.

DEVELOPMENT VARIANCE PERMIT

There are no engineering requirements relative to issuance of the Development Variance Permit.

Rémi Dubé, P.Eng. Development Services Manager

sk

NOTE: Detailed Land Development Engineering Review available on file



Tuesday, January 08, 2013 Planning

THE IMPACT ON SCHOOLS

APPLICATION #:

11 0320 00

SUMMARY

The proposed 6 single family lots are estimated to have the following impact on the following schools:

Projected # of students for this development:

Elementary Students: 2	
Secondary Students: 1	

September 2012 Enrolment/School Capacity


Cedar Hills Elementary		
Enrolment (K/1-7):	28 K + 322	
Capacity (K/1-7):	40 K + 450	
L. A. Matheson Secondary		
Enrolment (8-12):		1332
Nominal Capacity (8-12):		1400
Functional Capacity*(8-12):		1512

School Enrolment Projections and Planning Update:


The following tables illustrate the enrolment projections (with current/approved ministry capacity) for the elementary and secondary schools serving the proposed development.

There are no new capital projects proposed at the elementary school and no new capital projects identified for the secondary school. The capacity at Cedar Hills Elementary has been adjusted for the implementation of full day Kindergarten and inclusion of a "Strongstart" program for preschool age children and their parents. Space utilization options are being considered to reduce capacity shortfall at Kwantlen Park Secondary and space surplus at LA Matheson Secondary. The proposed development will not have an impact on these projections.

Cedar Hills Elementary

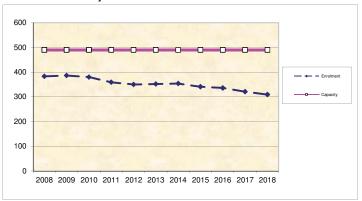

L. A. Matheson Secondary

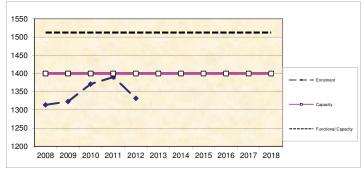

*Functional Capacity at secondary schools is based on space utilization estimate of 27 students per instructional space. The number of instructional spaces is estimated by dividing nominal facility capacity (Ministry capacity) by 25.

BUILDING GUIDELINES SUMMARY

Surrey Project no: 7911-0320-00

Project Location: 12205 / 12207 – 96 Ave., 12215 / 12217- 96 Ave., 12229

- 96 Avenue, 12188 - 97 Avenue, 12220 / 12222 - 97

Avenue, and 12244 - 97 Avenue, Surrey, B.C.

Design Consultant: Tynan Consulting Ltd., (Michael E. Tynan)

The draft Building Scheme proposed for this Project has been filed with the City Clerk. The following is a summary of the Residential Character Study and the Design Guidelines which highlight the important features and form the basis of the draft Building Scheme.

1. Residential Character

1.1 General Description of the Existing and/or Emerging Residential Character of the Subject Site:

South of the subject site is L.A. Matheson school which is not relevant to the building scheme. The single family residential portion of this area was built out over a time period spanning from the pre-1950's to the 2000's. The age distribution from oldest to newest is: more than 60 years old (15%), 60 years old (10%), 50 years old (25%), 40 years old (25%), 30 years old (10%), 20 years old (10%), 10 years old (5%). This is best described as an "old growth area".

Most homes are in the 3000-3550 sq.ft. size range. Home size distribution in this area is as follows: under 1000 sq.ft. (21%), 1000-1500 sq.ft. (11%), 2001-2500 sq.ft. (5%), 2501-3000 sq.ft. (21%), 3001-3550 sq.ft. (32%), over 3550 sq.ft. (11%), Styles found in this area include: "Old Urban" (60%), "West Coast Traditional (English Tudor emulation)" (5%), "West Coast Traditional (Spanish emulation)" (5%), "West Coast Modern" (5%), "Modern California Stucco" (10%), "Heritage (Old B.C.)" (5%), "Neo-Traditional" (10%). The best character description for this area is "varied old urban". Home types include: Bungalow (15%), Bungalow with aboveground basement (15%), Basement Entry (30%), Cathedral Entry (25%), Two-Storey (10%), DUPLEX - Basement Entry (5%),

The massing scale found on neighbouring homes ranges from simple, small, low mass structures to high scale, box-like structures. The massing scale distribution is: low mass structures (15%), mid-scale structures (30%), high scale structures (10%), high scale structures with box-like massing resulting from locating the upper floor directly above or beyond the floor below (45%). The scale range for the front entrance element is: one storey (60%), 1.1/2 storey front entrance (35%), 2.1/2 storey front entrance (5%).

Most homes have a low slope roof. Roof slopes include: low slope (flat to 5:12) = (56)%, moderate slope (6:12 to 7:12) = (18)%, steeply sloped (8:12 and steeper) = (28)%. Main roof forms (largest truss spans) include: common hip (35%), common gable (55%), Flat (5%), Mansard (5%). Feature roof projection types include: none (40%), common hip (25%), common gable (30%), Dutch hip (5%). Roof surfaces include: tar and gravel (30%), interlocking tab type asphalt shingles (35%), rectangular profile type asphalt shingles (10%), concrete tile (shake profile) (15%), and cedar shingles (10%).

Main wall cladding materials include: horizontal cedar siding (5%), vertical channel cedar siding (9%), horizontal vinyl siding (27%), vertical vinyl siding (9%), stucco cladding (50%), Feature veneers on the front façade include: no feature veneer (38%), brick (29%), stone (10%), horizontal cedar (19%), Tudor style battens over stucco (5%). Wall cladding and trim colours include: Neutral (white, cream, grey, black) (53%), Natural (earth tones) (26%), Primary derivative (red, blue, yellow) (21%).

Covered parking configurations include: No covered parking (26%), Double carport (5%), Double garage (37%), Rear garage (32%).

A variety of landscaping standards are evident ranging from natural state' (little or no improvements) to average modern urban. Overall however, landscape standards are substantially lower than those normally required in post year 2000's subdivisions on RF zoned lots in Surrey, and therefore do not provide suitable context for the subject site. Driveway surfaces include: no driveway (5%), gravel (15%), asphalt (40%), broom finish concrete (15%), exposed aggregate (5%), interlocking masonry pavers (5%), rear driveway (15%).

Ten percent of homes (2 homes of 21 surveyed) can be considered 'context homes' (as identified in the residential character study). Ninety percent of homes can be considered 'non-context', and are not recommended for emulation. However, the appropriate strategy is to set design and articulation standards to common high new levels for new RF zone subdivisions, rather than to emulate the existing homes.

1.2 Prevailing Features of the Existing and Surrounding Dwellings Significant to the Proposed Building Scheme:

- 1) Context Homes: Only two homes in the surrounding area provide desirable residential design context. These homes are located at 12229 96 Avenue, and 12237 97 Avenue. However, as stated above, the recommendation is to apply common new high quality design standards for RF zone subdivisions rather than to emulate these two specific homes.
- 2) <u>Style Character:</u> "Neo-Traditional" and "Neo-Heritage" styles are compatible with the wide range of styles found in this area, and are recommended. Note that the style range is no longer specified in the building scheme.
- 3) <u>Home Types:</u> A wide variety of home types including Basement Entry, Cathedral Entry, Bungalow, and Two-Storey are found in this area. Home type will not be restricted in the building scheme.
- 4) <u>Massing Designs</u>: The two context homes provide desirable massing context. These homes are well balanced and correctly proportioned.
- 5) <u>Front Entrance Design:</u> Front entrance porticos range from one to 2½ storeys in height. The most common recommended entrance height for RF scale homes is 1 to 1½ storeys, which will be the recommendation at this site.
- 6) <u>Exterior Wall Cladding</u>: A wide range of materials have been used in this area, and a wide range can be permitted, including vinyl.
- 7) Roof surface: Roof surfaces include tar and gravel, asphalt shingles, concrete tiles, and cedar shingles. Roofing material is not a defining characteristic of this area and so flexibility is warranted.
- 8) Roof Slope: A wide range of roof slopes from "flat" to 12:12 have been used. The recommendation is to adopt a common standard for RF zone lots; 7:12 minimum.

Streetscape:

There are a wide variety of old urban homes constructed on large RF and RM-D zoned lots. These homes exhibit a "varied" rather than uniform character, and range from small (900 sq.ft) simple 60+ year old rectangular Bungalows, to 3000+ sq.ft. box-like Basement Entry homes to well balanced and proportionally correct "Neo-Traditional" style Two-Storey homes that meet modern development standards. Landscapes range from "near native" (sod and native trees only), to "above-average modern urban", though most landscapes are substandard in comparison to most lots recently developed.

2. Proposed Design Guidelines

2.1 Specific Residential Character and Design Elements these Guidelines Attempt to Preserve and/or Create:

- the new homes are readily identifiable as one of the following styles: "Neo-Traditional", or "Neo-Heritage". Note that the proposed style range is not contained within the building scheme, but is contained within the residential character study which forms the basis for interpreting building scheme regulations.
- a new single family dwelling constructed on any lot meets year 2000's design standards, which
 include the proportionally correct allotment of mass between various street facing elements, the
 overall balanced distribution of mass within the front facade, readily recognizable style-authentic
 design, and a high trim and detailing standard used specifically to reinforce the style objectives
 stated above.
- trim elements will include several of the following: furred out wood posts, articulated wood post bases, wood braces and brackets, louvered wood vents, bold wood window and door trim, highly detailed gable ends, wood dentil details, stone or brick feature accents, covered entrance verandas and other style-specific elements, all used to reinforce the style (i.e. not just decorative).
- the development is internally consistent in theme, representation, and character.
- the entrance element will be limited in height (relative dominance) to 1 to 1 ½ storeys.

2.2 Proposed Design Solutions:

Interfacing Treatment with existing dwellings)

Only two existing neighbouring homes provide suitable context for the subject site. The recommendation however, it to employ standards used in most new RF zone subdivisions in Surrey subsequent to 2010 rather than to emulate existing homes. The new character area proposed will be compatible with the existing homes; "Neo-Traditional" and "Neo-Heritage" styles are recommended, though these styles are not required in the building scheme.

Exterior Materials/Colours:

Stucco, Cedar, Vinyl, Hardiplank, Brick, and Stone.

"Natural" colours such as browns, greens, clays, and other earth-tones, and "Neutral" colours such as grey, white, and cream are permitted. "Primary" colours in subdued tones such as navy blue, colonial red, or forest green can be considered providing neutral trim colours are used, and a comprehensive

colour scheme is approved by the consultant. "Warm" colours such as pink, rose, peach, salmon are not permitted. Trim colours: Shade variation of main colour, complementary,

neutral, or subdued contrast only.

Roof Pitch: Minimum 7:12.

Roof Materials/Colours: Cedar shingles, shake profile concrete roof tiles, shake profile

asphalt shingles with a raised ridge cap, and new environmentally sustainable roofing products, providing that aesthetic properties of the new sustainable materials are equal to or better than that of the traditional roofing products. Grey,

black, or brown only.

In-ground basements: Permitted, subject to determination that service invert locations

are sufficiently below grade. Basements will appear

underground from the front.

Treatment of Corner Lots: Not applicable - there are no corner lots

Landscaping: Moderate to high modern urban standard: Tree planting as

specified on Tree Replacement Plan plus minimum 17 shrubs of a minimum 3 gallon pot size. Sod from street to face of home. Driveways: exposed aggregate, interlocking masonry pavers,

stamped concrete, or broom finish concrete.


Compliance Deposit: \$5,000.00

Summary prepared and submitted by: Tynan Consulting Ltd. Date: July 24, 2012

Reviewed and Approved by: Multill Date: July 24, 2012

		TREE PRESER	ATION SUMMARY		
	ect Location: istered Arborist:	Trevor Cox, MCII ISA Certified Arb Certified Tree Ri	orist (PN1920A)		
	ailed Assessment of the existin nmary of the tree assessment r	_	-	e. The following is	a
1.	General Tree Assessment of out buldings scattered throu		ree acre parcel of land with si	x residences and r	numerous
2.	Summary of Proposed Tree F	emoval and Placer	ment:		
	The summary will be availab	e before final adop	otion.		
	Number of Protected Trees I	dentified		4	(A)
	Number of Protected Trees of	leclared high risk d	ue to natural causes	0	(B)
	Number of Protected Trees t	o be removed		0	(C)
	Number of Protected Trees t	o be Retained	(A-B-C)	4	(D)
	Number of Replacement Tre	es Required	(C-B) x 2	0	(E)
	Number of Replacement Tre	es Proposed		0	(F)
	Number of Replacement Tre	es in Deficit	(E-F)		(G)
	Total Number of Protected a	nd Replacement Tr	rees on Site (D+F)	4	(H)
	Number of Lots Proposed in	the Project		6	(1)
	Average Number of Trees pe	r Lot	(H / I)	0.67	
3.	Tree Survey and Preservation	n / Replacement Pla	an		
	Tree Survey and Preservation	n / Replacement Pla	an is attached		
	This plan will be available be	fore final adoption			
	nmary prepared and mitted by:		Jan 3		ry 8, 2014
		Arborist		Date	

2

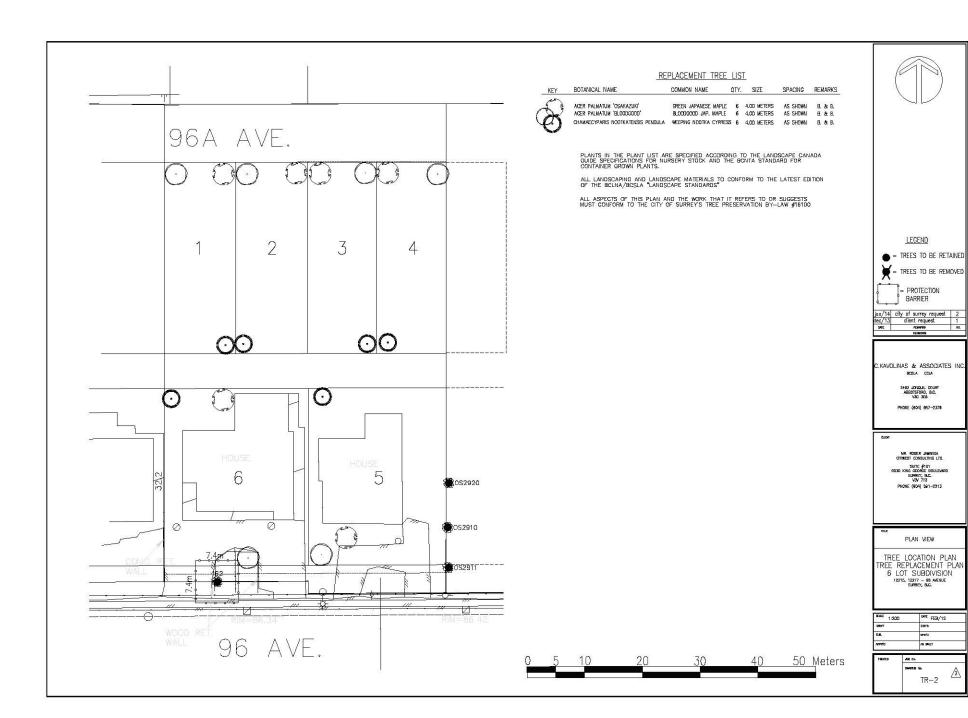

CITY OF SURREY

(the "City")

DEVELOPMENT VARIANCE PERMIT

NO.: 7911-0320-00

Issued To: NARINDER AUJLA

Address of Owner: 12322 - 64A Avenue

Surrey, BC V₃W ₅Y₅

Issued To: HARMINDER S CHAHAL

Address of Owner: 7295 - 130A Street

Surrey, BC V₃W 6E₉

Issued To: INDERJIT S RANDHAWA

HARJIT K RANDHAWA

TARSEM S SARAI GURWINDER K SARAI

Address of Owner: 12229 - 96 Avenue

Surrey, BC V₃V₁W₆

Issued To: GURPREET PUREWAL

Address of Owner: 16270 - 60 Avenue

Surrey, BC V₃S₁S₄

(collectively referred to as "the Owner")

- 1. This development variance permit is issued subject to compliance by the Owner with all statutes, by-laws, orders, regulations or agreements, except as specifically varied by this development variance permit.
- 2. This development variance permit applies to that real property including land with or without improvements located within the City of Surrey, with the legal description and civic address as follows:

Parcel Identifier: 003-654-761 West Half Lot "A" Section 31 Block 5 North Range 2 West New Westminster District Plan 13298

12229 - 96 Avenue

Parcel Identifier: 010-415-131 Lot "E" Section 31 Block 5 North Range 2 West New Westminster District Plan 21342

12215 and 12217 - 96 Avenue


		(the "Land")
3.	(a)	As the legal description of the Land is to change, the City Clerk is directed to insert the new legal description for the Land once title(s) has/have been issued, as follows:
		Parcel Identifier:
	(b)	If the civic address(es) change(s), the City Clerk is directed to insert the new civic address(es) for the Land, as follows:
4.	Surrey	Zoning By-law, 1993, No. 12000, as amended is varied as follows:
	(a)	In Section F of Part 16 Single Family Residential Zone (RF), the minimum rear yard setback for the principal building is reduced from 7.5 metres (25 ft.) to 4.6 metres (15 ft.) for proposed Lot 5; and
	(b)	In Section F of Comprehensive Development By-law No), the minimum rear yard setback for the principal building is reduced from 15 metres (50 ft.) to 7.3 metres (24 ft.) for proposed Lot 6.
5.	struct this de additi	evelopment variance permit applies to only the <u>portion of the buildings and</u> <u>ures on the Land</u> shown on Schedule A which is attached hereto and forms part of evelopment variance permit. This development variance permit does not apply to ons to, or replacement of, any of the existing buildings shown on attached Schedule ich is attached hereto and forms part of this development variance permit.
6.		and shall be developed strictly in accordance with the terms and conditions and ions of this development variance permit.


This development variance permit shall lapse unless the subdivision, as conceptually 7. shown on Schedule A which is attached hereto and forms part of this development variance permit, is registered in the New Westminster Land Title Office within three (3) years after the date this development variance permit is issued.


8.	The terms of this development variance perm persons who acquire an interest in the Land.	iit or any amendment to it, are binding on all
9.	This development variance permit is not a bu	ilding permit.
	ORIZING RESOLUTION PASSED BY THE CO D THIS DAY OF , 20 .	UNCIL, THE DAY OF , 20 .
		Mayor – Dianne L. Watts
		City Clerk – Jane Sullivan

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SCHEDULE



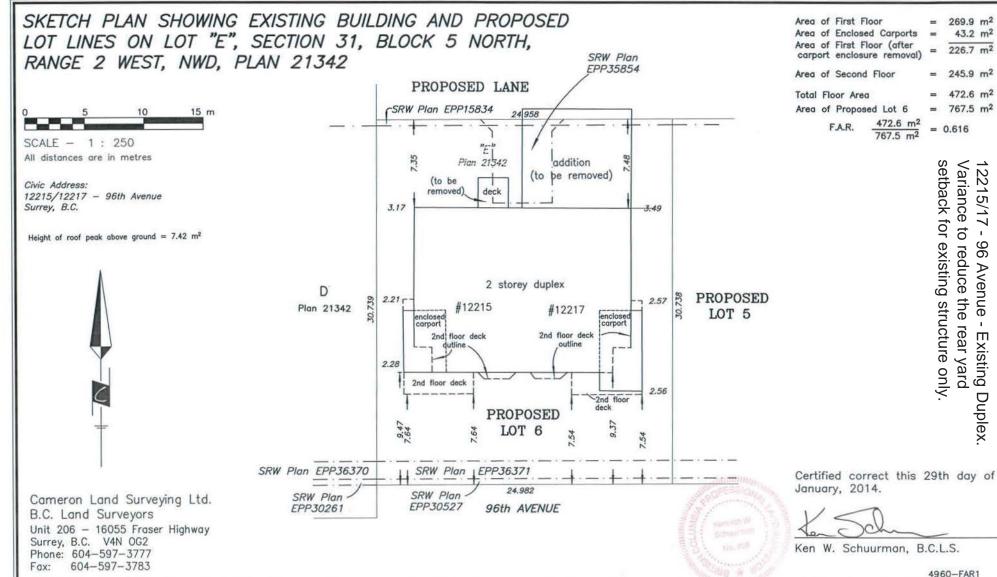

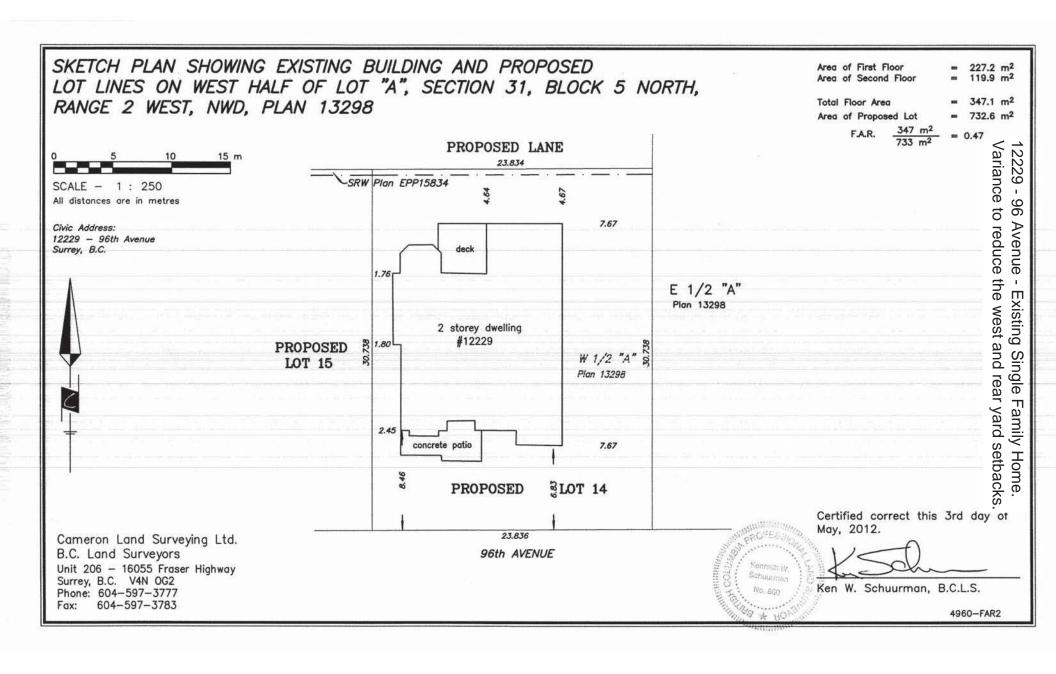

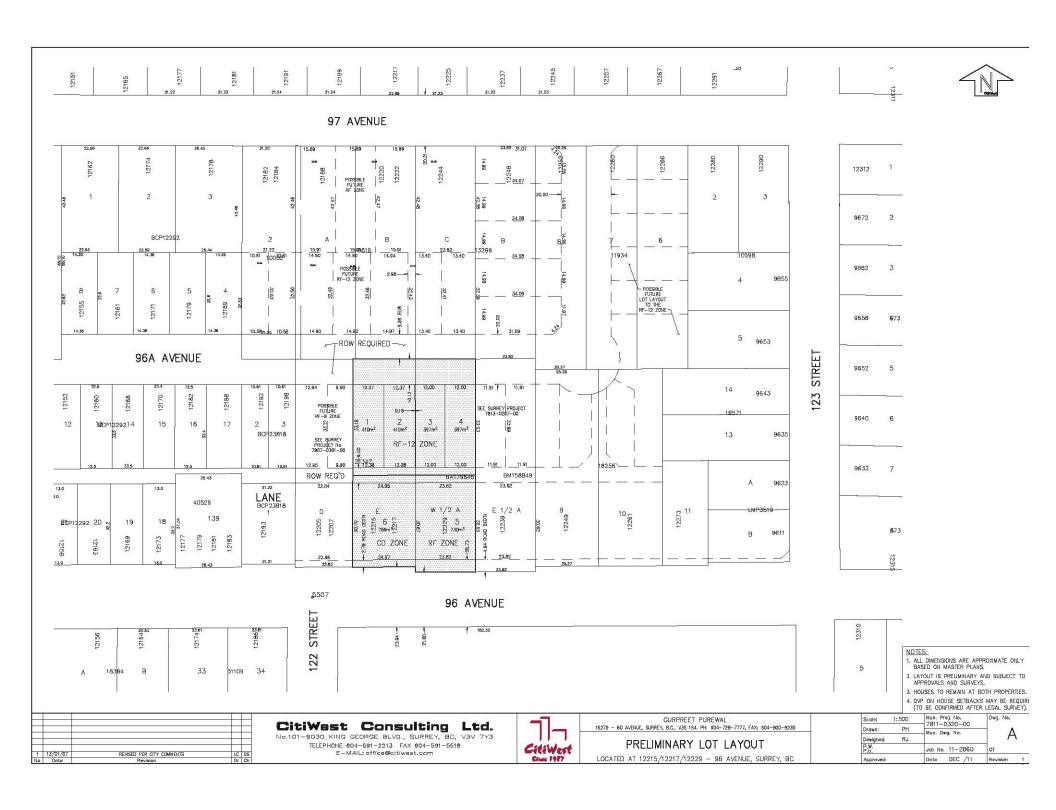COSM®S

City of Surrey Mapping Online System



The data provided is compiled from various sources and is NOT warranted as to its accuracy or sufficiency by the City of Surrey. This information is provided for information and convenience purposes only. Lot sizes, legal descriptions and encumberances must be confirmed at the Land Title Office. Use and distribution of this map is subject to all copyright and disclaimer notices at cosmos.surrey.ca.

Enter Map Description



Scale: 1:2,555

Map created on: February-06-14

CITY OF SURREY

BYLAW NO.	
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THE CITY COUNCIL of the City of Surrey ENACTS AS FOLLOWS:

1. Surrey Zoning By-law, 1993, No. 12000, as amended, is hereby further amended, pursuant to the provisions of Section 903 of the <u>Local Government Act</u>, R.S.B.C. 1996 c. 323, as amended by changing the classification of the following parcels of land, presently shown upon the maps designated as the Zoning Maps and marked as Schedule "A" of Surrey Zoning By-law, 1993, No. 12000, as amended as follows:

FROM: DUPLEX RESIDENTIAL ZONE (RM-D)

TO: COMPREHENSIVE DEVELOPMENT ZONE (CD)

Portion of Parcel Identifier: 010-415-131

Lot "E" Section 31 Block 5 North Range 2 West New Westminster District Plan 21342 as shown on the Survey Plan attached hereto and forming part of this Bylaw as Schedule A, certified correct by Ken W. Schuurman, B.C.L.S. on the 29th day of January 2014, containing 912.6 square metres, called Block A.

Portion of 12215 and 12217 - 96 Avenue

(hereinafter referred to as the "Lands")

2. The following regulations shall apply to the *Lands*:

A. Intent

This Zone is intended to accommodate and regulate *duplex* dwellings on an *urban lot*.

B. Permitted Uses

Lands and structures shall be used for one (1) duplex provided that the minimum lot size shall be 765 square metres [8,235 sq. ft.] and the minimum lot width shall be 24 metres [80 ft.]. Where the lot under this zone is subdivided into strata lots, only 1 dwelling unit shall be permitted within each of the strata lots and in the case of such a subdivision, each of the permitted dwelling units must form part of the duplex constructed on the lot as it existed prior to the subdivision.

C. Lot Area

Not applicable to this Zone.

D. Density

- 1. For *building* construction within a *lot*, the maximum allowable floor area shall be 475 sq. m. [5,100 sq. ft.].
- 2. For the purpose of this Section, the following must be included in the calculation of floor area:
 - (a) The *basement*;
 - (b) The combined area of all covered outdoor spaces with a height of 1.8 metres [6 ft.] or greater, except for a maximum of 20 sq. m. [215 sq. ft.] per *dwelling unit*, of which 10 square metres [108 sq. ft.] per *dwelling unit* shall be reserved for a covered *deck* or veranda;
 - (c) Floor area with extended height, including staircases, must be multiplied by 2, where the extended height exceeds 3.7 metres [12 ft.], except for a maximum of 19 square metres [200 sq.ft.] per dwelling unit;
 - (d) Garages and carports; and
 - (e) The area of any *accessory building* and *structure* in excess of 10 square metres [105 sq.ft.].

E. Lot Coverage

The maximum *lot coverage* shall be 33%.

F. Yards and Setbacks

Buildings and *structures* shall be sited in accordance with the following minimum *setbacks*:

Use	Setback	Front Yard	Rear Yard	Side Yard
Principal Building		7.5 m. [25 ft.]	15 m. [50 ft.]	1.8 m. [6 ft.]
Accessory Buildings and Structures Greater Than 10 square metres [105 sq.ft.] in Size		18 m. [60 ft.]	1.8 m. [6 ft.]	1.0 m. [3 ft.]
Other Accessory Buildings and Structures		18 m. [60 ft.]	o.o m.	o.o m.

Measurements to be determined as per Part 1 Definitions, of Surrey Zoning By-law, 1993, No. 12000, as amended.

G. Height of Buildings

Measurements to be determined as per Part 1 Definitions, of Surrey Zoning By-law, 1993, No. 12000, as amended.

- 1. *Principal building*: The building *height* shall not exceed 9 metres [30 ft.].
- 2. <u>Accessory buildings and structures</u>: The building *height* shall not exceed 4 metres [13 ft.] except that where the roof slope and construction materials of an *accessory building* are the same as that of the *principal building*, the *building height* of the *accessory building* may be increased to 5 metres [16.5 ft.].

H. Off-Street Parking and Loading/Unloading

- 1. Resident and visitor *parking spaces* shall be provided as stated in Part 5 Off-Street Parking and Loading/Unloading of Surrey Zoning By-law, 1993, No. 12000, as amended.
- 2. Outside parking or storage of *campers*, boats and *vehicles* including cars, trucks and *house trailers* ancillary to a *dwelling unit* shall be limited to:
 - (a) A maximum of 2 cars or trucks;
 - (b) *House trailer, camper* or boat, provided that the combined total shall not exceed 1; and

- (c) The total amount permitted under (a) and (b) shall not exceed 2.
- 3. *Vehicle* access to a *lot* is permitted only from the lane.
- 4. A single or double garage or a single or double carport is permitted for each *dwelling unit*.
- 5. No outside parking or storage of a *house trailer* or boat is permitted within the *front yard setback*, or within 1 metre [3 ft.] of the *side lot line*.

I. Landscaping

- 1. The parking or storage of house trailers or boats shall be adequately screened by compact evergreen trees or shrubs at least 1.8 metres [6 ft.] in height and located between the said house trailer or boat and any point on the lot line within 7.5 metres [25 ft.] of the said house trailer or boat, in order to obscure the view from the abutting lot or street, except where the driveway or the parking area is used for parking or storage of a house trailer or boat, the landscape screen is not required within the said driveway.
- 2. All portions of the *lot* not covered by *buildings*, *structures* or paved areas shall be landscaped including the retention of mature trees. This *landscaping* shall be maintained.

J. Special Regulations

- 1. Basement access and basement wells are permitted only between the *principal building* and the *rear lot line* and must not exceed a maximum area of 28 square metres [300 sq. ft.] per *dwelling unit*, including the stairs.
- 2. Secondary suites are not permitted.

K. Subdivision

Lots created through subdivision in this Zone shall conform to the following minimum standards:

Lot Size	Lot Width	Lot Depth
765 sq. m.	24 metres	28 metres
[8,235 sq.ft.]	[80 ft.]	[90 ft.]

Dimensions shall be measured in accordance with Section E.21, Part 4 General Provisions, of Surrey Zoning By-law, 1993, No. 12000, as amended.

L. Other Regulations

In addition to all statutes, bylaws, orders, regulations or agreements, the following are applicable, however, in the event that there is a conflict with the provisions in this Comprehensive Development Zone and other provisions in Surrey Zoning Bylaw, 1993, No. 12000, as amended, the provisions in this Comprehensive Development Zone shall take precedence:


- Definitions are as set out in Part 1 Definitions of Surrey Zoning By-law, 1993, No. 12000, as amended.
- 2. Prior to any use, the *Lands* must be serviced as set out in Part 2 Uses Limited, of Surrey Zoning By-law, 1993, No. 12000, as amended and in accordance with the servicing requirements for the RM-D Zone as set forth in the Surrey Subdivision and Development By-law, 1986, No. 8830, as amended.
- 3. General provisions are as set out in Part 4 General Provisions of Surrey Zoning By-law, 1993, No. 12000, as amended.
- 4. Additional off-street parking requirements are as set out in Part 5
 Off-Street Parking and Loading/Unloading of Surrey Zoning By-law, 1993,
 No. 12000, as amended.
- 5. Sign regulations are as set out in Surrey Sign By-law, 1999, No. 13656, as amended.
- 6. Special *building setbacks* are as set out in Part 7 Special Building Setbacks, of Surrey Zoning By-law, 1993, No. 12000, as amended.
- 7. *Building* permits shall be subject to the Surrey Building Bylaw, 2012, No. 17850, as amended.
- 8. Building permits shall be subject to Surrey Development Cost Charge By-law, 2013, No. 17856, as may be amended or replaced from time to time, and the development cost charges shall be based on the RM-D Zone.
- 9. Tree regulations are set out in Surrey Tree Protection By-law, 2006, No. 16100, as amended.
- 10. Development permits may be required in accordance with the Surrey *Official Community Plan*, 1996, By-law No. 12900, as amended.

3.	This By-law shall be cited for all Amendment By-law, , No.		Zoning Bylaw,	, 1993, No. 12	,000,
PASSE	D FIRST READING on the	th day of	, 20 .		
PASSE	D SECOND READING on the	th day of	, 20 .		
PUBLIC	C HEARING HELD thereon on th	ne th day of		, 20 .	
PASSE	D THIRD READING on the	th day of	, 20 .		
	NSIDERED AND FINALLY ADOF ate Seal on the th day of	2	layor and Cle	rk, and seal	ed with the
					MAYOR
					CLERK

SURVEY PLAN TO ACCOMPANY CITY OF SURREY REZONING BYLAW NO. _____ OF LOT "E", PLAN 21342; THE WEST HALF OF LOT "A" PLAN 13298; BOTH OF SECTION 31, BLOCK 5 NORTH, RANGE 2 WEST, NWD

City of Surrey B.C.G.S. 92G.016

Fax: 604-597-3783

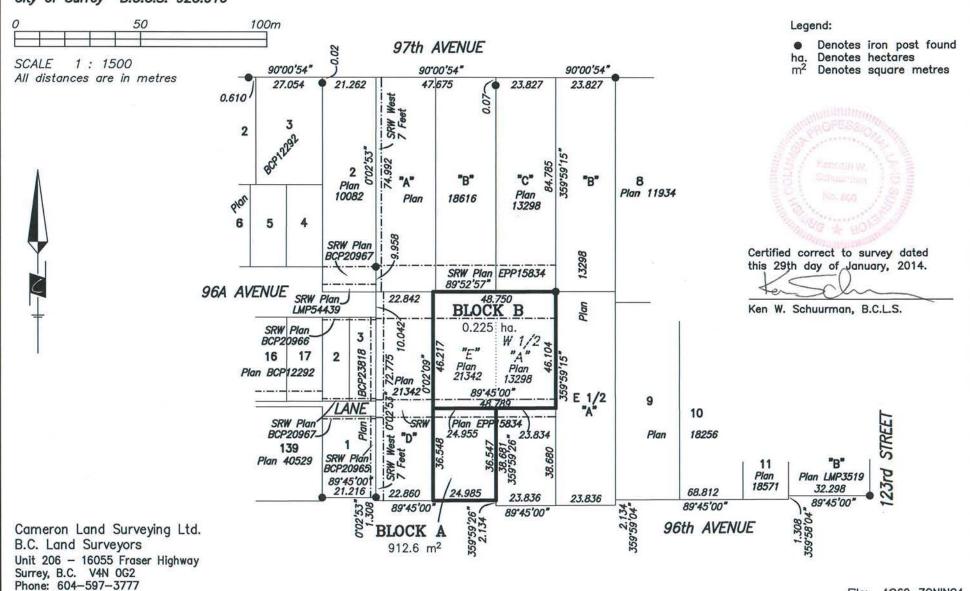

File: 4960-ZONING4