

# City of Surrey PLANNING & DEVELOPMENT REPORT File: 7913-0257-00

Planning Report Date: March 31, 2014

#### PROPOSAL:

• **Rezoning** from RF to CD (based upon RM-70)

• Development Permit

in order to permit the development of two, 6-storey, apartment buildings in the City Centre.


LOCATION: 13773, 13783, 13793 and 13803 -

101 Avenue; and 10110 - 137A Street

**OWNERS:** Jagtar K Brar and Baldev S Brar

**ZONING:** RF

**OCP DESIGNATION:** Multiple Residential

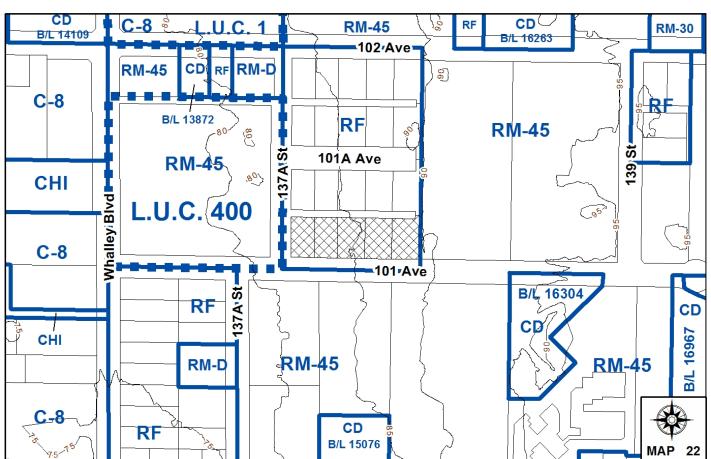

## **RECOMMENDATION SUMMARY**

- By-law Introduction and set date for Public Hearing for Rezoning.
- Approval to draft Development Permit.

# **DEVIATION FROM PLANS, POLICIES OR REGULATIONS**

None.

# **RATIONALE OF RECOMMENDATION**

- Complies with the "Multiple Residential" designation in the OCP and complies with the "Low to Mid Rise up to 2.5 FAR" designation of the City Centre Land Use Plan.
- The proposed density and building form are appropriate for this part of City Centre.
- The proposed development assists in achieving a finer grained road network, with the applicant providing road dedication for the new 138 Street at the east side of the subject site.

#### **RECOMMENDATION**

The Planning & Development Department recommends that:

1. Council file By-law No. 16954 and close Land Development Application No. 7907-0375-00 and all applications associated with this project.

- 2. A By-law be introduced to rezone the subject site from "Single Family Residential Zone (RF)" (By-law No. 12000) to "Comprehensive Development Zone (CD)" (By-law No. 12000) and a date be set for Public Hearing.
- 3. Council authorize staff to draft Development Permit No. 7913-0257-00 generally in accordance with the attached drawings (Appendix II).
- 4. Council instruct staff to resolve the following issues prior to final adoption:
  - (a) ensure that all engineering requirements and issues including restrictive covenants, dedications, and rights-of-way where necessary, are addressed to the satisfaction of the General Manager, Engineering;
  - (b) submission of a subdivision layout to the satisfaction of the Approving Officer;
  - (c) submission of a finalized tree survey and a statement regarding tree preservation to the satisfaction of the City Landscape Architect;
  - (d) submission of a finalized landscaping plan and landscaping cost estimate to the specifications and satisfaction of the Planning and Development Department;
  - (e) resolution of all urban design issues to the satisfaction of the Planning and Development Department;
  - (f) the applicant address the concern that the development will place additional pressure on existing park facilities to the satisfaction of the General Manager, Parks, Recreation and Culture;
  - (g) demolition of existing buildings and structures to the satisfaction of the Planning and Development Department; and
  - (h) registration of a Section 219 Restrictive Covenant to adequately address the City's needs with respect to public art, to the satisfaction of the General Manager Parks, Recreation and Culture.

#### **REFERRALS**

**Engineering:** 

The Engineering Department has no objection to the project subject to the completion of Engineering servicing requirements, as outlined in Appendix III.

# School District: **Projected number of students from this development:**

5 Elementary students at Lena Shaw Elementary School 3 Secondary students at Guildford Park Secondary School

(Appendix IV)

The applicant has advised that the project will be constructed in two phases, with proposed Building 2 (the market development) in the east portion to be constructed first, with proposed occupancy by October 2016, with proposed Building 1 (the rental building) in the west to follow and to be ready for occupancy by October 2017.

Parks, Recreation & Culture:

Parks has some concerns about the pressure this project will place on existing Parks, Recreation and Culture facilities in the neighbourhood. The applicant should meet with Parks staff as soon as possible, to address this concern.

Surrey Fire Department: No concerns.

#### SITE CHARACTERISTICS

<u>Existing Land Use:</u> There is a single family dwelling on each of the five properties. The subject

site slopes downward from east to west. There is an existing sanitary sewer right-of-way located along the west property line of the most easterly lot (13803-101 Avenue), which will be required to be relocated as part of the

proposed redevelopment of the site.

# **Adjacent Area:**

Direction	Existing Use	OCP Designation	Existing Zone
North (Across gravel lane):	Single family dwellings.	Multiple Residential	RF
East:	2-storey townhouse development.	Multiple Residential	RM-45
South (Across 101 Avenue):	3-storey apartment building.	Multiple Residential	RM-45
West (Across 137A Street):	4-storey apartment building.	Multiple Residential	LUC No. 400 (underlying RM-45)

#### **DEVELOPMENT CONSIDERATIONS**

• The development application encompasses five (5) properties at 13773, 13783 and 13793 and 13803 - 101 Avenue and 10110 - 137A Street in the City Centre area.

• The subject site is approximately 3,585 square metres (0.89 acre) in net area, after road dedication has been deducted. The five (5) properties are currently zoned "Single Family Residential Zone (RF)" and designated Multiple Residential in the Official Community Plan (OCP). The subject site is designated "Low to Mid Rise up to 2.5 FAR" in the City Centre Land Use Concept Plan.

- The applicant has applied for a rezoning from "Single Family Residential Zone (RF)" to "Comprehensive Development Zone (CD)"(based upon RM-70) and a Development Permit to allow for the development of 104 dwelling units, within two, 6-storey apartment buildings.
- The floor area ratio (FAR) proposed for this development is 2.5, which complies with the maximum 2.5 FAR proposed under the City Centre Land Use Concept Plan. However, given the 5.0-metre (16 ft.) wide dedication of 138 Street, along the east property line, the City Centre Land Use Concept Plan allows for the developer to include this portion of road dedication in the gross density calculation. Therefore, based upon this provision, the proposed density is 2.4 FAR.
- The development will consist of two 6-storey apartment buildings, which can be connected through an outdoor amenity area at the second floor of Building 1 and the main floor of Building 2, but will each have their own separate entries on 101 Avenue.
- The west building, proposed Building 1, is to be a purpose-built rental building, with the east building, proposed Building 2, to be sold as a market development. The developer's intent is to stratify all of the dwelling units and then rent out the units in proposed Building 1.
- The vehicular access to both buildings will be separate and will be situated from the rear lane (north), which will lead to the development's underground parkade.
- Proposed Building 1 (rental building), on the western portion, will consist of a total of 49 dwelling units:
  - o 7 studio;
  - o 24 1-bedroom;
  - o 5 1-bedroom and den;
  - o 6 2-bedroom; and
  - o 7 townhouse units, with 2 bedrooms.
- Proposed Building 2, on the eastern portion, will consist of a total of 55 dwelling units:
  - o 7 studio;
  - o 25 1-bedroom;
  - o 16 1-bedroom and den; and
  - o 7 townhouse units, with 2 bedrooms.
- The dwelling units will range in size from 50 square metres (543 sq.ft.) for a studio unit to 133 square metres (1,436 sq.ft.) for the largest townhouse unit.

## **Amenity Space Areas**

• As per Zoning By-law requirements, 3 square metres/32 sq.ft. of indoor amenity space is required per dwelling unit. Therefore, based upon 104 dwelling units, 312 square metres (3,358 sq.ft.) of indoor amenity space is required.

- For Building 1, 147 square metres (1,582 sq.ft.) of indoor amenity space is required based upon 49 dwelling units. In proposed Building 1, one large 172-square metre (1,854 sq.ft.) room will incorporate a games area and a common room, which will include a kitchen and washrooms. This exceeds the minimum requirement of indoor amenity space as per the Zoning By-law.
- For Building 2, 165 square metres (1,776 sq.ft.) of indoor amenity space is required based upon 55 dwelling units. In proposed Building 2, a 129-square metre (1,389 sq.ft.) multi-purpose and common room will incorporate two washrooms and a kitchen for various activities. A separate 37-square metre (400 sq.ft.) meeting room is also proposed, for a total of 166 square metres (1,787 sq.ft.) of indoor amenity space, which slightly exceeds the minimum requirement of indoor amenity space as per the Zoning By-law.
- In total, for the entire development, 338 square metres (3,643 sq.ft.) of indoor amenity space is proposed.
- As per Zoning By-law requirements, 3 square metres/32 sq.ft. of outdoor amenity space is required per dwelling unit. Therefore, based upon 104 dwelling units proposed for both buildings, 312 square metres (3,358 sq.ft.) of outdoor amenity space is required.
- The majority of the proposed outdoor amenity space areas are located immediately outside of the indoor amenity space areas, allowing for a direct connection between the indoor and outdoor amenity spaces. For the proposed rental building (Building 1), 75 square metres (805 sq.ft.) of outdoor amenity space is proposed and will incorporate patio seating areas. For the market apartment building (Building 2), 110 square metres (1,182 sq.ft.) of outdoor amenity space is proposed and will incorporate a children's play area and landscaped seating areas.
- A 282-square metre (3,032 sq.ft.) outdoor amenity space area is proposed at the second floor of Building 1, connecting to the main floor of Building 2 (above Building 1's indoor amenity room and the parking ramp for Building 2). This will allow for an outdoor area that can be shared between the residents of the two buildings. A children's play area, as well as a seating area, is planned for this space.
- A total of 466 square metres (5,019 sq.ft.) of outdoor amenity space is proposed, which exceeds the minimum requirements of the Zoning By-law.

# Lane and New 138 Street

- There is currently an existing gravel lane located to the north of the subject site. As part of this development, the applicant will be required to construct the lane to full standards.
- A new road connection, 138 Street, is proposed along the eastern edge of the subject site. This new road is to form part of the finer grained road network the City is trying to achieve for the

City Centre area. The intent is that 138 Street will ultimately connect between 104 Avenue to the north and Fraser Highway to the south.

- Road dedication will be provided as part of this development. However, the road will not be constructed until the townhouse site to the east comes forward for redevelopment.
- In the interim, only a sidewalk will be constructed as part of the unopened road allowance.

# PROPOSED CD BY-LAW (Appendix V)

• The proposed CD By-law will be based upon the "Multiple Residential 70 Zone (RM-70)". A table comparing the RM-70 Zone to the proposed CD By-law is provided below:

	Existing RM-70 Zone	Proposed CD By-law	
Land Use	<ul> <li>Multiple unit residential buildings and ground-oriented multiple unit residential buildings.</li> <li>Child care centres.</li> </ul>	The same as permitted in the RM-70 Zone.	
Density (floor area ratio)	1.5 FAR (net)	2.5 FAR (net)	
Lot Coverage	33%	52%	
Building Setbacks (metres)	• 7.5 m from all lot lines.	Front (137A Street) - 4.5 m North - 6.0 m Flanking Street (South) - 4.5 m East (138 Street) - 4.5 m	
Building Height (metres)	50 m	22 M	
Off-Street Parking	<ul> <li>1.04 spaces per dwelling unit, for all studio, 1-bedroom and 1-bedroom with den units.</li> <li>1.2 spaces per dwelling unit, for all 2-bedroom and larger units, including attached townhouse units.</li> <li>0.16 space per dwelling unit for a space per dwe</li></ul>	Parking has been provided in accordance with the Zoning By-law requirements for City Centre.  The underground parking	
	visitors.  • The underground parking structure must be setback a minimum of 2.0 metres (6.6 ft.) from the front lot line.	The underground parking structure will be permitted to be located at 0 metre (0 ft.) at the front lot line.	
Bicycle Parking	<ul> <li>1.2 bicycle spaces for every dwelling unit.</li> <li>6 bicycle spaces for visitors for each multiple residential building.</li> </ul>	Same as RM-70, however, the proposed development will exceed the minimum required.	

• The Zoning By-law requires that 87 residential parking spaces be provided for all 1-bedroom and smaller units, 24 spaces for all 2-bedroom and larger units and 17 visitor parking spaces be provided for a total of 128 parking spaces. The proposed development provides 129 parking spaces overall, which exceeds the required parking by 1 space.

- The CD By-law will allow for the underground parking structure to be located at o metre (o ft.) at the front lot line.
- For bicycle parking, the Zoning By-law requires that 125 bicycle parking spaces be provided for residents and 12 bicycle spaces be provided for visitors. The development proposes 156 bicycle parking spaces overall, which exceeds the minimum required.

## **PRE-NOTIFICATION**

A pre-notification letter was sent on January 28, 2014. As a result, staff received one enquiry requesting information regarding whether the development would be a rental or market development and one letter was received in opposition.

- The letter opposing the proposed development identified the following concerns:
  - The resident does not wish to hear construction traffic;
  - o The resident feels that the development will increase traffic to the area;
  - o There is a concern that the proposed 6-storey building height will place her unit in constant shade; and
  - o The resident does not wish to see additional trees removed.

(The entire area surrounding the resident is within the City Centre Land Use Concept Plan and has the potential for redevelopment to higher densities in the future. The applicant has provided a shadow diagram to show the potential impact of the 6-storey building form on the surrounding buildings. The time of the year which will cause the most shadowing will be December 21, which is the shortest day of the year. Any shadowing will generally impact the immediately adjacent property owners to the north and east and 101 Avenue. The resident lives further south of 101 Avenue at 137A Street and therefore should not be directly impacted by any shadowing from this development.)

#### **DESIGN PROPOSAL AND REVIEW**

- The proposed design works with the slope of the site, by stepping the buildings down from east to west.
- The development will incorporate 2-storey ground-oriented townhouses at all three street frontages, including the future 138 Street along the east, which will remain unconstructed for the time being. The east elevation for proposed Building 2 will be designed to be integrated with this future road.
- Each townhouse unit will include an entry marker and a glass canopy. Terraced landscaping is proposed in front of each townhouse unit to delineate public and private space and to

provide the individual unit patios some privacy. Fencing around the townhouse patios will include metal and glass panels.

- Two separate vehicular entries are proposed from the rear lane, one at the centre of the westerly building (Building 1) and one to the west of the easterly building (Building 2).
- Main entries to Buildings 1 and 2 will be prominent entries, incorporating wood siding and wood soffits into the interior spaces.
- The proposed colour palette is a darker Grey at the base of the buildings, transitioning to a lighter Grey at the top, with a Rust Red used as a contrast colour.
- The building materials will include two types of masonry and the use of a corrugated metal for the Rust Red coloured elements. Windows are to be aluminum window walls with curtain walls for long vertical elements. PVC windows are proposed for the remainder.
- A balcony is proposed for every above ground dwelling unit and shall be a minimum of 5.6 sq.m. (60 sq.ft.) in size. The balconies and roof overhangs will incorporate wood soffits.
- The top floor units will include high ceilings, sloping rooftops and the roofs will all have large overhangs.
- Corner plazas are proposed at 137A Street and 101 Avenue and at the new 138 Street and 101
  Avenue, featuring a mixture of tree and shrub planting, water features, benches and visitor
  bike parking.
- The mid-block plaza and secondary entries for Buildings 1 and 2 incorporate landscaping, benches and a community library kiosk.

# TREE PRESERVATION AND REPLACEMENT (Appendix VI)

- An arborist report was prepared by Mike Fadum and Associates Ltd., dated November 14, 2013.
- The report identifies 15 protected trees within the subject site and immediately adjacent to the subject site, which will be impacted by the proposed development. The trees are identified below:

Tree Species	No. of Trees	Trees to be Retained	Trees to be Removed
Western Red Cedar	4	1	3
Cherry	4	0	4
Douglas Fir	2	0	2
Falsecypress	1	0	1
Western Hemlock	1	0	1
Plum	2	0	2
Walnut	1	0	1
TOTAL	15	1	14

• Of these 15 trees, 14 trees are proposed to be removed due to the location of the underground parkade or due to their location within the road dedication areas. One (1) Western Red Cedar has been identified for retention at this time, but it is located within the road dedication area for 138 Street. Additional consideration will have to be taken by the applicant's engineering consultant to review this tree to see whether it will be viable for retention.

- As all of the trees proposed for removal require a replacement ratio of 2:1, 28 replacement trees will be required on-site. 53 trees are proposed to be planted within the development and exceed the minimum required number of replacement trees.
- In addition, another 4 trees have been identified off-site, to the east and north of the future 138 Street road connection, which may be impacted by the future road works. Another 3 off-site trees, which have not yet been assessed to the immediate north of the gravel lane, may also be affected. It is recommended that these trees be reassessed after Third Reading, with the engineering design to see about the possibility of their retention. Cash-in-lieu and only partial road construction may be considered for the retention of these trees just north of the lane.

### **DISTRICT ENERGY**

- The subject site is located within Service Area B, as defined in the "City Centre District Energy System By-law" (see Appendix VII for location). The District Energy (DE) System consists of three primary components:
  - o Community energy centres, city operated facilities that generate thermal heat energy for distribution through a piped hot water network;
  - Distribution piping that links the community energy centres with buildings connected to the system; and
  - o City-owned Energy Transfer Stations (ETS) located within the building connected to the system. The ETS transfers heat energy from the distribution system to the building's mechanical system, and is used to meter the amount of energy used.
- All new developments within Service Area B with a build-out floor area ratio (FAR) between 1.0 and 2.5 will be required to incorporate hydronic thermal energy systems to allow for future connection to the City's district energy system but will not be required to utilize hydronic systems for space heating within individual residential units. Hydronic systems will be required for all other space heating and hot water heating in the building.
- In order to avoid conflicts between the DE System and other utilities, the location of the ETS and related service connections are confirmed by Engineering and the applicant at the servicing agreement stage. The Engineering Department also requires the applicant to register a statutory right-of-way and Section 219 Restrictive Covenant over the subject site for City access to, and maintenance and operation of, the ETS and to prevent conflicts with other utilities.
- Prior to the issuance of a building permit, the Engineering Department must confirm that the applicant has met the requirements of the "City Centre District Energy System By-law".

# SUSTAINABLE DEVELOPMENT CHECKLIST

The applicant prepared and submitted a sustainable development checklist for the subject site on March 6, 2014. The table below summarizes the applicable development features of the proposal based on the seven (7) criteria listed in the Surrey Sustainable Development Checklist.

Sustainability Criteria	Sustainable Development Features Summary
1. Site Context & Location (A1-A2)	<ul> <li>The subject site is located within the Surrey City Centre.</li> <li>The proposed development complies with the land use designation of the City Centre Land Use Plan.</li> </ul>
2. Density & Diversity (B1-B7)	<ul> <li>The proposed development will include a mix of housing types, including apartment and townhouse units.</li> <li>The proposed development intends to provide a range of unit sizes, from studio, 1-bedroom and 2-bedroom units.</li> <li>The proposed development intends to include a purpose built rental component in Building 1, consisting of 49 dwelling units.</li> </ul>
3. Ecology & Stewardship (C1-C4)	<ul> <li>The proposed development intends to incorporate Low Impact Design Standards (LIDs), including absorbent soil, dry swales and permeable pavement/surfaces.</li> <li>The proposed development will provide provisions for recycling within the underground parkade.</li> </ul>
4. Sustainable Transport & Mobility (D1-D2)	<ul> <li>The proposed development incorporates reduced parking, as permitted within the City Centre area and will provide for secure, allweather bicycle parking.</li> <li>The proposed development has been designed to connect to the larger off-site pedestrian network.</li> </ul>
5. Accessibility & Safety (E1-E3)	<ul> <li>The design of the proposed development incorporates CPTED principles, such as patios on street to provide surveillance. The proposed landscaping will follow CPTED guidelines for sight lines through trees and shrubs with gaps between 0.9 m (3 ft.) and 2.4 m (8 ft.) of tree canopy. All proposed landscaping is designed to provide good sight lines to fenestration to reduce hiding spots.</li> <li>The design of the project does provide for 8 or 7% adaptable units.</li> <li>The proposed development will provide outdoor amenity spaces for different age groups. There are 4 separate amenity space areas, including 2 children's play areas, 2 small seating areas and 2 large community gathering spaces.</li> </ul>
6. Green Certification (F1)	• The project is not seeking third party rated green standards or features.

7. Education &	• The project will include additional sustainability features such as:
Awareness	- Increased insulation in walls and roofs.
(G1-G4)	- Low flow plumbing fixtures.
	- Connection to district energy.
	- Solar shading for south and west facing windows.
	- Reusable, recyclable and renewable building materials.
	- Solar-reflectant roofing materials.

# ADVISORY DESIGN PANEL (Appendix VIII)

Date: January 30, 2014

The applicant has generally resolved the majority of the ADP recommendations, except for the following, which will be resolved prior to Final Adoption:

- Landscape plan revisions.
- Details of project signage.

## INFORMATION ATTACHED TO THIS REPORT

The following information is attached to this Report:

Appendix I. Lot Owners, Action Summary and Project Data Sheets Site Plan, Building Elevations, Landscape Plans and Perspective Appendix II. Appendix III. **Engineering Summary** Appendix IV. **School District Comments** Appendix V. Proposed CD By-law Summary of Tree Survey and Tree Preservation Appendix VI. Appendix VII. Map Showing District Energy Service Area B Appendix VIII. **ADP Comments** 

### **INFORMATION AVAILABLE ON FILE**

• Complete Set of Architectural and Landscape Plans prepared by JM Architecture and M2 Landscape Architecture, respectively, dated March 19, 2014 and March 13, 2014.

original signed by Judith Robertson

Jean Lamontagne General Manager Planning and Development

#### PL/da

# Information for City Clerk

Legal Description and Owners of all lots that form part of the application:

1. (a) Agent: Name: Joseph Minten

JM Architecture Inc.

Address: # 100, 15243 - 91 Avenue, Bldg 4

Surrey, BC V<sub>3</sub>R 8P8

Tel: 604-583-2003

2. Properties involved in the Application

(a) Civic Addresses: 13773 - 101 Avenue

10110 - 137A Street 13793 - 101 Avenue 13783- 101 Avenue 13803 - 101 Avenue

(b) Civic Address: 13773 101 Avenue

Owners: Jagtar K Brar

Baldev S Brar

PID: 010-130-721

Lot 27 Section 26 Block 5 North Range 2 West New Westminster District Plan 20979

(c) Civic Address: 10110-137A Street

Owners: Jagtar K Brar

Baldev S Brar

PID: 010-130-730

Lot 28 Section 26 Block 5 North Range 2 West New Westminster District Plan 20979

(d) Civic Address: 13793- 101 Avenue

Owners: Jagtar K Brar

Baldev S Brar

PID: 010-169-156

Lot 41 Section 26 Block 5 North Range 2 West New Westminster District Plan 21005

(e) Civic Address: 13783-101 Avenue

Owners: Jagtar K Brar

Baldev S Brar

PID: 010-169-172

Lot 42 Section 26 Block 5 North Range 2 West New Westminster District Plan 21005

(f) Civic Address: 13803-101 Avenue

Owners: Jagtar K Brar

Baldev S Brar

PID: 003-335-984

Lot 127 Section 26 Block 5 North Range 2 West New Westminster District Plan 63569

- 3. Summary of Actions for City Clerk's Office
  - (a) File By-law No. 16954.
  - (b) Introduce a By-law to rezone the property.

# **DEVELOPMENT DATA SHEET**

Proposed Zoning: CD (based upon RM-70)

Required Development Data	Minimum Required / Maximum Allowed	Proposed
LOT AREA* (in square metres)		
Gross Total		3,790 m²
Road Widening area		205 m²
Undevelopable area		
Net Total		3,585 m²
LOT COVERAGE (in % of net lot area)		
Buildings & Structures		52%
Paved & Hard Surfaced Areas		21%
Total Site Coverage		73%
SETBACKS ( in metres)		
137A Street	4.5 m	4.5 m
101 Avenue	4.5 m	4.5 m
North (lane)	6.0 m	6.o m
East (new 138 Street)	4.5m	4.5 m
BUILDING HEIGHT (in metres/storeys)		
Principal	22 M	22 M
Accessory		
NUMBER OF RESIDENTIAL UNITS		
Bachelor		14
One Bed		49
One Bed and Den		21
Two Bedroom		6
Townhouses		14
Total		104
FLOOR AREA: Residential		8,898 m <sup>2</sup>
FLOOR AREA: Commercial		n/a
Retail		
Office		
Total		
FLOOR AREA: Industrial		n/a
FLOOR AREA: Institutional		n/a
TOTAL BUILDING FLOOR AREA		8,898 m²

<sup>\*</sup> If the development site consists of more than one lot, lot dimensions pertain to the entire site.

# Development Data Sheet cont'd

Required Development Data	Minimum Required / Maximum Allowed	Proposed
DENSITY		
# of units/ha /# units/acre (gross)		n/a
# of units/ha /# units/acre (net)		n/a
FAR (gross)		2.4
FAR (net)	2.5	2.5
AMENITY SPACE (area in square metres)		
Indoor	312 m²	338 m²
Outdoor	312 m²	466 m²
PARKING (number of stalls)		
Commercial		n/a
Industrial		n/a
Residential Bachelor + 1 Bedroom	87	88
2-Bed	24	24
3-Bed		
Residential Visitors	17	17
Institutional		n/a
Total Number of Parking Spaces	128	129
Number of disabled stalls		5
Number of small cars		46
Tandem Parking Spaces: Number / % of Total Number of Units		n/a
Size of Tandem Parking Spaces width/length		n/a

Heritage Site	NO	Tree Survey/Assessment Provided	YES
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# **ASAS CONDOMINIUMS**

10110 137A Street Surrey, BC

# SUBMISSION TO COUNCIL APPLICATION # 7913-0257-00



Streetscape from 137A Street & 101 Avenue



**Location Map** 

# Drawing List

DRAWING No.	DRAWING TITLE	REV.	ISSUED FOR	ISSUE DATE
4-201	LAND JSE/DENSITY & EXISTING NEIGHBOURHOOD	2.0	ADP REVISION	14 MAR 2014
A-902	LOGATION & FACILITIES	2.0	ADP REVISION	14 MAR 2014
A-203	VEHICLE & PEDESTRIAN NOVEHENT	2.8	ADP REVISION	14 MAR 2014
A-204	DREEN NETWORK 4 AMEN'TY	20	ADP REVISION	14 MAR 2014
A-205	EXLONG, SPACED & CPTED	2.0	ADP REVISION	19 MAR 2014
A-DØ6	VEW CORRIDOR	2,8	ADP REVISION	19 MAR 2014
A-901	DEDICATION GRADING SERVICES	2.0	ADP REVISION	14 MAR 2014
A-00.I	CONTEXT PLAN	28	AADP REVISION	14 MAR 2014
A-00.1	SITE FLAN & RESONGILIATION	20	ADP REVISION	19 MAR 2014
4-003	SHADOK D'AGRAM	20	ADP REVISION	14 MAR 2014
A-00A	SITE SECTIONS	20	ADP REVISION	14 MAR 2014
A-005	SITE SECTIONS	2.0	ADP REVISION	14 MAR 2014
A-00.6	SITE SECTIONS	20	ADP REVISION	14 MAR 2014
A-GLI	LIVEL 2 PARKING PLAN	20	ADP REVISION	14 MAR 2014
A-6L2	ELDG   - MAIN TLOOR/PARKING LEVEL	2.0	ADP REVISION	(4 MAR 2014
E.10-A	BLDG J 2ND FLOOR-BLDG 2 MAINFLOOR	2.0	AADP REVISION	14 MAR 2014
A-\$1.4	ELDS 1 SRD FLOOR- BLDS 2 IND FLOOR	2.0	ADP REVISION	14 MAR 2014
A-01.5	BLDG I 4TH5TH FLOOR- SLD6 2 SRD/4TH FLOOR	20	ADP REVISION	19 MAR 2014
A-01.6	BLDG 1 6TH FLCOR/ROOF- BLDG 2 5TH 6TH FLOOR	2.0	ADP REVISION	19 MAR 2014
A-021	TOWN-CUSE UNIT PLANS	20	ADP REVISION	14 MAR 2014
		-	-	10000000000

Ł.	DRAWING No.	DRAWING TITLE	REV.	ISSUED FOR	ISSUE DATE
ľ	A-1022	INIT PLANS	20	ADP REVISION	H MAR 2014
	A1023	INIT FLANS	25	ACP REVISION	H MAR 2014
	A (Ø3)	sTREETSCAPES	20	ADP REVISION	H MAR 2014
1					
-	A-103.2	ILEVATIONS	29	ACP REVISION	# MAR 2014
	A-1053	ILEVATIONS	20	ADP REVISION	H MAR 2014
	A-108.4	MORS/EST VES	20	APP REVISION	H MAR 204
	A-(ØS3)	PERSPECTIVES	29	ADD REVISION	JF MAR 2014
	A-105 a	PERSPECTIVES	22	ADP REVISION	H MAR 20/4
1	A-105.1	PERSPECTIVES	20	ADP REVISION	II MAR 2014
	A1033	PERSPECTIVES	20	ADP REVISION	H MAR 2014
	LANDSCAPE AF	CHITECTURE			
1	LI	REEPLAN	20	ADP REVISION	If MAR 2014
	12	SHUB PLAN BULDING I	20	ADP REVISION	If MAR 20/4
	L5	SHOR PLAN BLICTHS C	23	ADF REVISION	H MAR 2014
	L#3	SECTION	2.0	ADF REVISION	11 MAR 2014
	12	ELEVATION	20	ADP REVISION	IF MAR 2014
	1.6	DETALS	25	ADP REVISION	IF MAR 2014
١	6	SPECIFICATION .	20	ADF REVISION	H MAR 2014

Directory:				
OWNER	Int. Buldes hare (Sep 3 joch Strott. Sarra, B.C. VSM 484 1. Go. 470 485 1. Bult ov. Inter@notmal.com			
ARCHITECT	M. APCHITICTURE INC			
	main fixed: Hudding &  3-345; yiels whemse  5-stres, E.C. VysaRes  1: 66.45; 30.60;			
LANDSCAPE ARCHITECT	PS_LANDSLAPS_ARC-LTCC_URE 120.00 Learn Moving			
CIVIL ENGINEER	COASTLAND ENGINEERING & SURVEYING LTD. HOUSEDS TO ARCHUL, TATTER, ELC. VISS SAM: E. 664, 533, 509, 500 E. 664, 533, 509, 500 E. 664, 533, 509, 500 E. 664, 533, 500, 500 E. 664, 533, 500 E. 664, 500			



**-06 ASAS CON** 

#### **EXISTING ROAD CONDITION**



BUS STOPS AND 400M RADIUS







CITY RAPID TRANSIT



CITY CENTER ROAD NETWORK



PROPOSED VEHICLE AND PEDESTRIAN MOVEMENT



PROPOSED ROAD INTERSECTION



PROPOSED & EXISTING SIDEWALK	
FUTURE SIDEWALK	************

PROPOSED ROAD CURB

**EXISTING ROAD CURB** 


**FUTURE ROAD CURB** 

# **ASAS** Condominiums

10110 - 137A Street, Surrey, British Columbia



Mr. Baldev Bran March 19, 2014

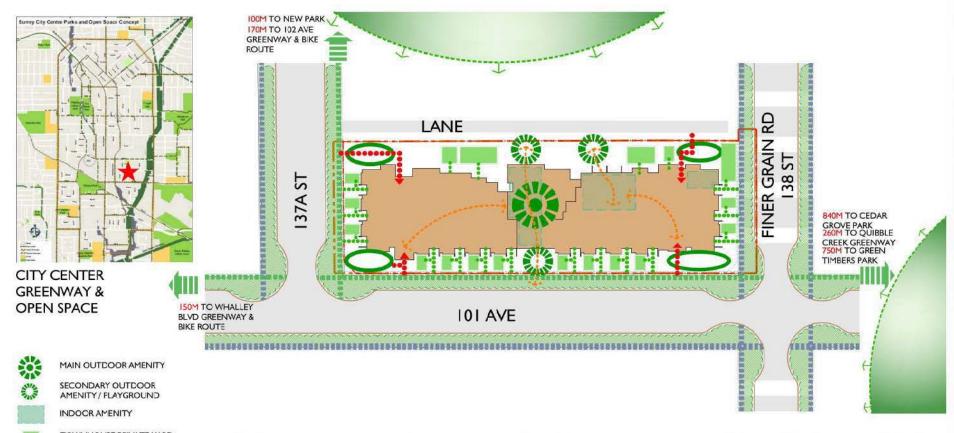



STREET GREEN BUFFER & ISLAND
PARKS NEAR BY



ROOF GARDEN OUTDOOR AMENITY (2.800 S.F.)



CORNER PLAZA @ MAIN ENTRY



CORNER PLAZA

@SECONDARY ENTRY



PLAYGROUND



PRIVATE YARD


# **ASAS** Condominiums

JM Architecture Inc.


10110 - 137A Street, Surrey, British Columbia

Mr. Baldev Brar March 19, 2014

4-004

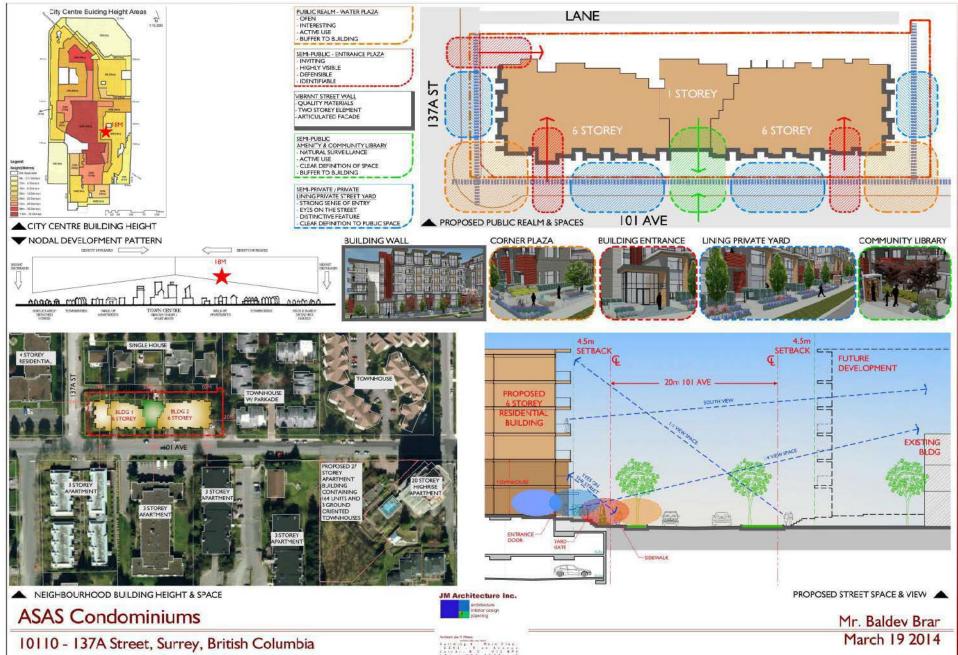

A-005

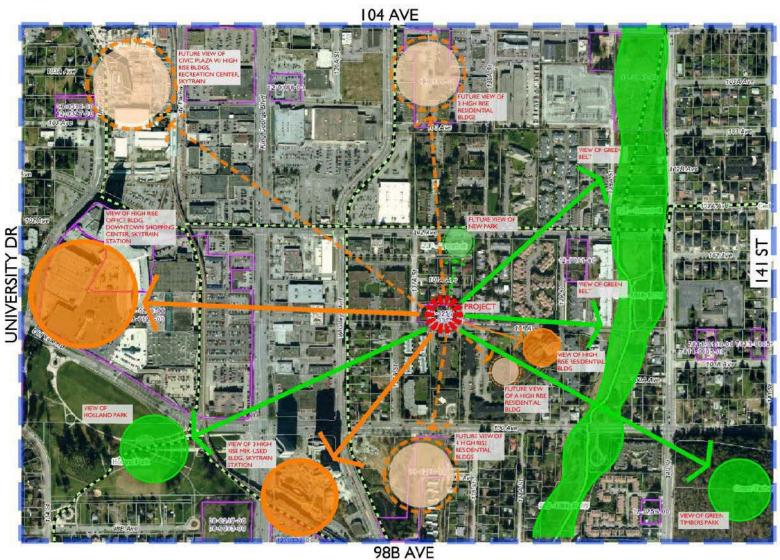









# **ASAS** Condominiums

10110 - 137A Street, Surrey, British Columbia



Mr. Baldev Brar March 19, 2014





10110 - 137A Street, Surrey, British Columbia





Mr. Baldev Brar March 19, 2014



	Durrey Dy-Caric Respirations.	Programed or Provided
Name	ASAS Condominates	
Natu	10.110 137a St. (3773.13783, 13793 and	
Own Address	13833 101 Aus	
CITO POLITICA	Surrey B C	
	Lots 27, 25, 41, 42 & 127, Sec 25, Block 5.	1
Logis Desosption	North Range 2 West, NAVO	
Gross Lot Alea	3.790.2 m <sup>2</sup> > 40.797 8 st	Original
Not Lot Avec	3 585 0 m <sup>2</sup> - 38 588 3 of	Mixeg dedications
	(Crity 88 63 m <sup>2</sup> road dedication	metaded in FAR for 3/701.4 mFNETI
Duliding Amer	Building 1	1
	Building Ares	4.409.4 m <sup>2</sup> - 47.402.5 st
	mosor Amerity Space	172.2 m2 - 1.854.0 of (147 m2 required)
	Net Floor Area for FAR convolution	4.362.45 m <sup>-1</sup> .45.870.7 st
	Building 2	Annual Control of the
	Duilding Area	4,000 0 m 51,676 0 m
	Indoor Amerity Spece	106.2 m² - 1,789.0 st (105 m² required)
	Net Floor Assettr FAR operation	4.635.9 re* - 49.600.0 st
	DESCRIPTION CONTRACTOR	Times of Taxable III
	Total foor orne to this permit spekcation	0.210.2 m <sup>2</sup> - 99 128.0 m <sup>3</sup>
	Total floor included in EAR calculation	0.004.05 m <sup>2</sup> - 95.779.7 st
	position of the second	POTENTIAL STATE OF THE STATE OF
Zoning Data	1	-
Carrent Zone	RE	00
Permitted Uses	Single Ferrity Overling, 1 Secondary suits	Multiple Unit Residential, Ground Crientes
Section Control		Multiple Unit Residential
Lat Area	Not Applicable	3,701.8 (6" - 28.588.3.91
Density - FAR	0.52	Total Floor Amartist Area
1007050110	100	8,898.35 m <sup>2</sup> / 3,301.6 m <sup>2</sup> = 1.41
28 Coleniege	47%	Max Fixer Areatof Area
1000000	A Chicago Company	1,921.8 re* / 3,701.6 rr = 51.9%
Selbackii.	7.5m from from near	Side/South: 4.5m - 14.70%
	1 8m from side yard	BackEast 4.5m - 14.76ft
	2.0m from side rand on flanking shoot.	Enter North: 5 Orn - 19 585
legate of Suidwan	Ser. 30 F	Front/West: 4 Em - 14.768. 21.78m - 71.498
Off Street Famou	Total result sarking statu: 128	112 resident parking stalls
DE COMO PARTY	Total provided accessible parking stalls: 4	17 visitor parking stalls
	Compress account partigines. 1	Total 129 parking state provided
		including
		63 regular parking shalls.
	A La sagrange and a s	45 small parking state
	Sicycle PatringProvided	144 secured covered
	Dickow Laurid Luckner	12 valter

Parking - Zoning	1.3 per <= 1 BR		1.5 per >= 2 BR		Visitor	Total	-20% City Centre	
Building #1	9.1	31.2	6.5	9.0	10.5	9.8	75	61
Building #2	9.1	22.6	20.8	0.0	10.5	11.0	34	67
Total			ar-	7	24	17		125
Parking - Provided								129
Bicycle Parking		121	or dwelling	soft		Vietor	Total	
Building #1		29	6	1	8.	- 6	65	
Building #2		30	19		В	6	72	
Total							137	
Add, from Planning							12	
Total							150	
Outdoor Amenity					Pro	vided		Required
	Location		Area (SF)		Area (m²)		Area (m²)	
Building #1		ide of Indoor		493.4		45.8		
	South Outside of Indoor Arrenty			311.3		28.9		147.0
Building N2	North Outs	ids of Indoo	Amonty	1101.9		109.5		105.0
Rooftop (2nd Floor)				3231.9		201.7		13213
TOTAL	(theleforge above Booking Accounty)			5110.6		A96.3		712.0

		STUDIO	1 BED	1770	-	THS	TOTAL
		(ST)	(A)	(B)	(C)	(TH)	-
BUILDING #1	18TFL ZNOPL	1	0	9	1		-
	SHEFT.	- 15	- 20				1.0
	1130730		7	1	1	0	10
	4THFL	4	7	- 1	1	0	10
	5THEL	- 7	7	1	- 1	0	10
	STUFFL	- 2	3	1.1	1	0	7
	SUBTOTAL	7	24	. 5	- 6	7	49
	18TFL	1	1	1	.0	4	7
	ZNEFL	- 1	D	- 3	D	3	7
0	SREEL	- 31		- 3	D	0	
BUILDING R	4THFL.	- 1	7	3	0	0	11
	STHEL	1	7	3	0	0	11
0	STHPL	2	6	3	D	0	(11)
	SUBTOTAL	7	25	16	D	7	55
4	TOTAL	- 54	49	21	- 0	16	1114
ALL	100,100,	13%	A7%	20%	6%	13%	100%
PER FLOOR	18771	- 120	1	1.1	36	- 11	10
	INDFL	2	0	4	+	0	10
	SRDFL	- 2	11	- 4	1	0	16
	4THUL.	2	14	4	1	0	21
	571-SE	2	14	4	- 1	0	21
	STHEL		9.	4	1	0	18

	UNIT AREA	6,793	638.2	4,562	423.9	10.366	962.0	55%	ď.
	RENTAL OFFICE	291	26.0	0	0.0	280	26.0	194	
	CIRCLEATION	1,948	181.0	1,067	184.6	3,035	365.0	21%	
	INDOOR AMENTY	1,854	172.2	1,789	109.2	3,643	338.4	19%	ē.
	STORAGE	. 0	0.0	581	54.0	581	54.0	39	45
ZND FL.	1000000	8,258	T67.2	8.713	809.5	16,771	1,576.1	100%	
	UNIT AREA	6,945	6612	7,485	695.6	14,100	1,340.6	85%	ŝ.
	CIRCULATION	1.313	122.0	1,229	114.1	2.541	236.1	15%	
NO FL.		7,882	T32.3	8,678	805.2	16,960	1,538.5	100%	
	UNIT AFEA	6,706	623.0	7.450	692.1	14,155	1,015.1	65%	
	CIRCULATION	1,178	109.3	1,228	114.1	2,404	229.9	15%	ë.
4TH FL	reservative	7.882	732.9	8,576	796.7	16,458	1.529.0	100%	
	UNITAREA	6,706	623.0	7,348	682.7	14.294	1.305.T	55%	ë.
	CIRCLEATION	1,176	109.0	1,220	154.1	2,404	223.3	15%	ē
STHFL		7,828	727.2	8.522	791.7	16.350	1.519,0	100%	
	UNITAREA	6.652	618.0	7.294	677.6	13,46	1.295.6	55%	
	CIRCULATION	1,176	109.3	1,228	194.1	2,454	223.3	13%	6
BTH FL		5,737	533.0	8.266	768.1	14,300	1.301.1	100%	ē
	UNTAREA	4,576	426.1	7.175	657.3	11,861	1,082.4	83%	
	CIRCULATION	1,161	107.9	1,193	110.8	2,254	218.7	17%	8
TOTAL		47,462	6,409,4	51,476	4,800.0	99,138	9.210.2	100%	
	UNITAREA	37,378	3,472.5	41,214	3,828.9	18,502	7,301.4	79%	
	CIRCULATION	T.050	T38.6	0,002	751.8	10,342	1,400.4	15%	
	INDOOR AMENTY	1,654	172.2	1,789	105.2	3,743	330.4	414	di:
	STORAGE	. 0	0.0	561	54.0	641	54.0	39	di.
GROSS LOT AREA				40,756	3,790.2				т
ROAD DEDICATION				2.200	205.3				П
NET LOT AREA for FAR Calls				36,843	3.701.6				т
LOT COV	ERAGE		3.			52%			
FAR				2.39					
PARKING	SELLABLE AREA (S.)		- 17			13,44	0		
REGULAR PARKING STALLS				83		288		22,078	5.5
	SMALLPARKE	KI STALLS		46		267		11,362	8.5
TOTAL PARKING STALLS				129				33,440	5.5

FLOOR AREA BREAK DOWN


**ASAS Condominiums** 


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10110 - 137A Street, Surrey, British Columbia

Mr. Baldev Brar March 19, 2014

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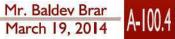


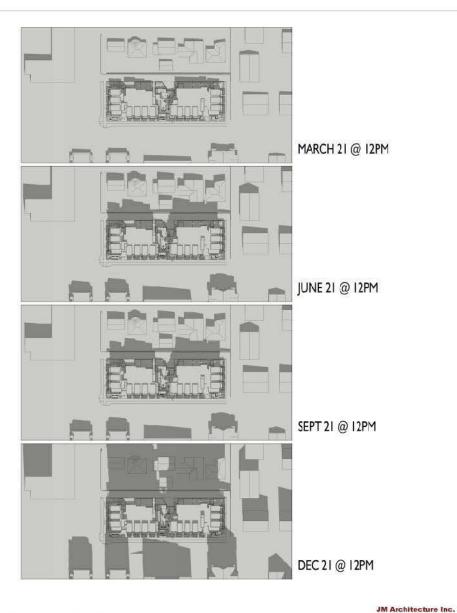



**ASAS** Condominiums
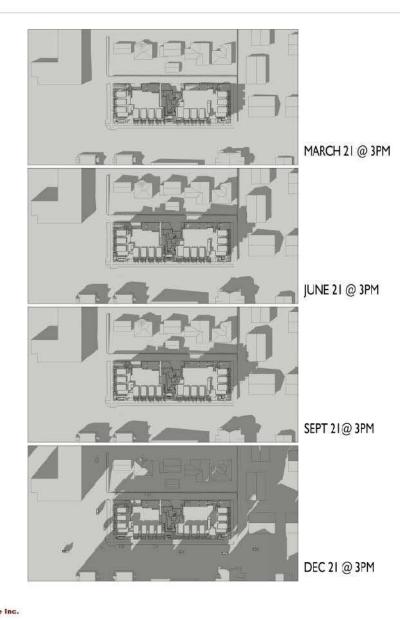
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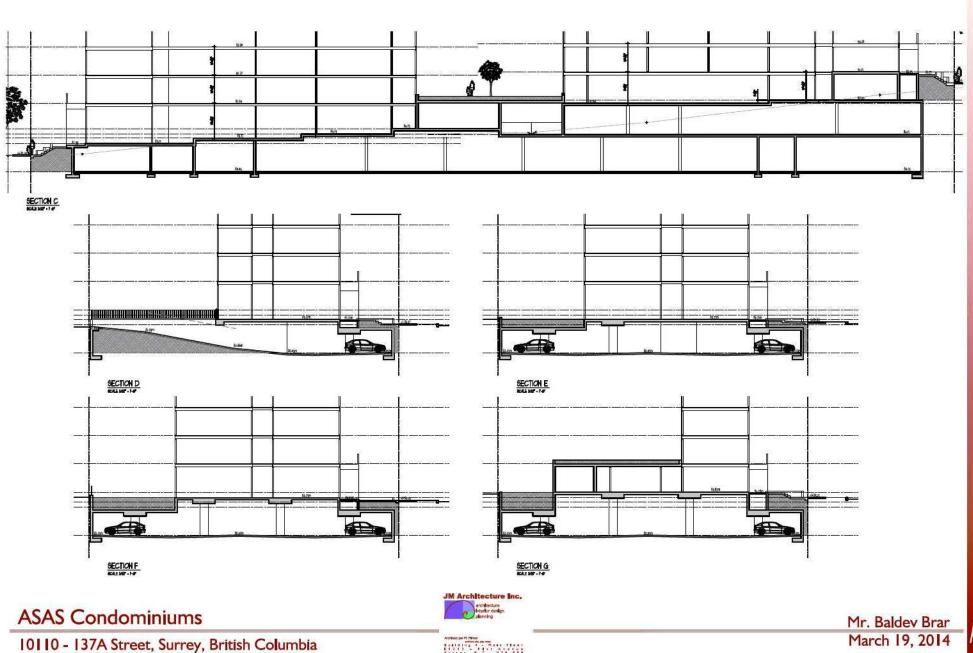
**ASAS Condominiums** 

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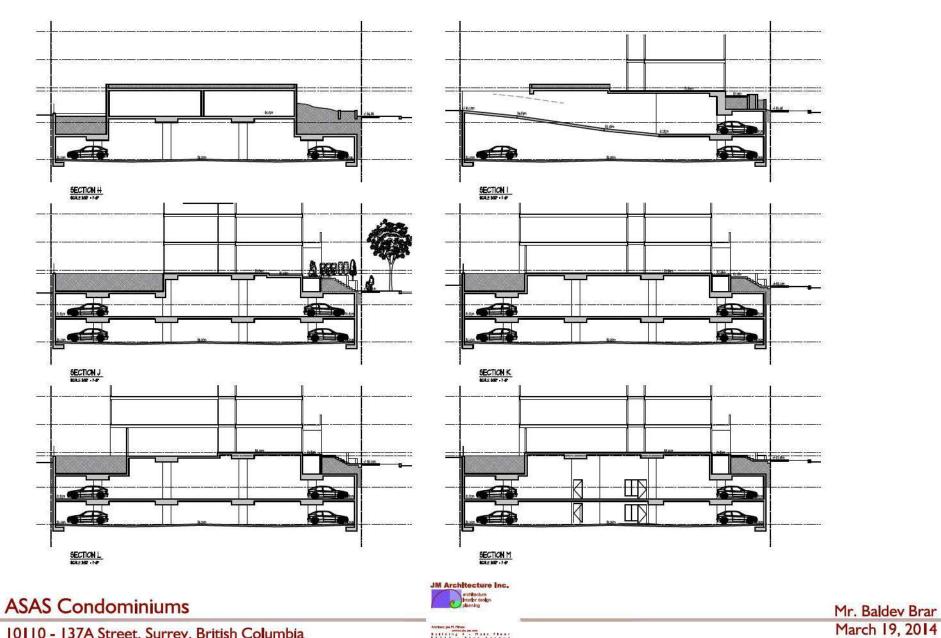




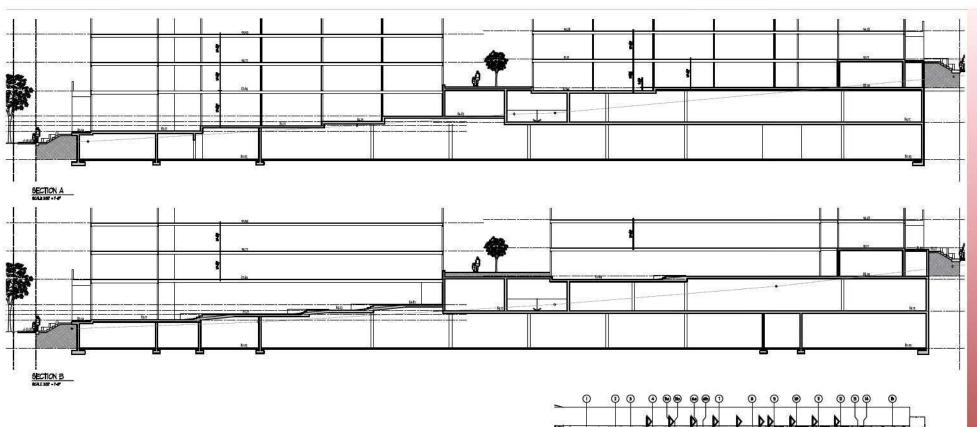


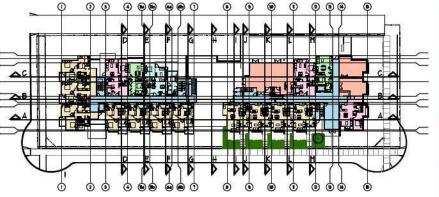







10110 - 137A Street, Surrey, British Columbia

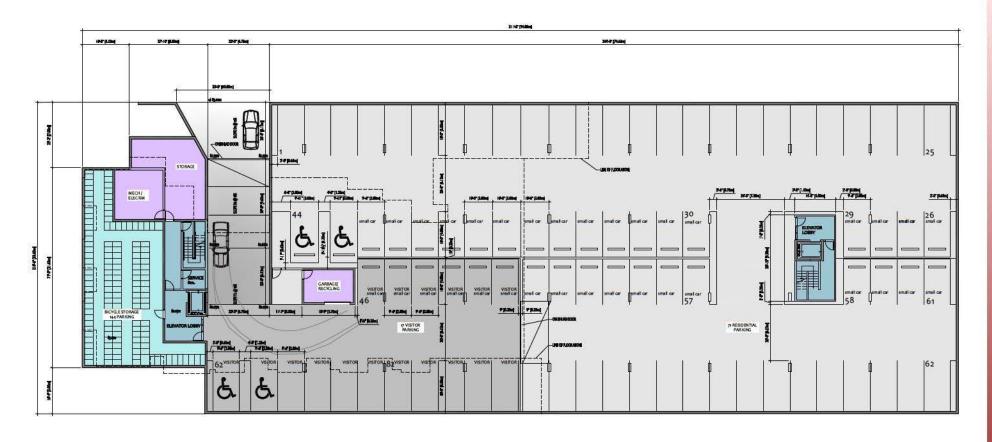





**ASAS Condominiums** 

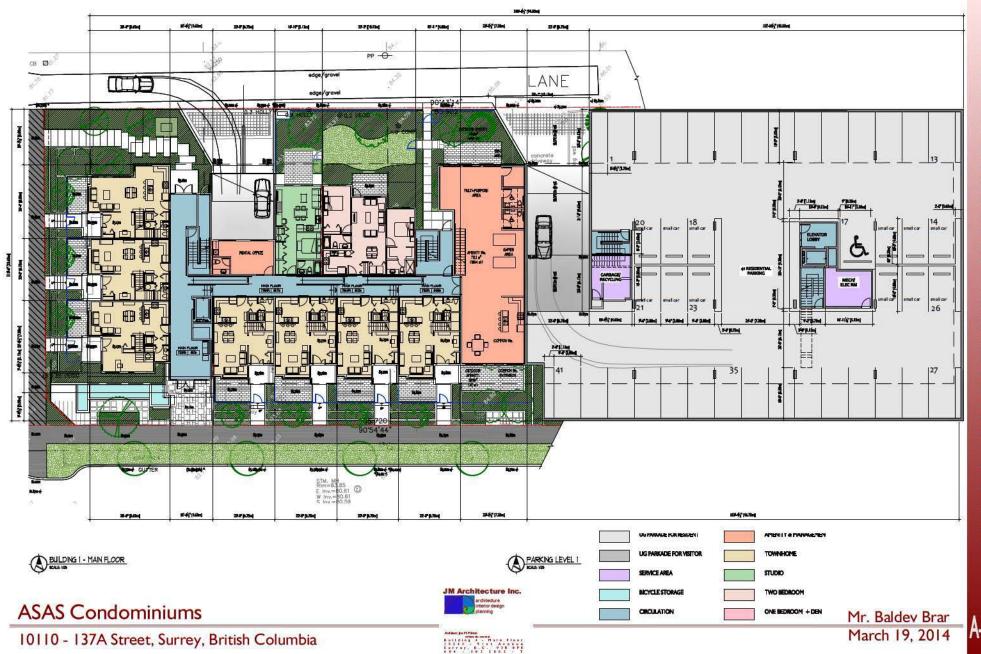

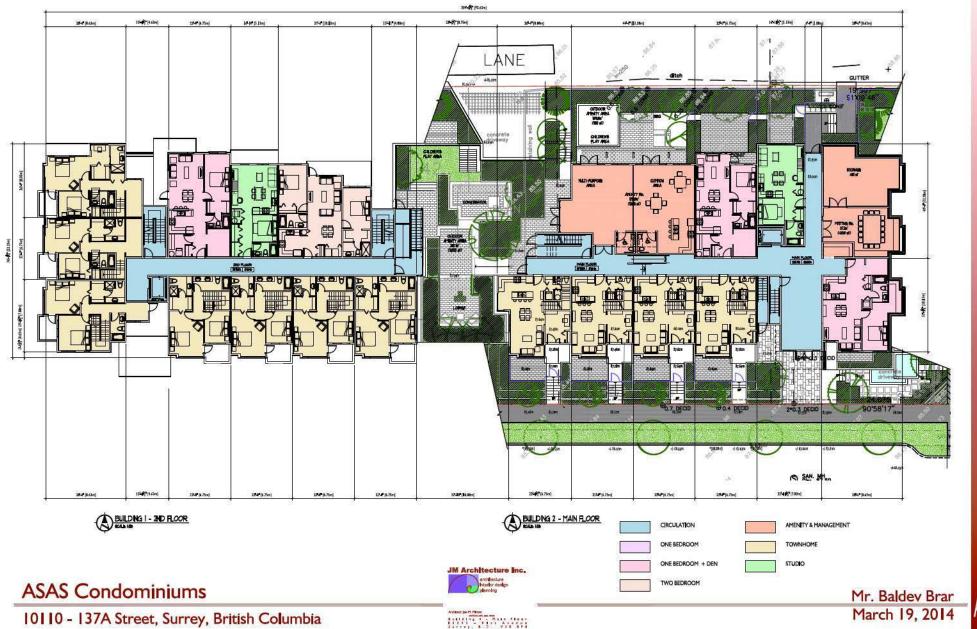

A-101.3

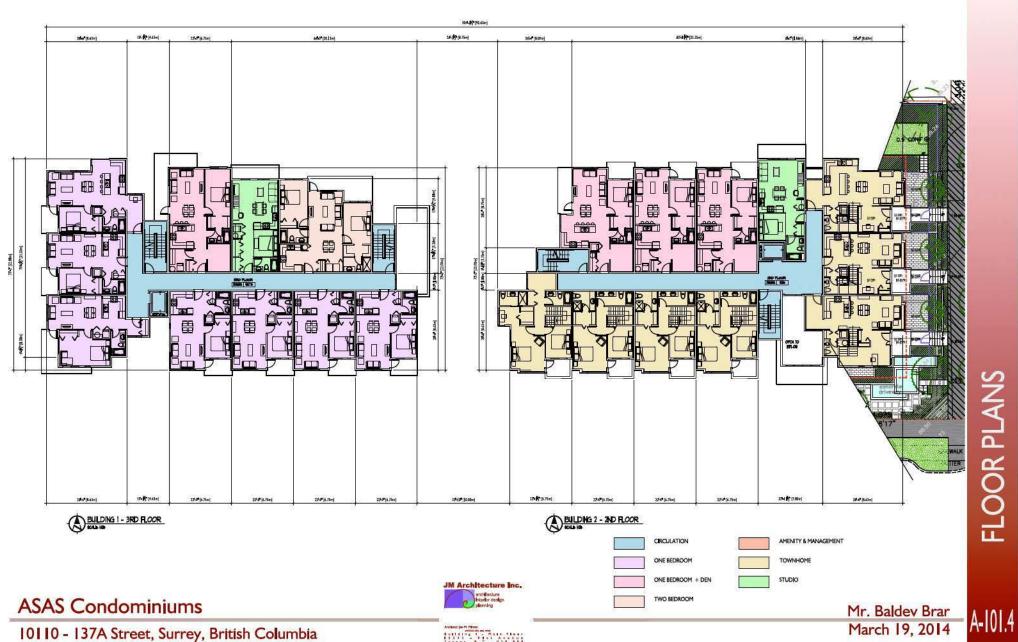

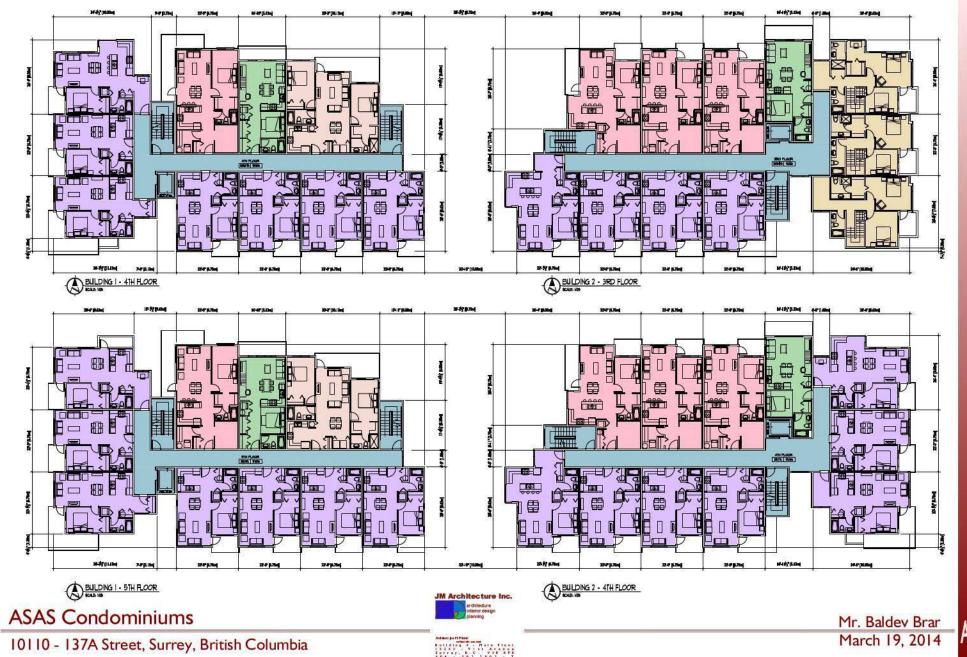









# **ASAS Condominiums**

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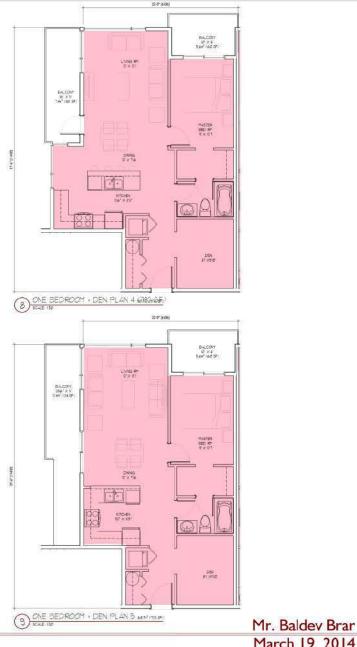
Mr. Baldev Bran March 19, 2014



A-102.1A







10110 - 137A Street, Surrey, British Columbia

March 19, 2014









SOUTH STREETSCAPE ALONG WI AVENUE



WEST STREETSCAFE ALONG 1314 STREET

10110 - 137A Street, Surrey, British Columbia



Mr. Baldev Brar March 19, 2014



A-103.2













WEST ELEVATION - BLDG I

	MATERIAL	FINESH	COLOUR	SUPPLIER		MATERIAL	FINDSH	COLOR	SUPPLEN
1	HADE WEL 4	9407	PURPER IN	OR BOUNDED	9	MOON	annews.	SWE BOOK	
2	HANDE PAREL 40	9-0011	SP CL SECH	OR DELIVERATE		MOON	HEDDEL HALL	DANK BROKE	ON THE CLIMBS
	HADE WILL 4	94000	STORY LOW	OR DELIVERATE	•	HOOD	GEOM OWNE.	STIRL CEDIER	
	HARDE PAREL OF	9400Th	ACHT LINE	OR DELIVERATE	9	HARDINY	WE TOPES	<b>OWNER</b>	STEEN LINE
•	HETAL SERIO	CL TOLO	OC MANS TAR PRO	MANAGE THE	9	WARNEY	BULKSHD	GAMERA	OR WEST DATE
•	TLANGE E		GE MATE CAMPOON.	STEEL STEEL STEEL	SH	TOKE I GAVERAL	PHOTO	SMK PORE	
	TANKE !		OC MANS THE PERSON	Manager .	•	A WETAL YORKE	rverap	MATERIAL CHARGON.	N.
•	HODDH	PAG .	encia.	OR BUT ALBOT	•	SAACE SIX	ANDERS	WHATEL	

ACAC	_		
ASAS	Cond	omir	nums

10110 - 137A Street, Surrey, British Columbia



JM Architecture Inc.

Mr. Baldev Brar March 19, 2014





BUILDING I - SOUTHWEST CORNER @ 1378 STREET 4 101 AVENUE

BUILDING I - SOUTHEAST CORNER



BUILDING I -NORTHEAST CORNER

BUILDING I - NORTHUEST CORNER # 37a STREET

JM Architecture Inc.

10110 - 137A Street, Surrey, British Columbia

Mr. Baldev Brar March 19, 2014

**1-103.4** 





BUILDING 2 - SOUTHWEST CORNER 4 101 AVENUE

BUILDING 2 - SOUTHEAST CORNER





BUILDING 2 - NORTHEAST CORNER

BUILDING 2 - NORTHWEST CORNER

JM Architecture Inc.
architecture interior cestor
planning:

10110 - 137A Street, Surrey, British Columbia



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BIRD'S EYE VIEW FROM NORTHWEST

BIRD'S EYE VEW FROM SOUTHWEST





BIRD'S EYE VIEU FROM SOUT-LEAST

BIRD'S EYE VEW FROM NORTHEAST

JM Architecture Inc.

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A-103.6







BUILDING 2 MAIN ENTRY

BUILDING I SECONDARY ENTRY







MID-BLOCK PLAZA WITH COMMUNITY LIBRARY



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ROCFTOP AMENITY SPACE BUILDING 2 AMENITY SPACE











BUILDING I SOUTH AMENITY SPACE

BUILDING I NORTH AMENITY SPACE

PRIVATE YARDS

PRIVATE YARDS

PRIVATE YARDS








TOUNHOUSES PATIOS

TOUNHOUSES ENTRY

Archive post Histor

Sull class 4 - Histor Floor
13743 - 5141 Avanua
50749, S.C. 757 S.E.

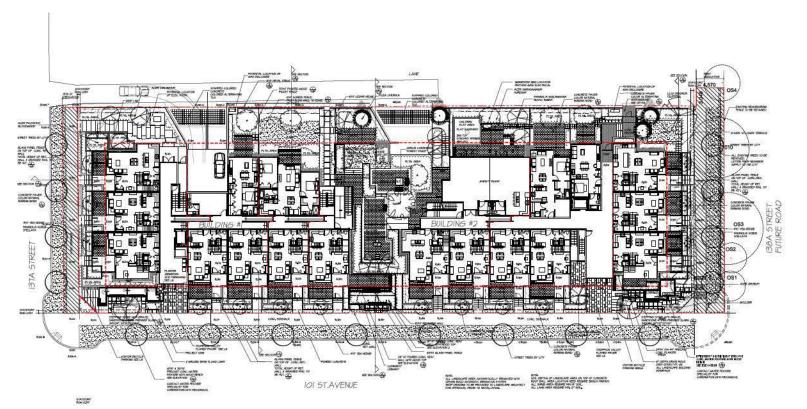

OTY	SCHEDULE BOTANICAL NAME	COMMON NAME	PLANTED SIZE / REMARKS
UIT	MOTANICAL NAME	COMMON NAME	PLANTED DIZE / NEMANNO
_ 1/2	ACER CIRCHARM	VINE HARLE	ISH HI/ BIB 3 SIEH CLUMP
VA.	ACER ORDER	PAPERBARK HARLE	6CH CAL-LEH STD-BIB
Y:	ACRE PALHATIN MLOODSOOD!	Jarobist Hart	Shell Hr. mars devicate house
. 1.	ACER SHEASANARM 'AURUM'	PUL NOOR HAPLE	SCH CAL: 2M STD-BAD
1	CIRCIS CANADISIS TORIST PARET	FOREST PART RIDBE	4CH CAL: B4B
12	LIBOUENCHON THUPFERA	THE THE	6CH CALCOM STDVBIB
111	HASHOUA KOBIS STELLATA	STAR MACNOLIA	2H HIVEAB
D) .	HASHOLIA SOLLANDIANA RUSTICA RUBRA!	RED HASHOUA	SH BI-BIB Specify SID Or Shrub Form
0	PICEA CHICRICA	SERBIAN SPRICE	25H HF B4D
23.	HASHOUA SOULANGIANA RUSTIGA RUBRA!	RED HASHOUA	SH HI-BAD Specify STD Or Shrub Form
CV.	FIXEA CHURKA	SERBAL SPRICE	25H HE DIB
* PLAN	TSIZES IN THE LIST ARE SPECIFIED ACCORDING 25, BOTH PLANT SIZE AND CONTAINER SIZE ARE AND ONLINE PLANT HATSIAL RESIDENTITY.	TO THE BC LANDSCAPE STANDARD, LATEST BE THE HERMAN ASSISTANCE SIZES, * HER TO	OMON, CONTAINER SIZES SPECIFIED AS PER SPECIFICATIONS FOR DEFINED CONTAINER
dollars.	AND OTHER PLANT HATERIAL RESURBERENCE. * 5	EARCH AND REVIEW HAKE PLANT HATERIA.	AVAILABLE FOR OPTIONAL REVIEW BY
	CHITECT AT SOURCE OF SUPPLY. AREA OF SEAR.  H. THE LANDSCAPE ARCHITECT PRIOR TO HARDIN		
	M THE LANDSCAPE ANGHIEGT PRIOR TO HARDES ON A HINHUH OF FIVE DAYS PRIOR TO DELIVER		
	THE DATE HAVE TO DELIVER		SAME SUBJECT TO BE LANDSCAFE.

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MA	DATE	REVISION DESCRIPTION	DR
7	A OCT D	ISSUED FOR ARCHITECT	Mr
-2	di NOV. Y	ISSUED FOR ARCHITECT	M
-3	2,080,19	ISSUED FOR ARCHITECT	- 500
-4	4,066, 19	ISSUED FOR ARCHITECT	MY
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-1	22 JAK 1	155/ED FOR ADP	Mr
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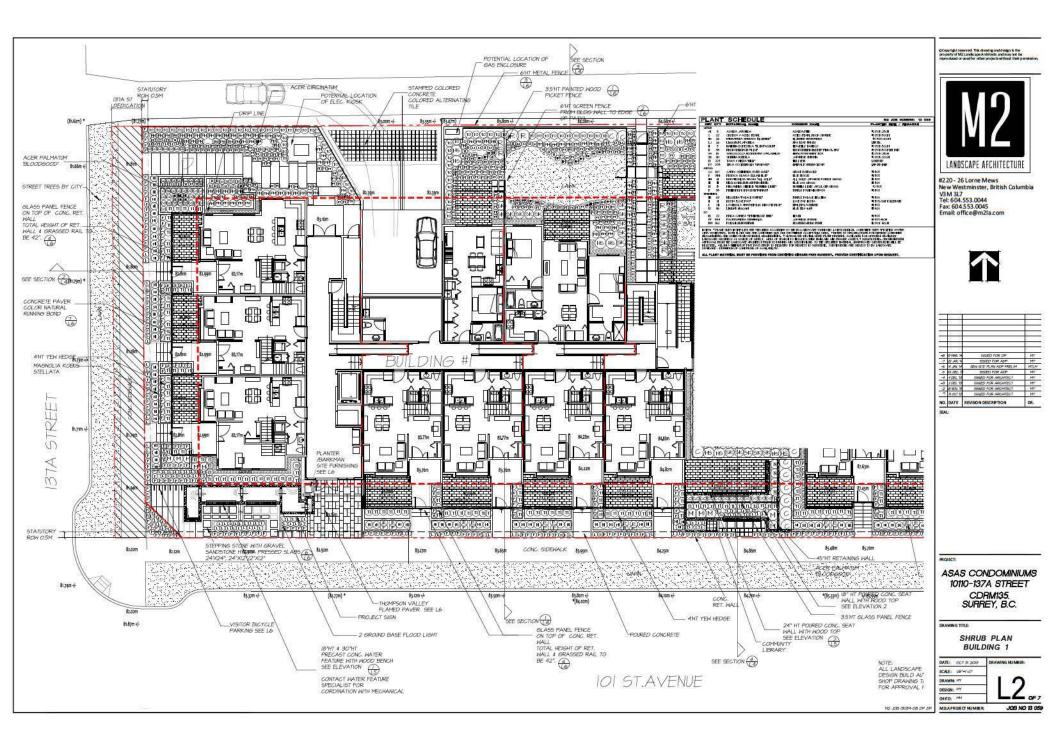
PROJEC


ASAS CONDOMINIUMS 10110-137A STREET CDRM135. SURREY, B.C.

DRAWING TITLE

TREE PLAN

DATE OCT STOOM	DRAWING NUMBER:
SCALE (46"-1"-0"	100V 2150I
DRAWN: HY	111
DESIGN: MY	
CHED: NO	L OF 7
MOLE DOUGHT NUMBER	JOR NO 19 05



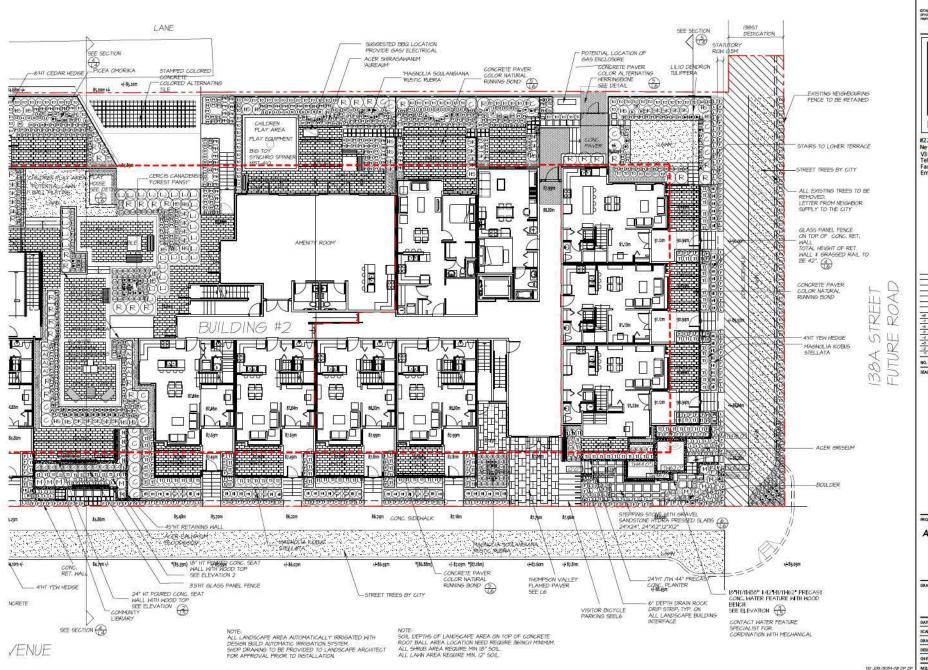



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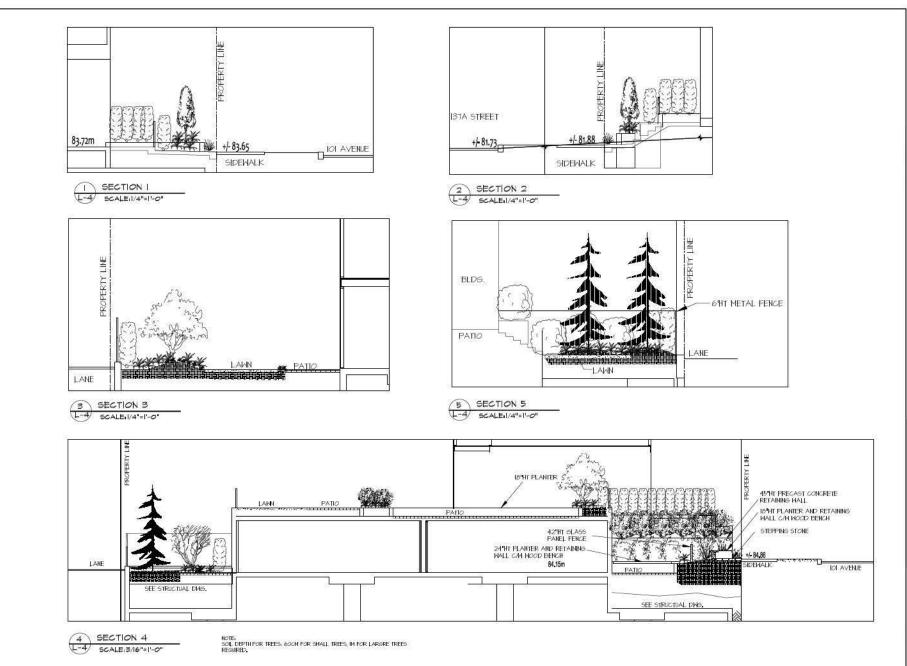
PROJECT:

ASAS CONDOMINIUMS 10110-137A STREET CDRM135. SURREY, B.C.

DRAWING TITLE

SHRUB PLAN BUILDING 2

DATE: OCT 3/ 2013 DRAWING NUMBER: SCAE: U6'-1'-0" DRAWN HY DESIGN: HY OHED: HY M2LAPROJECT NUMBER JOB NO 13 059



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S MAR W SZ JAN 19 H JAN 19 HS JEC 19 4 JEC 19 S NOV. 19 S GCT 19	ISSAED FOR DP  150/ED FOR ACP  MEN SITE PLAN ACP FRIELM  BOULD FOR ACP  ISSAED FOR ARCHITECT  ISSAED FOR ARCHITECT	ML ML ML ML ML
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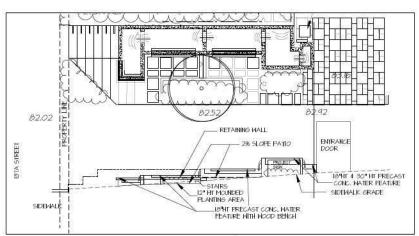
PROJECT:

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DRAWING TITLE


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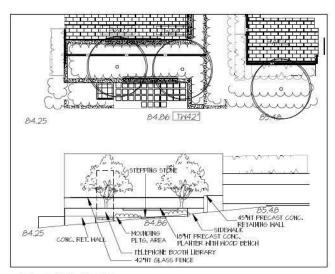
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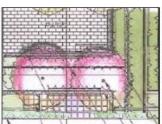
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SOUTH CENTRE





SOUTH EAST L-5 SCALE:3/16"=1'-0" ©Copyright reserved. This drawing and design is the property of M2 Landscape Architects and may not be

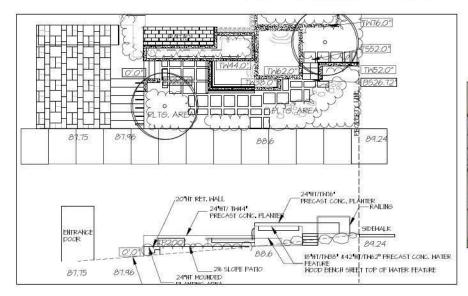

#220 - 26 Lorne Mews New Westminster, British Columbia V3 M 3L7 Tel: 604.553.0044 Fax: 604.553.0045 Email: office@m2la.com



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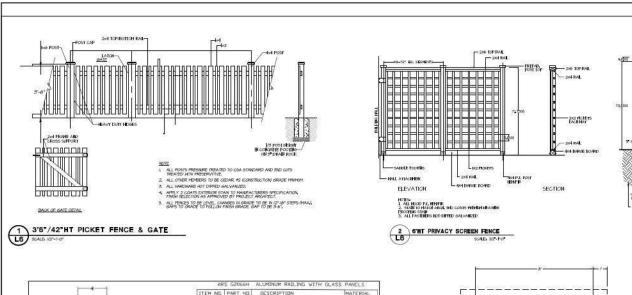
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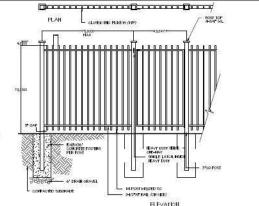
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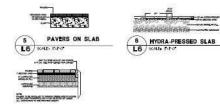








SIDE ELEVATION



LANDSCAPE ARCHITECTURE

#220 - 26 Lorne Mews New Westminster, British Columbia V3M 3L7 Tel: 604.553.0044 Fax: 604.553.0045 Email: office@m2la.com

#220 - 26 Lorne Mews

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# INTER-OFFICE MEMO

TO:

Manager, Area Planning & Development

- North Surrey Division

**Planning and Development Department** 

FROM:

**Development Services Manager, Engineering Department** 

DATE:

March 21, 2014

PROJECT FILE:

7813-0257-00

RE:

Engineering Requirements Location: 10110 137A St

## REZONE/SUBDIVISION

## Property and Right-of-Way Requirements

- dedicate 2.322 metres along 137A St. for an ultimate 20-metre road allowance;
- dedicate 3.00m x 3.00m corner cut at the intersection of 137A St. and 101 Ave.;
- dedicate 5.00 metres for future 138 St.;
- provide 0.50-metre statutory right-of-way along 101 Ave, 138 St and 137A St.; and
- dedicate 3.00m x 3.00m corner cut at the intersection of 101 Ave. and future 138 St.

## Works and Services (to City Centre Standards)

- construct east side of 137A St. (5.5 m pavement to centre line, 2.5m blvd, 2m swlk);
- construct north side of 101 Ave. (5.5 m pavement to centre line, 2.5m blvd, 2m swlk);
- · construct lane within existing road allowance;
- construct west side of future 138 St. (swlk, curb, blvd);
- remove existing 250mm abandoned storm main along 101 Ave.;
- provide road drainage facilities for 137A St. and 101 Ave.;
- provide cash-in-lieu for future drainage facilities along future 138 St.;
- extend a 250mm watermain on 137A St.;
- remove existing 200mm sanitary main located within the statutory right-of-way on subject site. Statutory right-of-way is to be discharged;
- · construct new sanitary main diversion to redirect flows west along 101 Ave.; and
- meet District Energy Requirements as per City Centre Plan for Service Area B.

A Servicing Agreement is required prior to Rezone/Subdivision.

#### DEVELOPMENT PERMIT

There are no engineering requirements relative to issuance of the Development Permit.

Romita

Rémi Dubé, P.Eng. Development Services Manager

MS



Tuesday, January 28, 2014 Planning

#### THE IMPACT ON SCHOOLS

APPLICATION #:

7913-0257-00

#### SUMMARY

The proposed 104 lowrise units are estimated to have the following impact on the following schools:

#### Projected # of students for this development:

Elementary Students:	5
Secondary Students:	3

#### September 2013 Enrolment/School Capacity

Lena Snaw Elementary	
Enrolment (K/1-7):	70 K + 451
Capacity (K/1-7):	60 K + 550
Guildford Park Secondary	

Enrolment (8-12): 1260
Nominal Capacity (8-12): 1050
Functional Capacity\*(8-12); 1134


#### School Enrolment Projections and Planning Update:

The following tables illustrate the enrolment projections (with current/approved ministry capacity) for the elementary and secondary schools serving the proposed development.


There are no capital projects proposed for Lena Shaw Elementary or to Guildford Park Secondary. Enrolment move considerations are being reviewed in the North region of the district to help reduce overcrowding at some schools while reducing surplus space at other schools. Capacity at Lena Shaw Elementary has been adjusted for full day Kindergarten implementation and a "Strongstart" program oriented to preschool children and their parents. The proposed application in this report will not have an impact on these projections.

Although there is current space surplus at Lena Shaw Elementary, the schools catchment is in an area with a densification with numerous applications in process for higher residential densities (including low rise and high rise apartments) and other residential infill development, which are projected in the graph below to result in enrolment growth at Lena Shaw Elementary. The timing of enrolment growth is dependent upon the rate of migration of new residents to the catchment, which may be impacted by housing market factors.

#### Lena Shaw Elementary

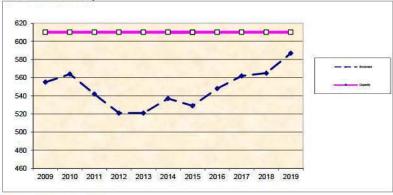

#### **Guildford Park Secondary**

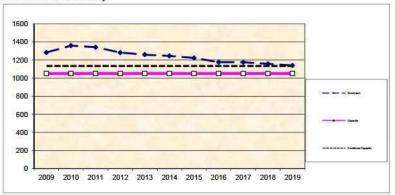

\*Functional Capacity at secondary schools is based on space utilization estimate of 27 students per instructional space. The number of instructional spaces is estimated by dividing nominal facility capacity (Ministry capacity) by 25.

#### CITY OF SURREY

BYLAW NO.	
-----------	--

A by-law to amend "Surrey Zoning By-law, 1993, No. 12000", as amended

## THE CITY COUNCIL of the City of Surrey ENACTS AS FOLLOWS:

1. "Surrey Zoning By-law, 1993, No. 12000", as amended, is hereby further amended, pursuant to the provisions of Section 903 of the <u>Local Government Act</u>, R.S.B.C. 1996 c. 323, as amended by changing the classification of the following parcels of land, presently shown upon the maps designated as the Zoning Maps and marked as Schedule "A" of "Surrey Zoning By-law, 1993, No. 12000", as amended as follows:

FROM: SINGLE FAMILY RESIDENTIAL ZONE (RF)

TO: COMPREHENSIVE DEVELOPMENT ZONE (CD)

Parcel Identifier: 010-130-721 Lot 27 Section 26 Block 5 North Range 2 West New Westminster District Plan 20979

13773 - 101 Avenue

Parcel Identifier: 010-130-730 Lot 28 Section 26 Block 5 North Range 2 West New Westminster District Plan 20979

10110 - 137A Street

Parcel Identifier: 010-169-156 Lot 41 Section 26 Block 5 North Range 2 West New Westminster District Plan 21005

13793 - 101 Avenue

Parcel Identifier: 010-169-172 Lot 42 Section 26 Block 5 North Range 2 West New Westminster District Plan 21005

13783 - 101 Avenue

Parcel Identifier: 003-335-984 Lot 127 Section 26 Block 5 North Range 2 West New Westminster District Plan 63569

13803 - 101 Avenue

(hereinafter referred to as the "Lands")

2. The following regulations shall apply to the *Lands*:

#### A. Intent

This Comprehensive Development Zone is intended to accommodate and regulate the development of medium density, multiple unit residential buildings and groundoriented multiple unit residential buildings and related amenity spaces, which are to be developed in accordance with a comprehensive design.

#### B. Permitted Uses

The *Lands* and *structures* shall be used for the following uses only, or for a combination of such uses:

- 1. Multiple unit residential buildings and ground-oriented multiple unit residential buildings.
- Child care centres, provided that such centres:
  - (a) Do not constitute a singular use on the lot; and
  - (b) Do not exceed a total area of 3.0 square metres [32 sq.ft.] per dwelling unit.

#### C. Lot Area

Not applicable to this Zone.

## D. Density

- The floor area ratio shall not exceed 2.5.
- 2. The indoor *amenity space* required in Sub-section J.1(b) of this Zone is excluded from the calculation of *floor area ratio*.

## E. Lot Coverage

The lot coverage shall not exceed 54%.

#### F. Yards and Setbacks

1. Buildings and structures shall be sited in accordance with the following minimum setbacks:

Setback Use	Front Yard (West)	Rear Yard (East)	Side Yard (North)	Side Yard on Flanking Street (101 Avenue)
Principal Buildings and Accessory Buildings and Structures	4.5 m [15 ft.]	4.5 m [15 ft.]	6.0 m [20 ft.]	4.5 m [15 ft.]

Measurements to be determined as per Part 1 Definitions of "Surrey Zoning By-law, 1993, No. 12000", as amended.

- 2. Notwithstanding the definition of *setback* in Part 1 Definitions of Surrey Zoning By-law, 1993, No. 12000, as amended, balconies may encroach up to 0.8 metre [2.6 ft.] into the required *setbacks* and canopies may encroach up to 1.5 metres [4.9 ft.] into the required *setbacks*.
- 3. Notwithstanding Sub-section E.17(b) of Part 4 General Provisions of Surrey Zoning By-law, 1993, No. 12000, as amended, stairs with more than three risers may encroach into the *setbacks*.
- 4. Notwithstanding Sub-section A.2(c) of Part 5 Off-street Parking and Loading/Unloading of Surrey Zoning By-law, 1993, No. 12000, as amended, an *underground parking facility* may be located up to the *front lot line*.

## G. Height of Buildings

Measurements to be determined as per Part 1 Definitions of "Surrey Zoning By-law, 1993, No. 12000", as amended.

- 1. <u>Principal buildings</u>: The building height shall not exceed 25 metres [82 ft.].
- 2. <u>Accessory buildings and structures</u>: The building height shall not exceed 4.5 metres [15 ft.].

## H. Off-Street Parking

- 1. Resident and visitor *parking spaces* shall be provided as stated in Table C.6. of Part 5 Off-Street Parking and Loading/Unloading of "Surrey Zoning By-law, 1993, No. 12000", as amended.
- 2. All required resident and visitor *parking spaces* shall be provided as *underground parking*.

## I. Landscaping

- All developed portions of the lot not covered by buildings, structures or
  paved areas shall be landscaped including the retention of mature trees.
  This landscaping shall be maintained.
- 2. Along the developed sides of the *lot* which abut a *highway*, a continuous *landscaping* strip of not less than 1.5 metres [5 ft.] in width shall be provided within the *lot*.
- 3. The boulevard areas of *highways* abutting a *lot* shall be seeded or sodded with grass on the side of the *highway* abutting the *lot*, except at *driveways*.
- 4. Garbage containers and passive recycling containers shall be located within the underground parking or within a building.

## J. Special Regulations

- 1. *Amenity space* shall be provided on the *lot* as follows:
  - (a) Outdoor *amenity space*, in the amount of 3.0 square metres [32 sq. ft.] per *dwelling unit* and shall not be located within the required *setbacks*; and
  - (b) Indoor *amenity space*, in the amount of 3.0 square metres [32 sq. ft.] per *dwelling unit*.
- 2. Child care centres shall be located on the lot such that these centres:
  - (a) Are accessed from a *highway*, independent from the access to the residential uses permitted in Section B of this Zone; and
  - (b) Have direct access to an open space and play area within the lot.
- 3. Balconies are required for all dwelling units which are not ground-oriented and shall be a minimum of 5% of the dwelling unit size or 4.6 square metres [50 sq. ft.] per dwelling unit, whichever is greater.

#### K. Subdivision

Lots created through subdivision in this Zone shall conform to the following minimum standards:

Lot Size	Lot Width	Lot Depth	
3,000 sq. m.	30 metres	100 metres	
[0.74 acre]	[100 ft.]	[328 ft.]	
E CONTRACTOR OF THE PARTY OF TH	77/201	THE SERVICE OF THE SE	

Dimensions shall be measured in accordance with Section E.21 of Part 4 General Provisions of "Surrey Zoning By-law, 1993, No. 12000", as amended.

## L. Other Regulations

In addition to all statutes, bylaws, orders, regulations or agreements, the following are applicable, however, in the event that there is a conflict with the provisions in this Comprehensive Development Zone and other provisions in Surrey Zoning Bylaw, 1993, No. 12000, as amended, the provisions in this Comprehensive Development Zone shall take precedence:

- 1. Definitions are as set out in Part 1 Definitions of "Surrey Zoning By-law, 1993, No. 12000", as amended.
- 2. Prior to any use, the Lands must be serviced as set out in Part 2 Uses Limited, of "Surrey Zoning By-law, 1993, No. 12000", as amended and in accordance with the servicing requirements for the RM-135 Zone in the City Centre as set forth in the "Surrey Subdivision and Development By-law, 1986, No. 8830", as amended.
- 3. General provisions are as set out in Part 4 General Provisions of "Surrey Zoning By-law, 1993, No. 12000", as amended.
- 4. Additional off-street parking requirements are as set out in Part 5
  Off-Street Parking and Loading/Unloading of "Surrey Zoning By-law, 1993,
  No. 12000", as amended.
- 5. Sign regulations are as set out in "Surrey Sign By-law, 1999, No. 13656", as amended.
- 6. Special *building setbacks* are as set out in Part 7 Special Building Setbacks, of "Surrey Zoning By-law, 1993, No. 12000", as amended.
- 7. Building permits shall be subject to the "Surrey Building Bylaw, 2012, No. 17850", as amended.
- 8. Building permits shall be subject to "Surrey Development Cost Charge By-law, 2014, No. 18148", as may be amended or replaced from time to time, and the development cost charges shall be based on the RM-135 Zone in the City Centre.
- 9. Tree regulations are set out in "Surrey Tree Protection By-law, 2006, No. 16100", as amended.
- 10. Development permits may be required in accordance with the "Surrey Official Community Plan, 1996, By-law No. 12900", as amended.
- 11. Provincial licensing of *child care centres* is regulated by the <u>Community Care and Assisted Living Act</u> R.S.B.C. 2002. c. 75, as amended, and the Regulations pursuant thereto including without limitation B.C. Reg 319/89/213.

3.	This By-law shall be c Amendment By-law,	ited for all pu , No.	urposes as "Surrey Zo ."	ning Bylaw,	1993, No. 120	00,
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## MIKE FADUM AND ASSOCIATES LTD. VEGETATION CONSULTANTS

#### SURREY TREE PRESERVATION SUMMARY

Surrey Project No: 07-0375

Project Location: 10110 - 137A Street and 13773 / 83 / 93 / 803 - 101 Avenue, Surrey,

BC

Arborist: Peter Mennel ISA (PN-5611A)

Detailed Assessment of the existing trees or an Arborist's Report is submitted on file. The following is a summary of the tree assessment report for quick reference.

## 1. General Tree Assessment

Mixture of ornamental non native species and native conifers. Some good quality large diameter western redcedar and other trees that have been poorly maintained and topped.

## 2. Summary of Proposed Tree Removal and Replacement

The summary will be available before final adoption.

Number of Protected Trees identified	(A) 15
Number of Protected Trees declared hazardous due to	S. M. 1987.
natural causes	(B) 0
Number of Protected Trees to be removed	(C) 14
Number of Protected Trees to be retained (A-C)	(D) 1
Number of Replacement Trees required	5 VE
(0 alder and cottonwood X 14 others X 2)	(E) 28
Number of Replacement Trees proposed	(F) TBD
Number of Replacement Trees in deficit (E-F)	(G) TBD
Total number of Prot. and Rep. Trees on site (D+F)	(H) TBD
Number of lots proposed in the project	(I) N/A
Average number of Trees per Lot	(H/I) N/A

#### 3. Tree Survey and Preservation/Replacement Plan

Tree Survey and Preservation/Replacement Plan is attached


This plan will be available before final adoption

Summary and plan prepared and submitted by Mike Fadum and Associates Ltd.

Date: November 14, 2013





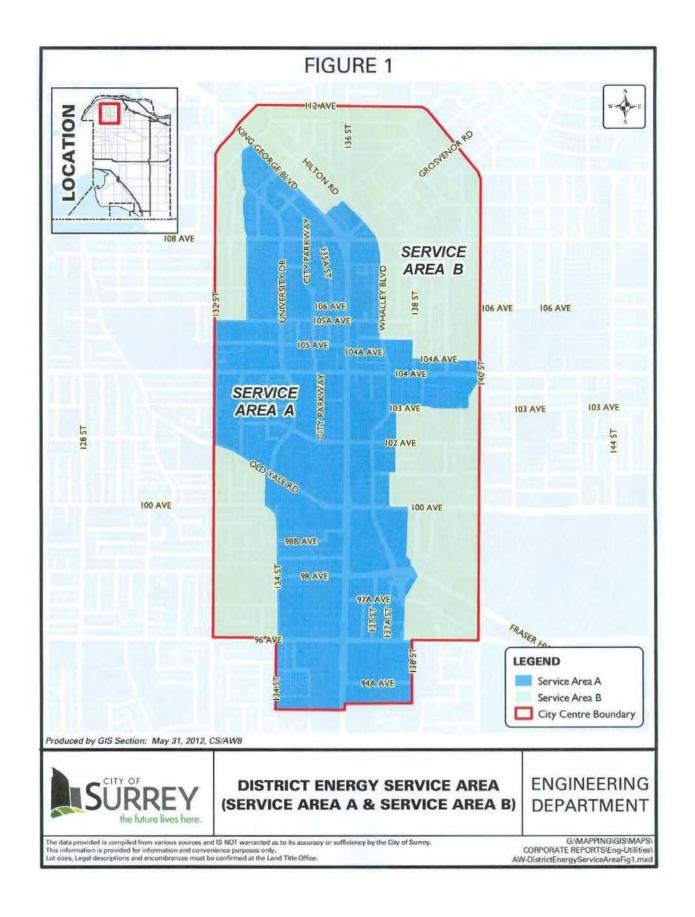



# Advisory Design Panel Minutes

PRC<sub>1</sub> City Hall

14245 - 56 Avenue Surrey, B.C.

THURSDAY, JANUARY 30, 2014

Time: 4:00 pm

Present:

Chair - L. Mickelson

Panel Members: N. Baldwin C. Taylor T. Bunting B. Shigetomi

B. Wakelin S. Vincent

K. Newbert Sgt. M. Searle **Guests:** 

Vivek Memon, JM Architecture Inc. Joe Minten, JM Architecture Inc. Grace Jiang, JM Architecture Inc. Meredith Mitchell, M2 Landscape

Architecture

Richard Bernstein, Chris Dikeakos

Architect

Rueishin Guo, Chris Dikeakos

Architect

Rob Barnes, Perry & Associates

Colin Lacey, Weststone George Steves, Sterling Cooper Staff Present:

T. Ainscough, City Architect

M. Rondeau, Acting City Architect -

Planning & Development H. Dmytriw, Legislative Services

#### B. NEW SUBMISSIONS

1. 4:00 PM

File No.: 7913-0257-00

New or Resubmit: New

Description: Rez and DP two 6-storey buildings with 104 dwelling

units over underground parking.

Address: 101 Avenue and 137A Street, City Centre

Developer: Baldev Brar

Architect: Joe Minten, JM Architecture Inc.

Landscape Architect: Meredith Mitchell, M2 Landscape Architecture

Planner: Pat Lau

Urban Design Planner: Mary Beth Rondeau

**The Urban Design Planner** presented an overview of the proposed project. The proposal generally meets the intent of the policy and zoning for the area. The 4-6 storey building heights will be well within that expected for the area. The site has a significant slope which has been a challenge to address.

Staff had no specific issues with the proposal. Staff are looking for advice specifically on the treatment of the public corner features with formal water features rather than a more natural storm water management treatment as is envisaged for the City Centre.

The Project Architect presented an overview of the site plan, building plans, elevations, cross sections, and streetscapes and highlighted the following:

- The Architect worked with Planning staff to resolve the sloped site with the 2 building concept and stepping with the slopes along the street.
- Each building has ground oriented town homes on all 3 streets including the future street along the east. Each townhome has an entry marker and a glass canopy.
- Parking on 2 levels with 2 separate entrances from the lane.

- Both of the buildings step at the ends to present a 5 storey form on the streets.
- Corner plazas feature landscaping, water features, benches, visitor bike parking.
- Mid-block plaza and secondary entry for Building 2 has landscaping, benches and a community library.
- Main entries to Building 1 and Building 2 are prominent entries with wood siding and wood soffit into interiors space.
- Colour palette is darker grey to lighter grey at top, red contrast.
- Materials include 2 types of masonry; corrugated metal is the material for the red elements. Windows are aluminum window walls with curtain walls for long vertical elements, PVC windows on the remainder.
- Every unit has a balcony. Balconies and roof overhangs have wood soffits.
- Top floors have high ceilings, sloping rooftops, roofs all have large overhangs.
- Sustainability
  - Mechanical system still to be determined.
  - The District Energy System runs along 137A Street.

# **The Landscape Architect** reviewed the landscape plans and highlighted the following:

- Corner plaza water feature slopes downward and is cantilevered for seating.
- Children play areas are smaller spaces with access from Building 1. Amenity area at Building 2 provides a children's small play area with a table and chairs and barbeque.
- Plantings will be shade tolerant and no lawn, due to lack of sun, with a mix of broadleaf, evergreen, ornamental roses, sun tolerant plant materials, and conifers.
- Fencing will be metal and glass panels.

### ADVISORY DESIGN PANEL STATEMENT OF REVIEW

Rez and DP two 6-storey buildings with 104 dwelling units over underground parking

101 Avenue and 137A Street, City Centre File No. 7913-0257-00

The No. 7913-0257-00

It was Moved by K. Newbert

Seconded by S. Vincent

That the Advisory Design Panel (ADP)

recommends that the applicant address the following recommendations and revise and resubmit to the ADP, at the discretion of planning staff.

Carried

#### STATEMENT OF REVIEW COMMENTS

#### Site

- Well worked out approach to sloping and complicated site.
- Provide a single parking access only with interior ramp. Use the site area gained
  to join the open amenity spaces between the buildings. This will better resolve
  the awkward adjacencies with the indoor/outdoor spaces.

After consideration and consultation with the Planning Department staff, it was determined that it would not be feasible to have a single parking access, due to the

nature of the site and the amount of space an internal ramp would take away from the parking and landscaping.

Also relocate the west exit stair in Building 2 so that the amenity space has direct
access to the open space between the buildings.
 The west exit stair in Building 2 has been rotated 90 degrees to allow direct access
to the outdoor amenity space from the indoor amenity room of Building 2.

## **Building Form and Character**

- Massing articulation breaks up forms nicely. Interesting modular shifts but all the little ins-and-outs which could be simplified. The stepping down on 137A could be repeated at the building break and at the east. The 6<sup>th</sup> floor units of both buildings adjacent to the outdoor amenity space along 101 Avenue have been changed from 1-bedroom units to studio units, allowing the buildings to step back at the break between the buildings.
- Transition between 6<sup>th</sup> storey and 2<sup>nd</sup> storey massing is not well handled either in the building massing through its transverse section or through its east and west elevations. These side elevations could have more interest in a variation in massing to transition between the 6<sup>th</sup> storey and 2<sup>nd</sup> storey.
- The response to solar for the different facades could be more explicit.

  Horizontal aluminum solar shades have been added to windows along the south façade. Vertical solar shades have been added along the west façade.
- Really like the streetscape row houses.
- Some areas could have better privacy, i.e. south east corner where the public space is in front of the basement residential unit.
   Increased landscaping has been added to provide a higher level of privacy where needed.
- The large entrance roofs create dark spaces and could be better integrated with the building articulation. Suggest making them accessible and usable.

  The main entry of Building 1 has been brought back towards the building another 1.2 m (4 ft.). Rooftop spaced as a balcony for the unit above.
- Make better use of the potential natural light into public corridor space.
   Large windows have been incorporated into public corridors and some stairwells to bring in natural light.
- The main entrance is narrow.
- The north façade needs to be upgraded to be more like the street facades.
   The north and south facades have been modified so that they more closely resemble each other.
- Elevations well-ordered but busy. Could calm number of materials down. Unite colours.
  - Red colour really stands out.

- Consider a different metal material or smaller scaled corrugation
- Consider not using corrugated on balcony fronts
- O Consider a non-variegated masonry, simplify to one masonry material The Red corrugated material has been removed from the balconies on the 2<sup>nd</sup> to 6<sup>th</sup> floors and the balconies are now all in glass.
- Wood may be an issue for exterior finish for six storey building (combustibility), but should keep wood look using conforming material.
   The architect has reviewed this issue and believe he has an appropriate solution for its use.
- The detailing will be important. Need more information on hardie panelling and PVC windows.

Hardie panels and metal trim, with matching colours will be used. Colour samples of Hardie panel and trim, as well as window samples have been provided.

### Landscaping

- Nice approach with landscaping, streetscape with good buffering between public and private.
- The centre space is tight, could use some extra buffering.
   Buffering has been added at public/private transitions.
- Water feature 'plazas' are a nice amenity and provide a nice animation effect but ongoing maintenance requires a commitment from strata, and may eventually become planters.
- Consider noise of the water features. Should be designed for more subtle sounds otherwise they may be turned off.
- Good use of permeable hard surfaces and soft landscaping.
- Could be more storm water management features.

#### CPTED

No pressing issues or crime generators that would overly impact the site.

#### Accessibility

- Power doors at entrances, also in parking lobby.
   Power doors will be added at all accessible entries.
- Parking recommend two extra spaces:
  - Visitor one located close to elevator building 2
  - Residential one located closer to Buildings elevator

The project now has 2 accessible spaces in the residential parking area on Level 2, as well as 1 additional accessible space for residential on Level 1 for a total of 5 accessible spaces.

• Elevator and call button panel be placed horizontally. Elevator buttons will be placed appropriately for accessibility.

- Recommend emergency call buttons in parking lobbies.
   Emergency call buttons will be placed appropriately for accessibility.
- Amenity Wheelchair washrooms?
   Amenity rooms in both buildings have 2 accessible washrooms.
- Roof top amenity okay for accessibility.
- Recommend 5% of units be wheelchair friendly.
   A minimum of 5% adaptable units will be accommodated in both buildings.
- Minor point, move or add accessible parking stall closer to east elevator lobby.
   Prefer adding one so each building has a dedicated accessible parking stall for residents.

Accessible parking stalls, close to the doors, have been added to both buildings.

## Sustainability

 Generally a weak response to sustainability - would highly recommend pursuing DES.

The applicant's architect reiterated that the intent of the project is to connect with the City's District Energy system.

- To sum up, a little bit more effort on sustainability would significantly improve the project.
  - Storm water management consider rain water reuse for toilet flushing.
  - Window variation by elevation

Windows do not vary, but sunshades have been added to affected windows on south and west elevations.

- Consider using low flow plumbing fixtures.
   Low flow fixtures will be added to the design.
- Consider heat recovery ventilators (HRV) per suite.
- Glass boxes on top floors on south and west elevations may cause overheating in summer and will end up with window covering that close off the top of windows to mitigate the glare.

Window shading has been added to all affected windows at the south and west facades.

Current plans are for heater panels to augment domestic hot water.
 The applicant's architect has indicated that there are no plans for heater panels.
 They are planning to use District Energy for domestic hot water.