

City of Surrey PLANNING & DEVELOPMENT REPORT Application No.: 7918-0251-00

Planning Report Date: January 11, 2021

PROPOSAL:

- OCP Amendment from Suburban to Urban
- LAP Amendment from Low Density Townhouse 12-15 UPA Gross to Townhouse 15-20 UPA Gross
- **Rezoning** from RA to CD (based on RM-15)
- Development Permit

to permit the development of 94 townhouse units.

LOCATION: 9650 - 182A Street

9684 - 182A Street 9716 - 182A Street


ZONING: RA

OCP DESIGNATION: Suburban

LAP DESIGNATION: Low Density Townhouse 12-15 UPA

Gross, Landscape Buffer and Tree

Retention Area

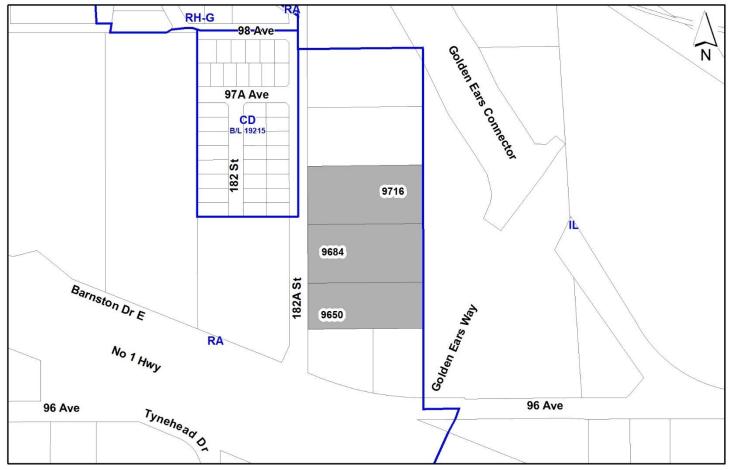

RECOMMENDATION SUMMARY

- Bylaw Introduction and set date for Public Hearing for:
 - OCP Amendment; and
 - Rezoning.
- Approval to draft Development Permit for Form and Character.

DEVIATION FROM PLANS, POLICIES OR REGULATIONS

- Proposing an amendment to the Official Community Plan (OCP) from Suburban to Urban.
- Proposing an amendment to the Abbey Ridge Local Area Plan (LAP) from Low Density Townhouse 12-15 UPA Gross to Townhouse 15-20 UPA Gross.

RATIONALE OF RECOMMENDATION

- The proposed amendment to the Official Community Plan (OCP) to redesignate the subject site from "Suburban" to "Urban" is consistent with the Abbey Ridge Local Area Plan's anticipated land use designation for this area.
- The proposed amendment to the Abbey Ridge Local Area Plan (LAP) to redesignate a portion of the subject site from "Low Density Townhouse 12-15 UPA Gross" to "Townhouse 15-20 UPA Gross" will accommodate 94 townhouse units at a gross density of 17 UPA. The proposed increase in density accommodates a more efficient site plan, while still being consistent with the land use intent of the Abbey Ridge LAP, by providing ground-oriented multifamily residences, with appropriate density transition and tree retention.
- The applicant has worked with staff and the Fraser Heights Community Association (FHCA) to ensure appropriate interface treatment, tree retention, and additional visitor parking. The FHCA has indicated that they have no objection to the proposal.
- The proposed density and building form are appropriate for this part of Fraser Heights.
- All of the proposed townhouse units feature double side-by-side garages. No tandem parking is proposed. Up to a total of 45 visitor parking stalls are identified, which exceeds the 19 stalls required under the Zoning Bylaw.
- The proposed architectural design of the project is intended to complement the emerging residential character developing through new single-family homes and townhouses in the Abby Ridge neighbourhood.
- The proposal retains a substantial grove of trees within a central location on the development site.

RECOMMENDATION

The Planning & Development Department recommends that:

- 1. A Bylaw be introduced to amend the OCP Figure 3: General Land Use Designations for the subject site from Suburban to Urban and a date for Public Hearing be set.
- 2. Council determine the opportunities for consultation with persons, organizations and authorities that are considered to be affected by the proposed amendment to the Official Community Plan, as described in the Report, to be appropriate to meet the requirement of Section 475 of the Local Government Act.
- 3. A Bylaw be introduced to rezone the subject site from "One-Acre Residential Zone (RA)" to "Comprehensive Development Zone (CD)" and a date be set for Public Hearing.
- 4. Council authorize staff to draft Development Permit No. 7918-0251-00 generally in accordance with the attached drawings (Appendix I).
- 5. Council instruct staff to resolve the following issues prior to final adoption:
 - (a) ensure that all engineering requirements and issues including restrictive covenants, dedications, and rights-of-way where necessary, are addressed to the satisfaction of the General Manager, Engineering;
 - (b) submission of a subdivision layout to the satisfaction of the Approving Officer;
 - (c) approval from the Ministry of Transportation & Infrastructure;
 - (d) final approval from TransLink;
 - (e) resolution of all urban design issues to the satisfaction of the Planning and Development Department;
 - (f) submission of a finalized landscaping plan and landscaping cost estimate to the specifications and satisfaction of the Planning and Development Department;
 - (g) submission of a finalized tree survey and a statement regarding tree preservation to the satisfaction of the City Landscape Architect;
 - (h) the applicant satisfy the deficiency in tree replacement on the site, to the satisfaction of the Planning and Development Department;
 - (i) the applicant provide a density bonus amenity contribution consistent with the Tier 2 Capital Projects CACs in support of the requested increased density, to the satisfaction of the General Manager, Planning and Development Department;
 - (j) demolition of existing buildings and structures to the satisfaction of the Planning and Development Department;

- (k) submission of an acoustical report for the units adjacent to the Golden Ears Connector and registration of a Section 219 Restrictive Covenant to ensure implementation of noise mitigation measures;
- (l) registration of a statutory right-of-way and Section 219 Restrictive Covenant to ensure maintenance and monitoring of the tree grove for a minimum of 3 years, to the satisfaction of the General Manager, Planning & Development Services;
- (m) registration of a Section 219 Restrictive Covenant to adequately address the City's needs with respect to public art, to the satisfaction of the General Manager Parks, Recreation and Culture; and
- (n) registration of a Section 219 Restrictive Covenant to adequately address the City's needs with respect to the City's Affordable Housing Strategy, to the satisfaction of the General Manager, Planning & Development Services.
- 6. Council pass a resolution to amend the Abbey Ridge Local Area Plan (LAP) to redesignate at the subject site from "Low Density Townhouse 12-15 UPA Gross" to "Townhouse 15-20 UPA Gross", as shown in Appendix VI, when the project is considered for final adoption.

SITE CONTEXT & BACKGROUND

Direction	Existing Use	LAP Designation	Existing Zone
Subject Site	Large acreage single family lots	Low Density Townhouses 12-15 UPA Gross	RA
North:	Large acreage single family lot	Low Density Townhouses 12-15 UPA Gross	RA
East (Across Excess TransLink Owned Land and Golden Ears Connector/Highway):	Vacant industrial lots	Landscape Buffer and Industrial in OCP	IL
South:	Single family lots	Low Density Townhouses 12-15 UPA Gross	RA
West (Across 182A Street):	Recently created vacant small single family lots and large vacant acreage lot	Urban Residential 8-10 UPA	CD (Bylaw No. 19215) and RA

Context & Background

• The 2.23-hectare (5.57-acre) subject site is comprised of 3 large acreage lots located at 9650, 9684 and 9716 – 182A Street in Fraser Heights.

- The subject properties are designated Suburban in the Official Community Plan (OCP), Low Density Townhouse 12-15 UPA Gross in the Abbey Ridge Local Area Plan (LAP) and are zoned "One-Acre Residential (RA) Zone".
- The properties contain significant treed areas, and the Abbey Ridge LAP designates the site as a tree retention area.

DEVELOPMENT PROPOSAL

Planning Considerations

- The applicant proposes the following in order permit the development of 94 townhouse units:
 - o OCP Amendment from Suburban to Urban;
 - Abbey Ridge LAP Amendment from Low Density Townhouse 12-15 UPA Gross to Townhouse 15-20 UPA Gross;
 - o Rezoning from RA to a CD Zone based on the RM-15 Zone; and
 - o Development Permit for Form and Character.
- The following table provides specific details on the proposal:

	Proposed
Lot Area	
Gross Site Area:	22,500 square metres
Road Dedication:	o square metres
Undevelopable Area:	o square metres
Net Site Area:	22,500 square metres
Number of Lots:	1
Building Height:	11 metres
Unit Density:	17 UPA
Floor Area Ratio (FAR):	0.73
Floor Area	
Residential:	16,761 square metres
Commercial:	o square metres
Total:	16,761 square metres
Residential Units:	
3-Bedroom:	94
Total:	94

Referrals

Engineering: The Engineering Department has no objection to the project

subject to the completion of Engineering servicing requirements as

outlined in Appendix II.

The applicant must complete all servicing requirements outlined in

the Land Development Engineering Review prior to Final

Adoption. The applicant is reminded that moving forward to the Design Review phase does not guarantee acceptance of the layout.

The development application is dependent on the applicant securing various third-party approvals. Should these approvals not be achieved the application and layout may need to be amended.

The applicant is proceeding at their own risk based on the requirements of the Land Development Engineering Review.

School District: The School District has provided the following projections for

the number of students from this development:

24 Elementary students at Bothwell Elementary School 12 Secondary students at Fraser Heights Secondary School

(Appendix III)

The applicant has advised that the dwelling units in this project are expected to be constructed and ready for occupancy by January

2023.

Parks, Recreation &

Culture:

The applicant is required to pay the amenity contribution on a per

unit basis in keeping with the Abbey Ridge LAP.

Ministry of Transportation

& Infrastructure (MOTI):

MOTI has granted preliminary approval of the proposed drainage

plan.

Surrey Fire Department: No concerns.

Transportation Considerations

The applicant will be required to construct the east side of 182A Street to the Through Local Standard, which will provide driveway access to the site.

Given the proposed secondary plan amendment, the applicant provided a Transportation Impact Study (TIS). Based on the proposed size, the development is expected to generate 45 to 55 two-way vehicle movements in the morning and afternoon peak-hour periods, respectively.

• The project architect has identified 45 potential locations for visitor parking on the site. This is substantially higher than the 19 parking spaces required under the Zoning By-law (at a rate of 0.2 parking spaces per units) and the 28 parking spaces that would be required at a ratio of 0.3 parking spaces per unit, as typically requested by the Fraser Heights Community Association (FHCA) on other similar townhouse projects in the area. City staff have suggested that the visitor parking be reduced somewhat to allow for additional open space, permeability, and landscaping on the site. City staff will work with the applicant, and the FHCA, prior to Final Adoption to confirm an appropriate final number of visitor parking spaces, with the expectation that a minimum of 28 spaces will be provided on the site.

Sustainability Considerations

• The applicant has met all of the typical sustainable development criteria, as indicated in the Sustainable Development Checklist.

POLICY & BYLAW CONSIDERATIONS

Regional Growth Strategy

• The subject site is compliant with the General Urban Land Use Designation of Metro Vancouver's Regional Growth Strategy.

Official Community Plan

Land Use Designation

• The subject site is designated Suburban in the OCP, and the applicant proposes to redesignate the site to Urban.

Amendment Rationale

- The proposed Urban OCP designation is consistent with the proposed land use in the Abbey Ridge LAP.
- As described in Corporate Report No. R243; 2015, it is anticipated that individual OCP
 Amendment applications will be brought forward, where applicable, with the companion
 rezoning applications, in the Abbey Ridge LAP area.

<u>Public Notification for Proposed OCP Amendment</u>

• Pursuant to Section 475 of the <u>Local Government Act</u>, it was determined that it was not necessary to consult with any persons, organizations or authorities with respect to the proposed OCP amendment, other than those contacted as part of the pre-notification process.

- The proposed development is supported by the following policies of the Official Community Plan:
 - o Growth Management
 - Growth Priorities: Comprehensively-planned new neighbourhoods within approved Secondary Plan areas.
 - Centres, Corridors and Neighbourhoods:
 - Healthy Neighbourhood: Design housing units to front directly onto public streets in order to facilitate a safe, welcoming, public streetscape and public realm.
 - Healthy Neighbourhood: Protect and retain significant trees, forest stands and other natural features within new and existing neighbourhoods.
 - Urban Design: Ensure a new development responds to the existing architectural character and scale of its surroundings, creating compatibility between adjacent sites and within neighbourhoods.
 - o Ecosystems
 - Energy, Emissions and Climate Resiliency: Design a community that is energy-efficient, reduces carbon emissions and adapts to a changing environment through a design that meets typical sustainable development criteria.

Secondary Plans

Land Use Designation

- The subject site is designated Low Density Townhouses 12-15 UPA Gross in the Abbey Ridge Local Area Plan. The LAP also designates the site as a Tree Retention area and identifies a 12-metre-wide landscape buffer along the east property line.
- The applicant is proposing an amendment from Low Density Townhouse 12-15 UPA Gross to Townhouse 15-20 UPA Gross (see Appendix VI) and to remove the requirement for a landscape buffer along the east property line.
- The applicant is proposing to retain a significant stand of forest on the site, which satisfies the requirement for additional tree retention, per the LAP.

Amendment Rationale

• The applicant is proposing to redesignate portions of the site from "Low Density Townhouse 12-15 UPA Gross" to "Townhouse 15-20 UPA Gross."

- The proposed amendment to the Abbey Ridge Local Area Plan (LAP) to redesignate the subject site from "Low Density Townhouse 12-15 UPA Gross" to "Townhouse 15-20 UPA Gross" will accommodate 94 townhouse units at a gross density of 17 UPA. The proposed increase in density accommodates a more efficient site plan, while still being consistent with the land use intent of the Abbey Ridge LAP, by providing ground-oriented multifamily residences, with appropriate density transition and tree retention.
- The applicant has worked with staff and the Fraser Heights Community Association (FHCA) to ensure appropriate interface treatments and a desirable streetscape particularly along 182A Street, along with additional visitor parking.
- The proposed density of 17 UPA is identical to that of other townhouse developments in the Abbey Ridge area previously under the same land use designation. These projects were endorsed by Council in 2018, 2019 and 2020 (Application Nos. 7917-0067-00, 7918-0313-00 and 7919-0192-00, respectively) with a similar consultation process with the FHCA.
- The proposed 94 townhouse project provides a mix of housing options within the Abbey Ridge LAP.
- The removal of the requirement for a 12-metre-wide landscape buffer along the east property line has merit given the extended distance between the east lot line and the nearest vehicular travel lane on Golden Ears Way/Golden Ears Connector.
- The proposed development will be subject to the Tier 2 Capital Plan Project CACs for proposed density greater than the Secondary Plan designation, as described in the Community Amenity Contribution section of this report.

Themes/Objectives

- The proposed development is consistent with the following planning objectives:
 - Provide an appropriate interface between new and established neighbourhoods through compatible density, form and scale of housing, and through landscaped and natural buffers
 - o Protect environmental areas by retaining significant stands of trees where feasible on development sites.

CD Bylaw

• The applicant is proposing a "Comprehensive Development Zone (CD)" to accommodate a 94-unit townhouse development on the subject site. The proposed CD Bylaw for the proposed development site identifies the uses, densities and setbacks proposed. The CD Bylaw will have provisions based on the "Multiple Residential 15 Zone (RM-15)".

• A comparison of the density, lot coverage, setbacks, building height and permitted uses in the RM-15 Zone and the proposed CD Bylaw is illustrated in the following table:

	RM-15 Zone	Proposed CD Zone
Unit Density:	37 uph / 15 upa	42 uph / 17 upa
Floor Area Ratio:	.70 FAR	. ₇₅ FAR
Lot Coverage:	45%	45%
Yards and Setbacks		
North:	7.5 m	3.5 m
East:	7.5 m	3.5 m
South:	7.5 m	3.0 m
West:	7.5 m	4.5 m
Height of Buildings		
Principal buildings:	11 m	11 m
Accessory buildings:	4.5 m	4.5 m
Amenity Space		
Indoor Amenity:	3 square metres per unit.	The proposed 283 m ² exceeds the Zoning Bylaw requirement.
Outdoor Amenity:	3 square metres per unit.	The proposed 3,667 m ² exceeds the Zoning Bylaw requirement.
Parking (Part 5)	Required	Proposed
Number of Stalls		
Commercial:		
Industrial:		
Residential:	188	188
Residential Visitor:	19	45
Total:	207	233
Tandem (%):		

- The proposed CD bylaw increases the allowable unit density from 15 units per acre in the RM-15 Zone to 17 units per acre, and the floor area ratio (FAR) has been increased from 0.7 to 0.75 to accommodate the proposed development.
- The proposed setbacks have been reduced from 7.5 metres to 3.5 metres along the north and east lot lines, and to 3.0 metres along the south lot line, in a side-of-unit condition, and 4.5 metres along the front (west) lot line to create a more urban streetscape along 182A Street.

Capital Projects Community Amenity Contributions (CACs)

- On December 16, 2019, Council approved the City's Community Amenity Contribution and Density Bonus Program Update (Corporate Report No. R224; 2019). The intent of that report was to introduce a new City-wide Community Amenity Contribution (CAC) and updated Density Bonus Policy to offset the impacts of growth from development and to provide additional funding for community capital projects identified in the City's Annual Five-Year Capital Financial Plan.
- The proposed development will be subject to the Tier 1 Capital Plan Project CACs. The contribution will be payable at the rate applicable at the time of Building Permit Issuance (\$1,500 per unit if completed by December 31, 2021; and \$2,000 per unit if completed after January 1, 2022).
- The proposed development will be subject to the Tier 2 Capital Plan Project CACs for proposed density greater than the Secondary Plan designation.
- The applicant will be required to provide a cash contribution in order to satisfy the proposed Secondary Plan Amendment. The applicable contribution amount will be confirmed in accordance with the Density Bonus Policy prior to Rezoning Final Adoption.

Affordable Housing Strategy

- On April 9, 2018, Council approved the City's Affordable Housing Strategy (Corporate Report No. Ro66; 2018) requiring that all new rezoning applications for residential development contribute \$1,000 per unit to support the development of new affordable housing. The funds collected through the Affordable Housing Contribution will be used to purchase land for new affordable rental housing projects.
- The applicant will be required to register a Section 219 Restrictive Covenant to address the City's needs with respect to the City's Affordable Housing Strategy.

Public Art Policy

- The applicant will be required to provide public art, or register a Restrictive Covenant agreeing to provide cash-in-lieu, at a rate of 0.5% of construction value, to adequately address the City's needs with respect to public art, in accordance with the City's Public Art Policy requirements. The applicant will be required to resolve this requirement prior to consideration of Final Adoption.
- Affordable Housing and Public Art contributions are payable at building permit.

PUBLIC ENGAGEMENT

- Pre-notification letters were sent on September 16, 2019, and the Development Proposal Signs were installed on January 4, 2021. Staff received 1 email and 1 letter from neighbouring residents (staff comments in italics):
- The proposed density is too high.

(The proposed increase in density accommodates a more efficient site plan, while still being consistent with the land use intent of the Abbey Ridge LAP, by providing ground-oriented multifamily residences, with appropriate density transition and tree retention.

• There are a lack of schools and parks in the neighbourhood.

(Two large parks are located adjacent to the Abbey Ridge Local Area Plan with Surrey Bend Regional Park located to the north and Tynehead Park located to the south. There is also a future park identified within the middle of the Abbey Ridge plan area close to Lyncean Drive.

The subject site is within the catchment areas of Bothwell Elementary and Fraser Heights Secondary School. School District comments are attached to this report in Appendix III.)

• Existing infrastructure will not be able to support the increased density.

(The proposal will be required to upgrade fronting infrastructure to meet infrastructure demands.)

• Along 182A Street, there is insufficient lighting as well as ditches which make it dangerous especially when accessing transit.

(As part of the rezoning and subdivision process developers are responsible for completing road frontage upgrades at no cost to the City. For the subject application the developer will be responsible for pavement widening, sidewalk construction, street lighting, and street trees along the east side of 182A Street for the extent of their property. Similarly, as future development occurs along 182A Street there will be road frontage upgrades completed.)

• Barnston Drive needs to be upgraded with a pedestrian crosswalk for residents connecting to 96 Avenue on foot.

(Pedestrian crosswalks are installed on warrant basis, at the request of residents. The City would evaluate factors such as traffic volume, pedestrian volume, and geometry of the road in consideration of a particular location.)

 Concerns that the proposed development will impact local well water due to construction and digging vibration.

(The developer has been made aware of the resident's concern of local wells potentially being impacted during construction.)

• The subject development application was reviewed by the Fraser Heights Community Association. The Fraser Heights Community Association indicated that they do not object to this proposal moving forward for Council's consideration.

DEVELOPMENT PERMITS

Form and Character Development Permit Requirement

- The proposed development is subject to a Development Permit for Form and Character and is also subject to the urban design guidelines in the Abbey Ridge Local Area Plan (LAP).
- The proposed development generally complies with the Form and Character Development Permit guidelines in the OCP and the design guidelines in the Abbey Ridge Local Area Plan (LAP).
- The proposed townhouse development consists of 94 townhouse units (all 3 bedroom) in 25 buildings. All of the units feature double side-by-side garages, no tandem parking is proposed. Several of the units include full length driveways, which can accommodate additional parking, and a total of 45 visitor parking stalls are proposed, which exceeds the 19 stalls required under the Zoning Bylaw.
- The applicant has worked with staff to address the topography of the site which has a 15% slope in some locations. To address the grade changes, the applicant has proposed the larger driveway aprons with retaining walls.
- The applicant also worked with staff to ensure that the proposed units along 182A Street appropriately interface with the single-family character on the west side of 182A Street. This was achieved by providing duplex-style units with a 2-storey appearance along this frontage.
- The applicant has worked with staff to address interfacing issues with the existing single-family character on the west side of 182A Street as follows:
 - Buildings fronting 182A Street have been designed with 'sunken' garages accessed from the internal drive aisle. Pedestrian access to these units is provided from 182A Street at the second floor living level. These buildings have 3 storeys facing the internal driveway and only 2 levels exposed to 182A Street.
 - o Buildings along 182A Street have been broken into duplex-style buildings.
 - The proposed architectural design of the project is intended to complement the emerging residential character developing through new single-family homes and townhouses in the Abby Ridge neighbourhood. The cladding materials include fibre cement siding and shingles.

Landscaping and Tree Grove

- Landscaping consisting of coniferous and deciduous trees such as Japanese Maple, Beech and Magnolia, interspersed with a wide variety of shrubs, grasses and perennials will be planted throughout the development.
- The applicant proposes to retain tree grove approximately 2,700 square metres in size. The applicant has focused on retaining stands of high quality trees as identified by the arborist and have confirmed that the newly established edge will remain windfirm. The perimeter of the tree grove will be enhanced with additional landscaping, including low and mid-growth shrubbery.

• The proposed tree grove will be protected in perpetuity through a statutory right-of-way and restrictive covenant to ensure maintenance and monitoring for a minimum period of 3 years.

Indoor Amenity

- Based upon the City's Zoning Bylaw requirement, the proposed development must provide 282 square metres of indoor amenity space to serve the residents of the proposed 94 townhouse units.
- The applicant proposes 283 square metres of indoor amenity space, which meets the minimum indoor amenity space requirement for the project.
- The proposed 2-level indoor amenity building is located near the site entrance, adjacent to Building 17. The space provides a lounge, meeting room, yoga, gym and kitchen facilities. The indoor amenity space can be accessed directly from the outdoor amenity area.

Outdoor Amenity

- Based upon the City's Zoning Bylaw requirement of 3 square metres per dwelling unit, the proposed development must provide a total of 282 square metres of outdoor amenity space to serve the residents of the proposed 94 units.
- The applicant proposes 3,667 square metres of outdoor amenity space centrally located on the subject site. The amenity area features a variety of programming including casual seating, dining areas, a children's play area, and a substantial grove of trees.

TREES

• Corey Plester, ISA Certified Arborist of Mike Fadum and Associates Ltd. prepared an Arborist Assessment for the subject property. The table below provides a summary of the tree retention and removal by tree species:

Table 1: Summary of Tree Preservation by Tree Species:

Tree Species	Existing	Retain						
Alder and Cottonwood Trees								
Alder/Cottonwood	4	4	0					
	Deciduous Trees							
(excludir	g Alder and Cottonwo	ood Trees)						
Beech	2	0	2					
Bigleaf Maple	5	5	0					
Cherry	11	10	1					
English Oak	1	1	0					
Horse Chestnut	1	1	0					
Little Leaf Linden	1	1	0					
Magnolia	1	1	0					
Maple	1	1	0					
Mountain Ash	2	2	0					
Weeping Willow	1	1	0					

Tree Species	Existing		Remove	Retain		
Coniferous Trees						
Cypress Lawson		0				
Deodar Cedar		1	1	0		
Douglas Fir		126	93	33		
Giant Sequoia		1	1	0		
Sitka Spruce		1	1	0		
Western Hemlock		5	3	2		
Western Red Cedar		37	26	11		
Total (excluding Alder and Cottonwood Trees)	:	199	150	49		
Total Replacement Trees Proposed (excluding Boulevard Street Trees)	ł		161			
Total Retained and Replacement Trees		210				
Contribution to the Green City Program		\$57,200				

- The Arborist Assessment states that there is a total of 199 mature trees on the site, excluding Alder and Cottonwood trees. Four (4) existing trees, approximately 2% of the total trees on the site, are Alder and Cottonwood trees. It was determined that 49 trees can be retained as part of this development proposal. The proposed tree retention was assessed taking into consideration the location of services, building footprints, road dedication and proposed lot grading.
- For those trees that cannot be retained, the applicant will be required to plant trees on a 1 to 1 replacement ratio for Alder and Cottonwood trees, and a 2 to 1 replacement ratio for all other trees. This will require a total of 304 replacement trees on the site. Since only 161 replacement trees can be accommodated on the site, the deficit of 143 replacement trees will require a cash-in-lieu payment of \$57,200.00, representing \$400 per tree, to the Green City Program, in accordance with the City's Tree Protection Bylaw.
- In addition to the replacement trees, boulevard street trees will be planted on 182A Street. This will be determined by the Engineering Department during the servicing design review process.
- The new trees on the site will consist of a variety of trees including Japanese Maple, Beech and Magnolia.
- In summary, a total of 210 trees are proposed to be retained or replaced on the site with a contribution of \$57,200.00 to the Green City Program.

Application No.: 7918-0251-00

Page 16

INFORMATION ATTACHED TO THIS REPORT

The following information is attached to this Report:

Appendix I. Site Plan, Building Elevations, Landscape Plans

Appendix II. Engineering Summary
Appendix III. School District Comments

Appendix IV. Summary of Tree Survey and Tree Preservation

Appendix V. LAP Plan and Proposed Amendment

Appendix VI. OCP Redesignation Map


Appendix VII. Aerial Photos


approved by Ron Gill

Jean Lamontagne General Manager


Planning and Development

LM/cm

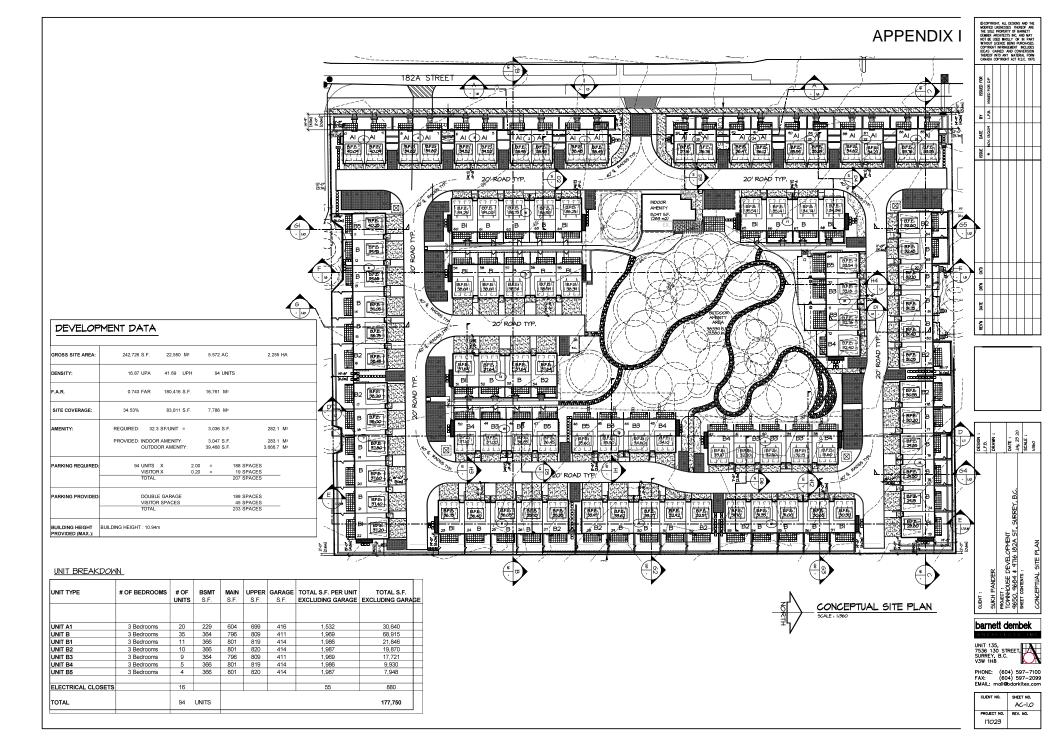

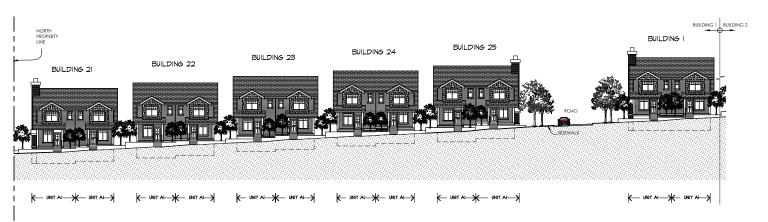

STREETSCAPE - 182A STREET

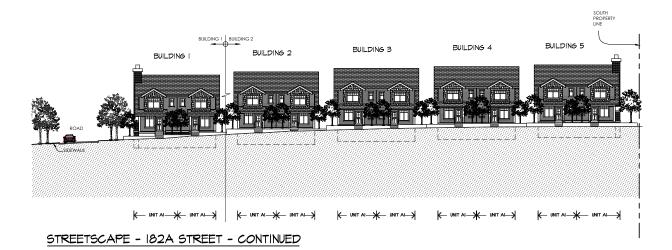


©COPYRIGHT, ALL DESIGNS AND THE MODIFIED LIKENESSES THEREOF ARE THE SOLE PROPERTY OF BARNETT DEMEKS ACHITECTS INC. AND MAY NOT BE USED WHOLLY OR IN PART WITHOUT LICENCE BEING PURCHASED. COPYRIGHT INFRINGEMENT. INCLIDES							
	COPYRIGHT INFRINGEMENT INCLUDES IDEAS GAINED AND CONVERSION THEREOF INTO ANY MATERIAL FORM CANADA COPYRIGHT ACT R.S.C. 1970.						
ISSUED FOR	1990ED FOR D.P.						
М	J.B.						
DATE	NOV. IS/2019						
BSSI	Ŧ						
СЖD							
DRN							
DATE							
REVN							

_			

barnett dembek

UNIT 135, 7536 130 STREET, SURREY, B.C. V3W 1H8

CLIENT NO.	SHEET NO. AC-1.5
PROJECT NO.	REV. NO.
17023	

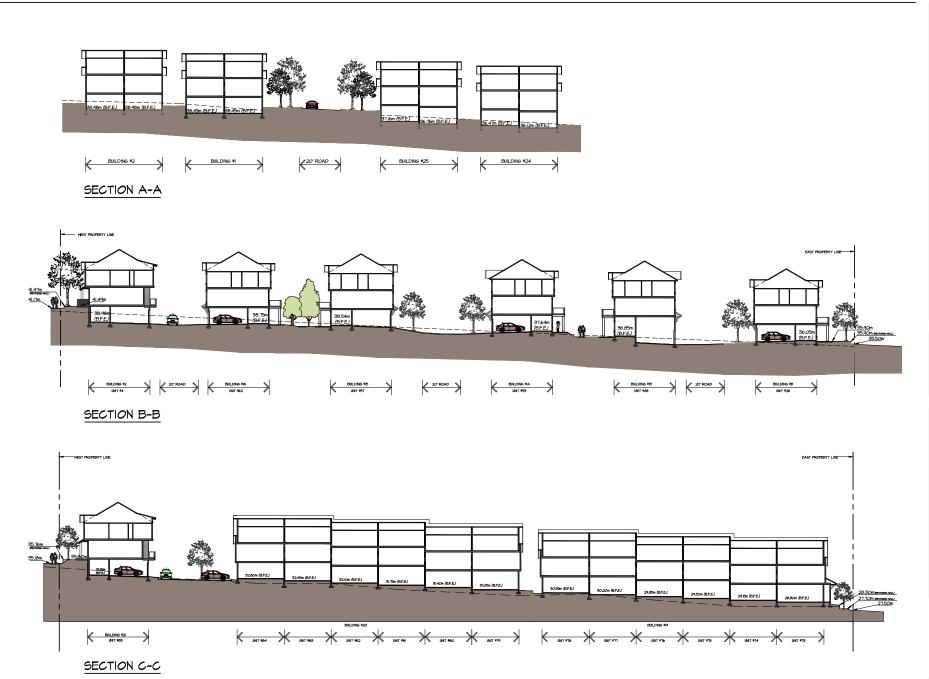







DESIGN : L.F.B.	RREY, B.C. Jan. 0 18 SCALE: 1200
QLENT : SUKH PANDER	PROBERT TOWNHOUSE DEVELOPMENT SHRREY, B.C., SHEREY, B.C., SHEREY, B.C., SHER COMBUTS:


CLIENT NO.	SHEET NO. AC-1.6
PROJECT NO.	REV. NO.
17023	

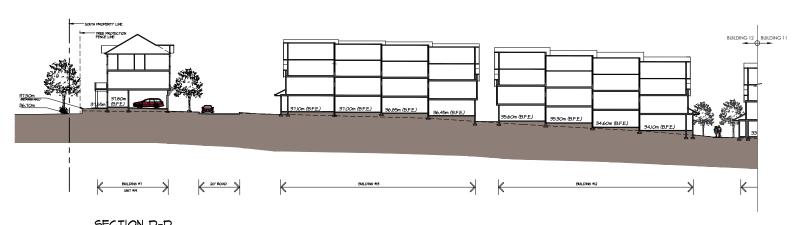

SECTION D-D

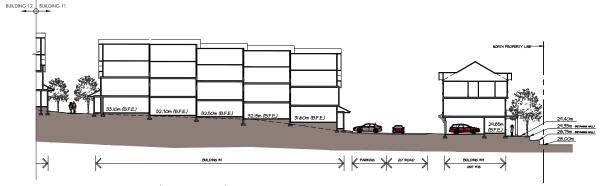

SECTION D-D (CONTINUED)

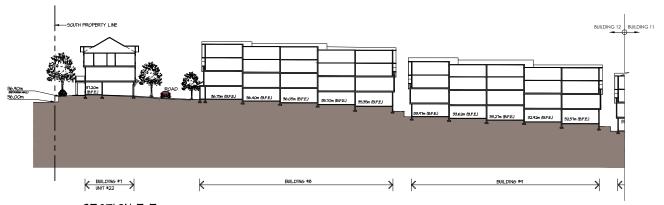

SECTION E-E


©COPYRIGHT, ALL DESIGNS AND THE MODIFIED LIKENIESS. THEREOF ARE THE SCLE PROPERTY OF BANKETT DEMBER ARCHITECTS INC. AND MAY NOT SE USED BHOLLY OR IN PART WITHOUT LUCINCE BEING PURCHASED. COPYRIGHT REPROBLEMENT NOLIDES IDEAS GAINED AND CONVERSION DEAS GAINED AND CONVERSION DESIGNATION ONLY MATERIAL FORM CAMMON COPYRIGHT ACT R.SC. 1970.							
ISSUED FOR	1994ED FOR D.P.						
В.	J.B.						
DATE	NOV. IB/2019						
ISSUE	Ŧ						
сжр							
DRN							
DATE							
2							




olent : SJKH PANDER	DESIGN : L.F.B.
	DRAWN:
PROJECT :	
IOWNHOUSE DEVELOPMENI 9650, 9684 & 9716 182A ST., SURREY, B.C.	DATE: Jon. 10 19
SHEET CONTENTS:	
SHOT SECTION	SCALE:
	8

barnett dembek

CLIENT NO.	SHEET NO. AC-1.7
PROJECT NO.	REV. NO.
17023	

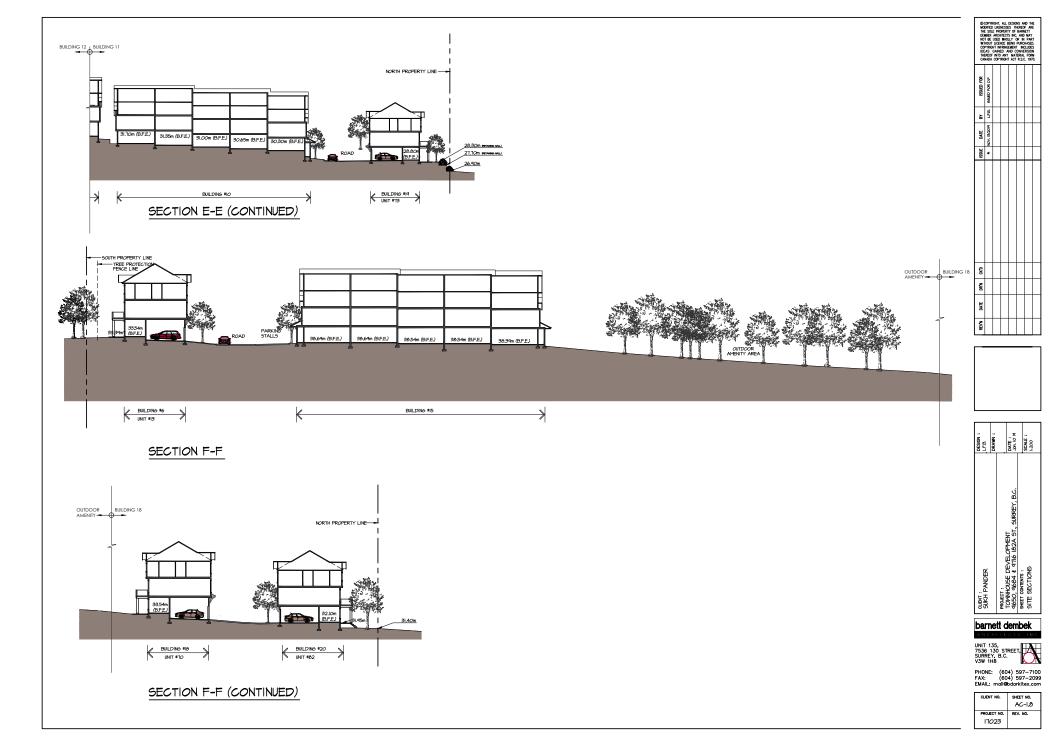

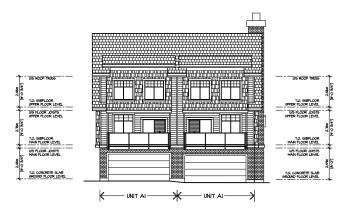

WS ROOF TRUSS


WS FLOOR JOISTS UPPER FLOOR LEVEL


T.O. SUBFLOOR MAIN FLOOR LEVEL

SOUTH ELEVATION

SCHEDULE OF FINISHES

- ASPHALT SHINGLES
- 2 PREFINISHED ALUMINUM GUTTER ON 2XIO WOOD FASCIA
- (3) FIBRE-CEMENT PLANK LAP SIDING
- (4) FIBRE-CEMENT SHINGLE SIDING
- (5) 2x6 WOOD TRIM
- 6 2x8 WOOD TRIM
- 7 2x4 ON 2X6 WOOD TRIM
- (8) VINYL FRAMED WINDOW C/W 2x6 WOOD TRIM
- (9) THRU-WALL FLASHING @ FLOORS
- PREFINISHED ALUMINUM GUARDRAIL C/W TEMPERED GLAZING PANELS (e)
- 12x12 BUILT UP COLUMN C/M FIBRE-CEMENT PANEL FINISH ON 24x24 BASE C/M FIBRE-CEMENT PLANK LAP SIDING
- (12) STRUCTURAL WOOD KNEE BRACE
- CORNER TRIM AS PER SIDING MATERIAL

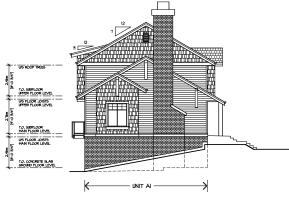

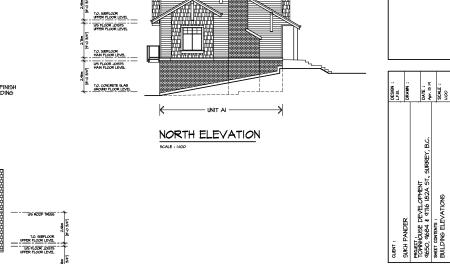

barnett dembek

PHONE: (604) 597-7100 FAX: (604) 597-2099 EMAIL: mail@bdarkitex.com


CLIENT NO. SHEET NO. AC-4.1 PROJECT NO 17023

BUILDING #1



WEST ELEVATION

5CALE : 1:100

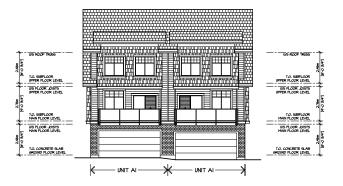

9CALE : 1:100

SCHEDULE OF FINISHES


- (I) ASPHALT SHINGLES
- 2 PREFINISHED ALUMINUM GUTTER ON 2XIO WOOD FASCIA
- (3) FIBRE-CEMENT PLANK LAP SIDING
- 4) FIBRE-CEMENT SHINGLE SIDING
- 5 2x6 WOOD TRIM
- 6 2x8 WOOD TRIM

T.O. SUBPLOOR UPPER FLOOR LEVEL


US FLOOR JOISTS UPPER FLOOR LEVEL

SOUTH ELEVATION

- (7) 2x4 ON 2X6 WOOD TRIM
- 8) VINYL FRAMED WINDOW C/W 2x6 WOOD TRIM
- (1) THRU-WALL FLASHING @ FLOORS
- PREFINISHED ALUMINUM GUARDRAIL C/W TEMPERED GLAZING PANELS
- II I2x12 BUILT UP COLUMN C/M FIBRE-CEMENT PANEL FINISH ON 24x24 BASE C/M FIBRE-CEMENT PLANK LAP SIDING
- (12) STRUCTURAL WOOD KNEE BRACE
- (3) CORNER TRIM AS PER SIDING MATERIAL

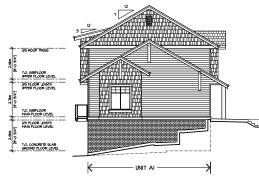



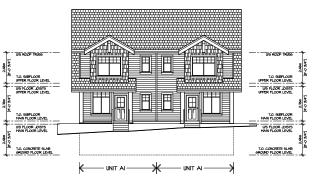

MEST ELEVATION

LE : I:IOO

barnett dembek


DESIGN: LFB. DRAWN: DATE: Apr. IS IN SCALE:

UNIT 135, 7536 130 STREET, SURREY, B.C. V3W 1H8

PHONE: (604) 597-7100 FAX: (604) 597-2099 EMAIL: mail@bdarkitex.com


CUENT NO. SHEET NO. AC-4.2

PROJECT NO. REV. NO. 17023

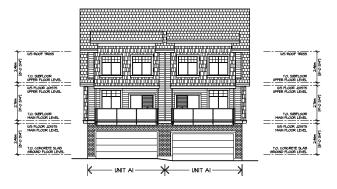

SCHEDULE OF FINISHES

- (I) ASPHALT SHINGLES
- 2) PREFINISHED ALUMINUM GUTTER ON 2XIO WOOD FASCIA
- 3 FIBRE-CEMENT PLANK LAP SIDING
- 4 FIBRE-CEMENT SHINGLE SIDING
- (5) 2x6 WOOD TRIM
- 6 2x8 WOOD TRIM
- 7 2x4 ON 2X6 WOOD TRIM
- 8 VINYL FRAMED WINDOW C/W 2x6 WOOD TRIM
- 9 THRU-WALL FLASHING @ FLOORS
- PREFINISHED ALUMINUM GUARDRAIL C/W TEMPERED GLAZING PANELS **(**
- I2xI2 BUILT UP COLUMN C/M FIBRE-CEMENT PANEL FINISH ON 24x24 BASE C/M FIBRE-CEMENT PLANK LAP SIDING (11)
- (2) STRUCTURAL WOOD KNEE BRACE
- (3) CORNER TRIM AS PER SIDING MATERIAL

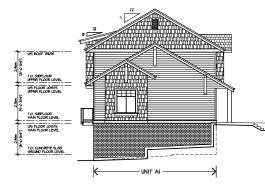

NORTH ELEVATION



SCALE : I:IOO


barnett dembek


DESIGN:
LFB.
DRAWN:
DATE:
Apr. 15 19
SCALE:
1100

PHONE: (604) 597-7100 FAX: (604) 597-2099 EMAIL: mail@bdarkitex.com

CLIENT NO. SHEET NO. AC-4.3 PROJECT NO. 17023


BUILDING #3

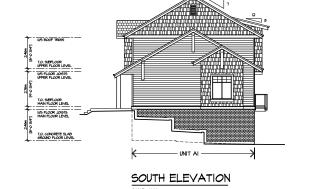


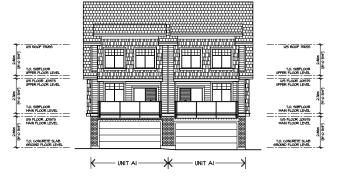

SCHEDULE OF FINISHES

- ASPHALT SHINGLES
- 2 PREFINISHED ALUMINUM GUTTER ON 2XIO WOOD FASCIA
- FIBRE-CEMENT PLANK LAP SIDING
- (4) FIBRE-CEMENT SHINGLE SIDING
- (5) 2x6 WOOD TRIM
- 6 2x8 WOOD TRIM
- 2x4 ON 2X6 WOOD TRIM
- (3) VINYL FRAMED WINDOW C/W 2x6 WOOD TRIM
- 9 THRU-WALL FLASHING @ FLOORS
- PREFINISHED ALUMINUM GUARDRAIL C/W TEMPERED GLAZING PANELS
- I2xI2 BUILT UP COLUMN C/M FIBRE-CEMENT PANEL FINISH ON 24x24 BASE C/M FIBRE-CEMENT PLANK LAP SIDING
- (12) STRUCTURAL WOOD KNEE BRACE
- (3) CORNER TRIM AS PER SIDING MATERIAL

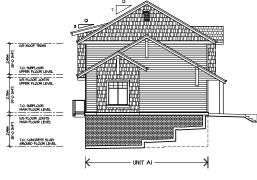

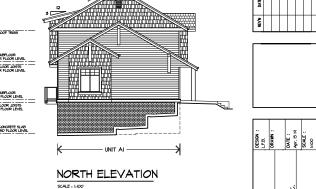



barnett dembek


ę

UNIT 135, 7536 130 STREET, SURREY, B.C. V3W 1H8


PHONE: (604) 597-7100 FAX: (604) 597-2099 EMAIL: mail@bdarkitex.com

AC-4.4 PROJECT NO. REV. NO. 17023



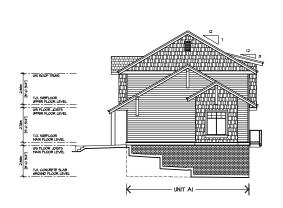

SOUTH ELEVATION

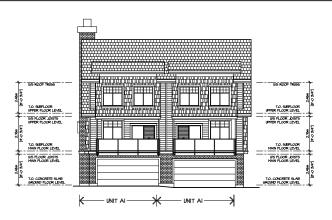

SCALE : I:IOC

INS POOF TRIES

T.O. SUBPLOOR UPPER FLOOR LEVEL

U/S FLOOR JOISTS UPPER FLOOR LEVE

T.O. SUBPLOOR MAIN PLOOR LEVEL

T.O. CONCRETE SLAB GROUND FLOOR LEVEL


SOUTH ELEVATION

SCALE : I:IOO


SCHEDULE OF FINISHES

- (I) ASPHALT SHINGLES
- 2) PREFINISHED ALUMINUM GUTTER ON 2XIO WOOD FASCIA
- 3 FIBRE-CEMENT PLANK LAP SIDING
- (4) FIBRE-CEMENT SHINGLE SIDING
- 5 2x6 WOOD TRIM
- 6 2x8 MOOD TRIM
- 7 2x4 ON 2X6 WOOD TRIM
- (8) VINYL FRAMED WINDOW C/W 2x6 WOOD TRIM
- (4) THRU-WALL FLASHING @ FLOORS
- PREFINISHED ALUMINUM GUARDRAIL
 C/M TEMPERED GLAZING PANELS
- (II) 12x12 BUILT UP COLUMN C/M FIBRE-CEMENT PANEL FINISH ON 24x24 BASE C/M FIBRE-CEMENT PLANK LAP SIDING
- (2) STRUCTURAL WOOD KNEE BRACE
- (3) CORNER TRIM AS PER SIDING MATERIAL



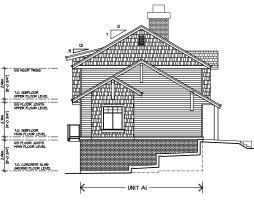

 $\underline{\text{NORTH ELEVATION}}$

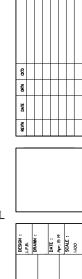

barnett dembek


UNIT 135, 7536 130 STREET, SURREY, B.C. V3W 1H8

PHONE: (604) 597-7100 FAX: (604) 597-2099 EMAIL: mail@bdarkitex.com

CUENT NO. SHEET NO. AC-4.5

PROJECT NO. REV. NO. 17023

BUILDING #5

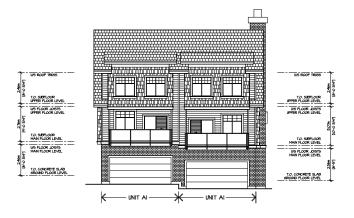

SCHEDULE OF FINISHES

- ASPHALT SHINGLES
- 2) PREFINISHED ALUMINUM GUTTER ON 2XIO WOOD FASCIA
- 3) FIBRE-CEMENT PLANK LAP SIDING
- 4) FIBRE-CEMENT SHINGLE SIDING
- (5) 2x6 WOOD TRIM

THE POOR TRIES

U/S FLOOR JOISTS UPPER FLOOR LEVEL


T.O. SUBFLOOR MAIN FLOOR LEVEL


WS FLOOR JOISTS MAIN FLOOR LEVEL

SOUTH ELEVATION

SCALE : I:100

- 6) 2x8 WOOD TRIM
- 7) 2x4 ON 2X6 WOOD TRIM
- 8) VINYL FRAMED WINDOW C/W 2x6 WOOD TRIM
- (9) THRU-WALL FLASHING & FLOORS
- PREFINISHED ALUMINUM GUARDRAIL
 C/M TEMPERED GLAZING PANELS
- (I) 12x12 BUILT UP COLUMN C/M FIBRE-CEMENT PANEL FINISH ON 24x24 BASE C/M FIBRE-CEMENT PLANK LAP SIDING
- (2) STRUCTURAL WOOD KNEE BRACE
- (E) 511001010 E 7000 110E 5100E
- (3) CORNER TRIM AS PER SIDING MATERIAL

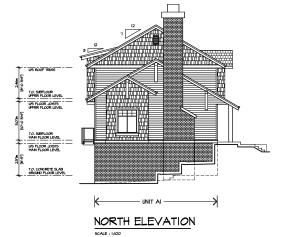

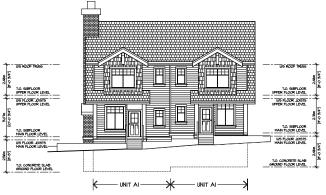

WEST ELEVATION

CALE : 1:100



DESIGN:
L.F.B.
DRAWN:
DATE:
Apr. 15 14
SCALE:

barnett dembek

UNIT 135, 7536 130 S SURREY, B.O


SURREY, B.C. V3W 1H8

PHONE: (604) 597-7100

FAX: (604) 597-2099

EMAIL: mail@bddrkitex.com

Emrile mano	o d di mitomi o di i
CLIENT NO.	SHEET NO.
	AC-4.21
PROJECT NO.	REV. NO.
17023	

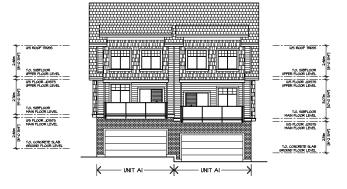

THE POOR TRIES

WS FLOOR JOISTS UPPER FLOOR LEVEL

T.O. SUBFLOOR MAIN FLOOR LEVEL

WS FLOOR JOISTS MAIN FLOOR LEVEL

T.O. CONCRETE SLAB GROUND FLOOR LEVEL


SOUTH ELEVATION

SCALE : I:100


SCHEDULE OF FINISHES

- ASPHALT SHINGLES
- 2 PREFINISHED ALUMINUM GUTTER ON 2XIO WOOD FASCIA
- 3 FIBRE-CEMENT PLANK LAP SIDING
- 4 FIBRE-CEMENT SHINGLE SIDING
- (5) 2x6 WOOD TRIM
- 6 2x8 WOOD TRIM
- 7 2x4 ON 2X6 WOOD TRIM
- (8) VINYL FRAMED WINDOW C/W 2x6 WOOD TRIM
- (9) THRU-WALL FLASHING @ FLOORS
- PREFINISHED ALUMINUM GUARDRAIL C/M TEMPERED GLAZING PANELS (o)
- 12x12 BUILT UP COLUMN C/M FIBRE-CEMENT PANEL FINISH ON 24x24 BASE C/M FIBRE-CEMENT PLANK LAP SIDING
- (12) STRUCTURAL WOOD KNEE BRACE



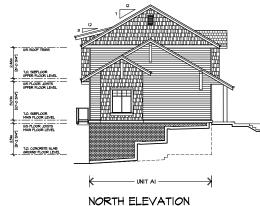

SCALE : I:100

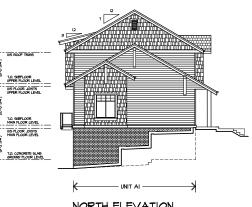

US ROOF	RRUSS COR			_	U/S ROOF TRUSS T.O. SUBPLOOR UPPER FLOOR LEVEL	2.46m (b'-0.3/4°) *
WS FLOOR UPPER FLO	OOR				WS FLOOR JOISTS UPPER FLOOR LEVEL T.O. SUBFLOOR MAIN FLOOR LEVEL	(9'-0 3/4")
WS FLOOR WS FLOOR WAN FLOO WS TO, CONCE SROUND FI	JOISTS W LEVEL				IVS FLOOR JOISTS MAIN FLOOR LEVEL T.O. CONCRETE SLAB FROUND FLOOR LEVEL	2.46m 4
	 	UNIT AI	WUNIT AI	—		


WEST ELEVATION

barnett dembek

DESIGN:
LIFB.
DRAWN:
DATE:
Apr. IS I4
SCALE:

DEVELOPMENT

CLIENT NO.	SHEET NO. AC-4.22
PROJECT NO.	REV. NO.
17023	

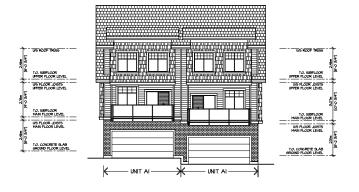

EAST ELEVATION SCALE : MICO

T.O. SUBFLOOR UPPER FLOOR LEVEL


WS FLOOR JOISTS UPPER FLOOR LEVEL

T.O. SUBFLOOR MAIN FLOOR LEVEL

SOUTH ELEVATION

SCHEDULE OF FINISHES

- (I) ASPHALT SHINGLES
- 2) PREFINISHED ALUMINUM GUTTER ON 2XIO WOOD FASCIA
- (3) FIBRE-CEMENT PLANK LAP SIDING
- 4 FIBRE-CEMENT SHINGLE SIDING
- (5) 2x6 WOOD TRIM
- 6 2x8 WOOD TRIM
- 7 2x4 ON 2X6 WOOD TRIM
- (8) VINYL FRAMED WINDOW C/W 2x6 WOOD TRIM
- (9) THRU-WALL FLASHING @ FLOORS
- PREFINISHED ALUMINUM GUARDRAIL C/W TEMPERED GLAZING PANELS (e)
- I2xI2 BUILT UP COLUMN C/M FIBRE-CEMENT PANEL FINISH ON 24x24 BASE C/M FIBRE-CEMENT PLANK LAP SIDING (11)
- (2) STRUCTURAL WOOD KNEE BRACE
- CORNER TRIM AS PER SIDING MATERIAL

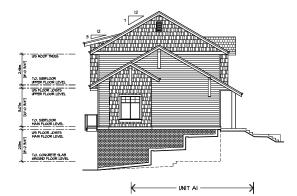


SCALE : I:100

NORTH ELEVATION




WEST ELEVATION

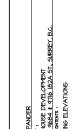

DESIGN:
LF.B.
DRAWN:
DATE:
Apr. IS IQ
SCALE:

barnett dembek

CLIENT NO.	SHEET NO. AC-4.23
PROJECT NO.	REV. NO.
17023	

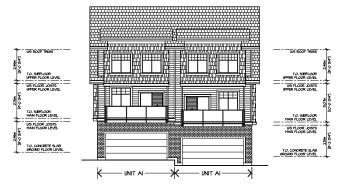

SCALE - I-IO

ILIS POOF TRIBS

T.O. SUBFLOOR UPPER FLOOR LEVEL


UNIT AI -

SOUTH ELEVATION

WS FLOOR JOISTS UPPER FLOOR LEVE

SCHEDULE OF FINISHES

- (I) ASPHALT SHINGLES
- 2) PREFINISHED ALUMINUM GUTTER ON 2XIO WOOD FASCIA
- 3 FIBRE-CEMENT PLANK LAP SIDING
- 4 FIBRE-CEMENT SHINGLE SIDING
- 5) 2x6 WOOD TRIM
- 6 2x8 WOOD TRIM
- (7) 2x4 ON 2X6 WOOD TRIM
- (8) VINYL FRAMED WINDOW C/W 2x6 WOOD TRIM
- (9) THRU-WALL FLASHING @ FLOORS
- PREFINISHED ALUMINUM GUARDRAIL
 C/M TEMPERED GLAZING PANELS
- II I2xi2 BUILT UP COLUMN C/M FIBRE-CEMENT PANEL FINISH ON 24x24 BASE C/M FIBRE-CEMENT PLANK LAP SIDING
- (2) STRUCTURAL WOOD KNEE BRACE
- (3) CORNER TRIM AS PER SIDING MATERIAL

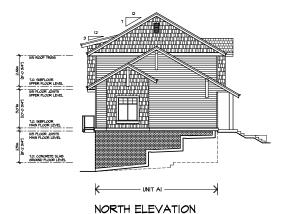

SCALE : 1:100





barnett dembek

DESIGN:
L.F.B.
DRAWN:
DATE:
Apr. IS 19
SCALE:

UNIT 135, 7536 130 SURREY, B V3W 1H8


CLIENT NO.	SHEET NO. AC-4.24
PROJECT NO.	REV. NO.
17023	

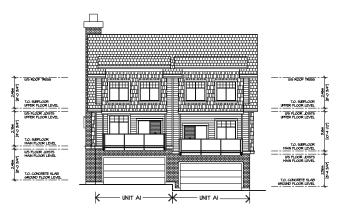


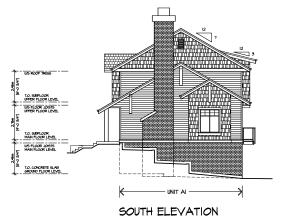

SCHEDULE OF FINISHES

- ASPHALT SHINGLES
- PREFINISHED ALUMINUM GUTTER ON 2XIO WOOD FASCIA
- FIBRE-CEMENT PLANK LAP SIDING
- FIBRE-CEMENT SHINGLE SIDING
- (5) 2x6 WOOD TRIM
- 6 2x8 WOOD TRIM
- 2x4 ON 2X6 WOOD TRIM
- VINYL FRAMED WINDOW C/W 2x6 WOOD TRIM
- **a** THRU-WALL FLASHING @ FLOORS
- PREFINISHED ALUMINUM GUARDRAIL C/W TEMPERED GLAZING PANELS
- I2xI2 BUILT UP COLUMN C/M FIBRE-CEMENT PANEL FINISH ON 24x24 BASE C/M FIBRE-CEMENT PLANK LAP SIDING
- STRUCTURAL WOOD KNEE BRACE
- CORNER TRIM AS PER SIDING MATERIAL

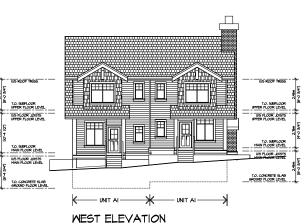

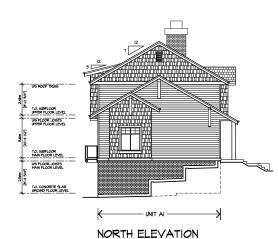

SCALE : I+IOO



SSUE

EN.

barnett dembek



PHONE: (604) 597-7100 FAX: (604) 597-2099 EMAIL: mail@bdarkitex.com

CLIENT NO. SHEET NO. AC-4.25 PROJECT NO 17023

BUILDING #25

PLANT SCHEDULE PMG PROJECT NUMBER: 18-235 COMMON NAME PLANTED SIZE / REMARKS VINE MAPLE 6CM CAL., 2.5M HT: B&B ACER PALMATUM 'OSAKAZUKI JAPANESE MAPLE 6CM CAL; 2M HT; B&B ACED DUBDUM ADMSTDONG COLLIMNAD ADMSTDONIC MADLE SCM CAL: 2M STD: B&B 6CM CAL; 2M STD; B&B 6CM CAL; 1.8M STD; B&B 5CM CAL; 1.8M HT; B&B CERCIDIPHYLLUM JAPONICUM KATSURA TREE CORNUS MAS FAGUS SYLVATICA 'DAWYCK GOLD' CORNELIAN CHERRY DAWYCK GOLD BEECH 6CM CAL; 1.8M STD; B&B MAGNOLIA KOBUS STELLATA 'ROYAL STAR' ROYAL STAR MAGNOLIA (WHITE) 2M HT: B&B :STD PICEA ABIES 'CUPRESSINA COLUMNAR NORWAY SPRUCE 2.5M HT: B&B PICEA OMORIKA 'BRUNS' BRUNS SERBIAN SPRUCE 2.5M HT; B&B PRUNUS CERASIFERA PRUNUS YEDOENSIS 'AKEBONO' SLUM CHERRY 6CM CAL; 1.5M STD; B&B 6CM CAL: 1.5M STD: B&B DAYBREAK CHERRY

NOTES: "F. ANT BIZES IN THIS LIST ARE SPECIFIED ACCORDING TO THE DE LANGGOME STANDARD, AND CAMADIAL LANGGOME STANDARD, STEET TO THE CONTRIBUTION OF THE CONTRIBUTION O

NOTES: SEE CIVIL DRAWINGS FOR SUBSURFACE DRAINAGE OF STRUCTURAL SOIL. DRAINAGE AND INSTALLATION OF PERMEABLE PAVERS.



Copyright reserved. This drawing and design is the property of PMG Landscape Architects and may not be reproduced or used for other projects without their projects.



SEA

8	20.0CT.21	BLDG GRADES	
7	20.JUL.13	NEW SITE PLAN, COORDINATION	
6	20.JUL.02	NEW SITE / GRADING	
5	19.NOV.05	SITE PLAN COORDINATION	
4	19.OCT.23	NEW SITE PLAN, COORDINATION	
3	19.5EP.25	REVISE PER COMMENTS	
2	19.5EP.09	ADDING TWO BIKE RACKS	
1	19.MAY.01	NEW SITE / GRADING	
NO.	DATE	REVISION DESCRIPTION	-

CLIENT

PROJECT:

TOWNHOUSE DEVELOPMENT

9650, 9684 & 9716 182A ST., SURREY, B.C.

DRAWING TITLE:

LANDSCAPE PLAN

ATE:	19.JAN.30	DRAWING NUMBE
CALE:	1:300	
RAWN:	YR	L1
ESIGN:		
HKD:	MCY	OF 1

PMG PROJECT NUMBER:

18-235



INTER-OFFICE MEMO

TO: Manager, Area Planning & Development

- North Surrey Division

Planning and Development Department

FROM: Development Services Manager, Engineering Department

DATE: October 19, 2020 PROJECT FILE: 7818-0251-00

RE: Engineering Requirements

Location: 9650/9684/9716 182A Street

OCP AMENDMENT AND NCP AMENDMENT

There are no engineering additional engineering requirements relative to the OCP and NCP Amendments beyond those mentioned below.

REZONE/SUBDIVISION

Property and Right-of-Way Requirements

• Provide a 0.5m Statutory Right-of-Way along 182A Street.

Works and Services

- Construct the east side of 182A Street to the through local road standard.
- Construct a 7.3m wide concrete driveway letdown.
- Provide water, storm, and sanitary service connections along 182A Street.
- Provide an acceptable drainage strategy to service the site.
- Construct on-lot stormwater management features as required.
- Provide hydrological and geotechnical studies.
- Obtain all necessary Environmental and third-party approvals.
- Register applicable restrictive covenants as determined through detailed design.
- Pay all applicable charges against the property.

A Servicing Agreement is required prior to Rezone.

DEVELOPMENT PERMIT

There are no additional engineering requirements relative to issuance of the Development Permit beyond those mentioned above.

Tommy Buchmann, P.Eng.

Development Services Manager

CE₄



June 9, 2020

Planning

THE IMPACT ON SCHOOLS

APPLICATION #: 18 0251 00

SUMMARY

The proposed 94 townhouse units are estimated to have the following impact on the following schools:

Projected # of students for this development:

Elementary Students:	24
Secondary Students:	12

September 2019 Enrolment/School Capacity


School Enrolment Projections and Planning Update:

The following tables illustrate the enrolment projections (with current/approved ministry capacity) for the elementary and secondary schools serving the proposed development.


Bothwell Elementary 10 year enrolment projections show a growth trend that can be attributed to the increased density being considered along the bluff to the east of Highway 17 (South Fraser Perimeter Road). With Highway 17 dissecting the Bothwell catchment, as part of the District's 2020/2021 Capital Plan submission to the Ministry, the District is requesting to purchase a new site in the new Abbey Ridge area in the next 5 years: followed by, building a new elementary school sometime around 2028. There has been no Ministry funding approval for these project. Until then, enrolment growth at Bothwell elementary will be accommodated by portables.

Fraser Heights Secondary is currently operating at 114% capacity. The school's 10 year projections show enrolment to continue to grow as the Bothwell and Abbey Ridge communities continue to build out. As a result, the District has requested as part of their 2020/2021 Capital Plan submission to the Ministry a 300 capacity addition for the school, targeted to open in 2024. There has been no Ministry funding approval for this project.

Bothwell Elementary

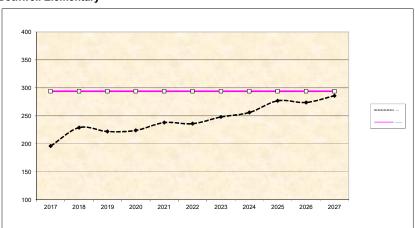


Fraser Heights Secondary

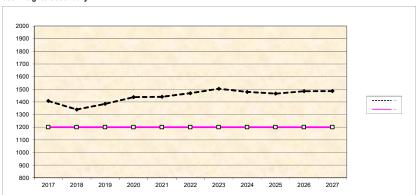

^{*} Nominal Capacity is estimated by multiplying the number of enrolling spaces by 25 students.

Maximum operating capacity is estimated by multipying the number of enrolling spaces by 27 students.

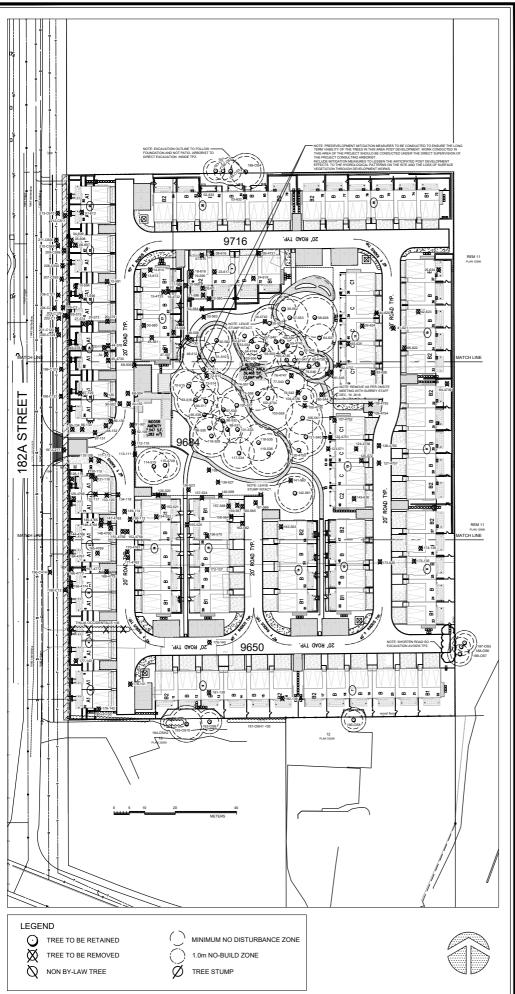

APPENDIX IV

MIKE FADUM AND ASSOCIATES LTD. **VEGETATION CONSULTANTS**

Surrey, British Columbia V3W 0A6 Ph: (778) 593-0300 Fax: (778) 593-0302

Email: mfadum@fadum.ca

#105, 8277 129 St.

FILE NO.

PROJECT TITLE TREE PRESERVATION AND PROTECTION PLAN

9716, 9684, 9650 182A STREET SURREY, B.C.

REVISIONS:			
NO.	DATE	BY	REVISION
1	JUN11/18	MK	SITE PLAN
2	JUN20/18	MK	SITE PLAN
3	JUN28/18	MK	SITE PLAN
4	SEPT13/18	MK	SITE PLAN
5	JAN07/19	MK	SITE PLAN
6	JAN11/19	MK	SITE PLAN
7	FEB01/19	MK	SITE PLAN
8	MAY02/19	MK	SITE & GRADING PLAN
9	JUL30/19	MK	SITE PLAN
10	SEPT18/19	MK	SITE PLAN
11	SEPT27/19	MK	SITE PLAN
12	OCT16/19	MK	SITE PLAN
13	MAR26/20	MK	SITE PLAN

- INDIVIDUAL TREE REMOVAL OR CANOPY MODIFICATIONS MAY BE REQUIRED FROM WITHIN TREE RETENTION GROUP.

 GENERAL NOTES:

 STUMPS TO REMAIN IN GROUND AT TIME OF TREE REMOVAL.

 A GGREGATE / WOOD MULCH PATH TO BE CONSTRUCTED ABOVE GRADE WITHOUT EXCAVATION, NO GRUBBING OR COMPACTION INSIDE THE TPZ AND NOT TO ALTER SITE HYDROLOGICAL CHANGES.

 CONSTRUCT WALKWAYS ABOVE GRADE WITH OF EXCAVATION INSIDE THE TPZ AND CONSTRUCTION MAY BE RECESSARY TO MISSIDE THE TREE ALIGNMENT CHANGES AT TIME OF CONSTRUCTION MAY BE RECESSARY TO MISSIDE THE TREE ALIGNMENT CHANGES AT TIME OF CONSTRUCTION MAY BE RECESSARY TO MISSIDE THE TREE ON THE TREE OF THE TREE ON THE TREE ON THE TREE ON THE TREE ON THE TREE OF THE TREE ALIGNMENT CHANGES AT TIME OF CONSTRUCTION METHOD MUST BE DIDENTIFIED IN FIELD BY THE LA AND PROJECT ARROPHIST.

 ALL BENCHES TO BE LOCATED OUTSIDE TYPZS.

 NO MACHINERY IS PERMITTED INSIDE THE TREE RETENTION ARE TREET TREED.

SHEET TITLE

KEY - TREE PRESERVATION AND PROTECTION PLAN

© Copyright Reserved. This drawing and design is the property of Mike Fadum and Associates Ltd. and may not be reproduced or used for other projects without their permission.

DRAWN


SGL


AS SHOWN

DATE


JANUARY 02, 2018



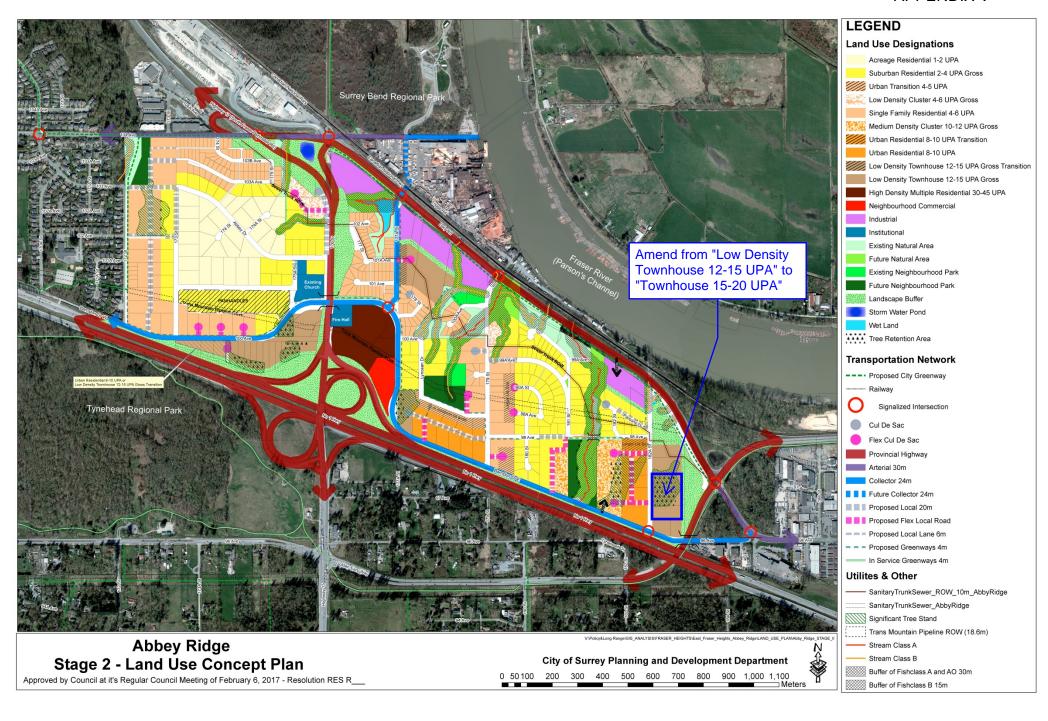

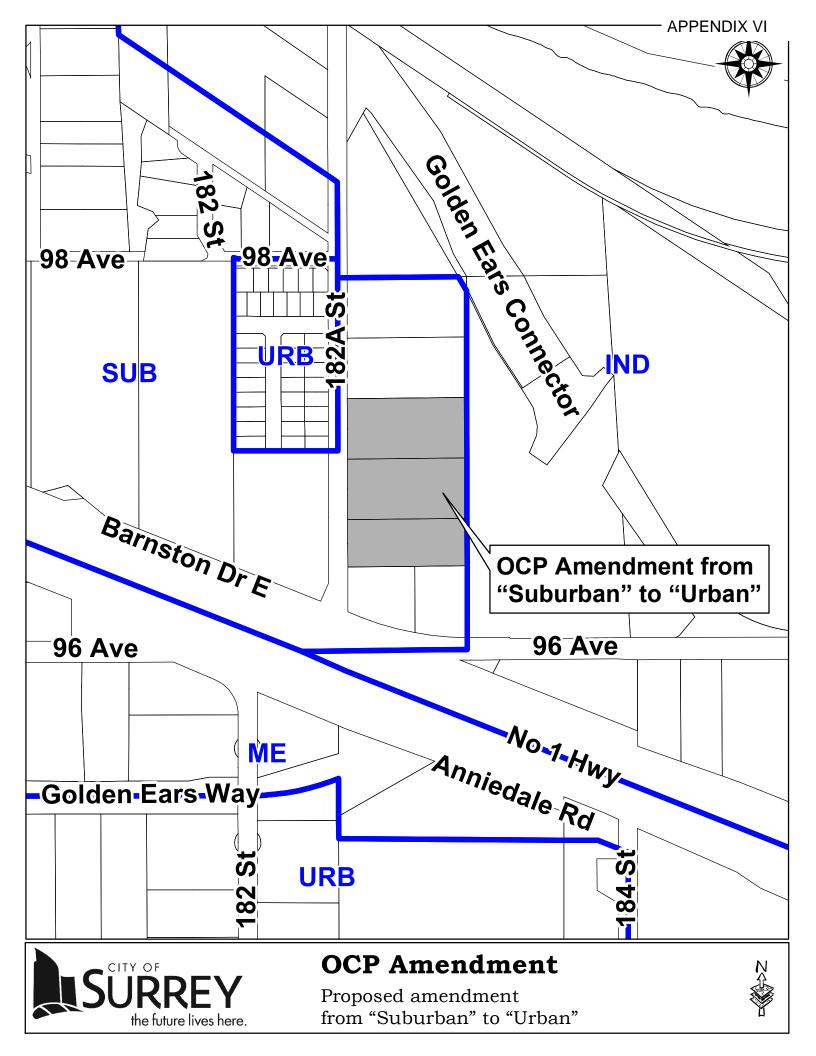



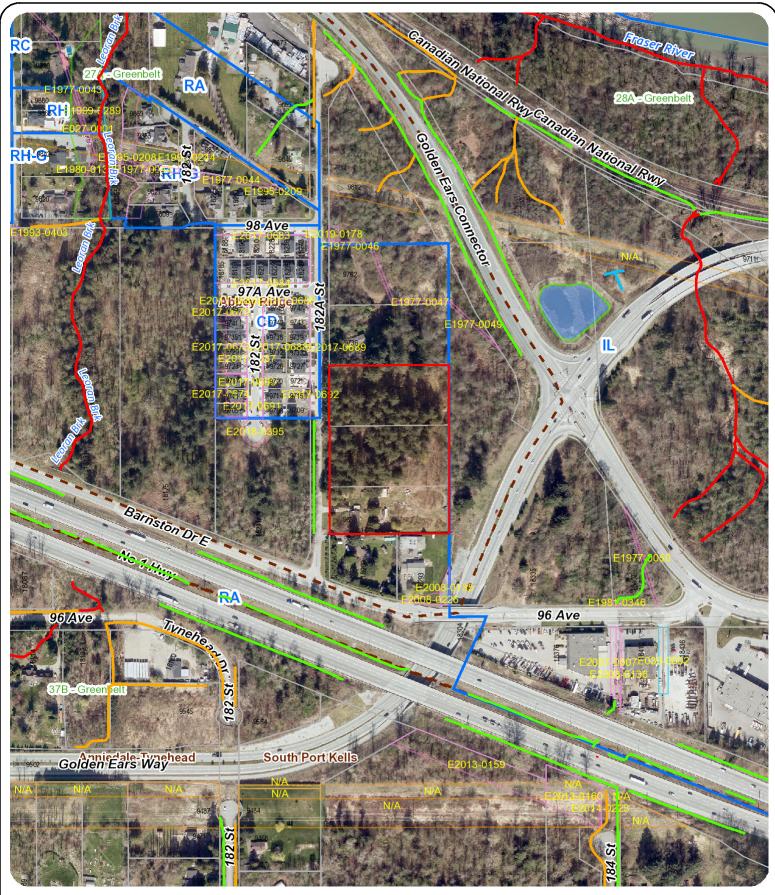

Enter Map Description

Scale: 1:3,994

®

0.025 0.05 0.