

# City of Surrey ADDITIONAL PLANNING COMMENTS #2 Application No.: 7919-0017-00

Planning Report Date: December 4, 2023

#### **PROPOSAL:**

• Development Permit

• Development Variance Permit


to address parking requirements, including proposed off-site surface parking lots, and to increase allowable building height to permit already constructed and proposed additions and modifications to an existing banquet hall.

LOCATION: 12333 - Pattullo Place

12350 - Pattullo Place 12345 - Pattullo Place

ZONING: CHI

OCP DESIGNATION: Mixed Employment NCP DESIGNATION: Highway Commercial

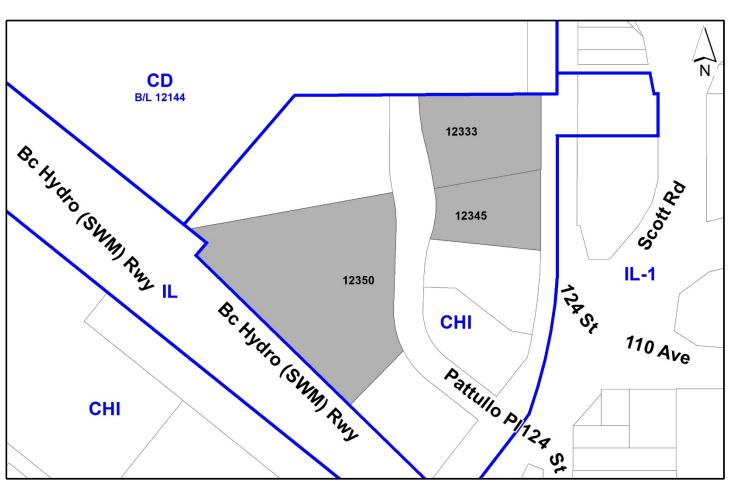

#### **RECOMMENDATION SUMMARY**

- Approval to draft an amended Development Permit for Form and Character.
- Approval for an amended Development Variance Permit to proceed to Public Notification.

# DEVIATION FROM PLANS, POLICIES OR REGULATIONS

- The applicant is seeking the following variances in order to address parking requirements and building height for an existing operational banquet hall:
  - o to reduce the minimum number of off-street parking spaces required for an eating establishment (banquet hall) from 650 to 430;
  - to allow for parking spaces for the banquet hall use located at 12350 Pattullo Place to be provide on non-abutting or contiguous lots located at 12333 and 12345 Pattullo Place; and
  - o to increase the allowable building height from 9 metres to 14.1 metres to accommodate the banquet hall building.

#### RATIONALE OF RECOMMENDATION

- Council initially considered the subject Development Permit and Development Variance Permit (DVP) application at the July 11, 2022 Regular Council Land Use Meeting. At that time, the applicant was proposing the following variances:
  - o to reduce the minimum number of off-street parking spaces required for an eating establishment (banquet hall) from 650 to 430;
  - to allow for parking spaces for the banquet hall use located at 12350 Pattullo Place to be provide on non-abutting or contiguous lots located at 12333 and 12345 Pattullo Place; and
  - o to allow the proposed surface parking lots at 12333 and 12345 Pattullo Place to be surfaced with gravel.
- The requested variances are to address parking requirements for the existing operational banquet hall (Aria Convention Centre).
- After Public Notification, the variances were supported by Council on July 25, 2022.
- Subsequently, the applicant requested that the DVP be amended to further relax the required parking spaces from 695 to 420 and to increase the allowable building height under the CHI Zone. Council referred the revised proposal back to staff for an updated parking study.

- After the referral back to staff, the applicant elected to reduce the building/outdoor patio floor area of the banquet hall and adjusted the parking layout to match the previously supported parking variance of 650 to 430 parking stalls.
- Staff therefore presented the original DVP to Council for consideration of issuance at the November 20, 2023, Regular Council Public Hearing meeting. At that meeting Council raised concerns about the current unsightly condition of the overflow gravel parking lot and referred the proposal back to staff to require the applicant to pave the lot and paint the lines to delineate the parking stalls.
- The applicant is agreeable to Council's request to pave the parking lot and paint the lines to
  delineate the spaces. This will improve the aesthetic of the parking lot and provide a more
  comfortable parking experience for banquet hall patrons.
- Council is therefore requested to consider supporting a modified variance, without the initial request for a gravel surface, and only including the following:
  - o to reduce the minimum number of off-street parking spaces required for an eating establishment (banquet hall) from 650 to 430;
  - to allow for parking spaces for the banquet hall use located at 12350 Pattullo Place to be provide on non-abutting or contiguous lots located at 12333 and 12345 Pattullo Place; and
  - o to increase the allowable building height from 9 metres to 14.1 metres to accommodate the banquet hall building.
- The applicant has prepared an engineered drawing illustrating the proposed improvements to the parking lot. Staff are currently in conversation with the applicant's engineer and paving contractor to confirm whether it is appropriate to pave the lot in the winter months. It may be better to wait until the spring when the weather is warmer to ensure the successful application of the asphalt and long term durability of the paving surface. The applicant is agreeable to the City retaining a cash security, based on the estimated cost of the work, to ensure the completion of the works should it be confirmed that waiting until the spring is the most practical option.
- The subject banquet hall building is in an employment area and is situated in the centre of the property with surrounding parking and landscaping. The increased height of the building is not anticipated to impact surrounding properties.
- The amended Development Variance Permit and Development Permit will authorize exterior renovations to the existing banquet hall building previously completed without permits and accommodate the further additions to the banquet hall as proposed by the applicant.

#### RECOMMENDATION

The Planning & Development Department recommends that:

- 1. Council approve an amended Development Variance Permit No. 7919-0017-00 (Appendix II) varying the following, to proceed to Public Notification:
  - (a) to reduce the minimum number of off-street parking spaces required for an eating establishment (banquet hall) from 650 to 430;
  - (b) to allow for parking spaces for the banquet hall use located at 12350 Pattullo Place to be provide on non-abutting or contiguous lots located at 12333 and 12345 Pattullo Place; and
  - (c) to increase the allowable building height, under the CHI Zone, from 9 metres to 14.1 metres to accommodate the banquet hall building.
- 2. Council authorize staff to draft amended Development Permit No. 7919-0017-00 generally in accordance with the updated site plan and elevations attached as Appendix I.
- 3. Council instruct staff to resolve the following issues prior to final adoption:
  - (a) either completion of the paving and line painting work for the overflow parking lot or the applicant to provide cash security to ensure that the paving and line painting works are completed in the spring 2024, to the satisfaction of the General Manager, Planning and Development; and
  - (b) completion of all conditions of approval identified in the original Planning Report for Development Application No. 7919-0017-00 dated July 11, 2022.

#### **SITE CONTEXT & BACKGROUND**

Direction	Existing Use	NCP Designation	Existing Zone
Subject Site	Aria Convention Centre and vacant	Highway Commercial, Parks	СНІ
North:	gravel lots Highway	and Open Spaces Highway	CHI and CD
	commercial uses and parking for	commercial uses and parking for	Bylaw 12144
	large multi- purpose building	large multi-purpose building	

Direction	Existing Use	NCP Designation	<b>Existing Zone</b>
East (Across 124 Street):	Autobody repair, used car dealership	Highway Commercial	IL-1, CHI
Southeast:	Highway commercial uses	Highway Commercial	СНІ
West (Across BC Hydro (SWM) Railway):	Proposed two- storey industrial warehouse building with upper floor office space. Supported by Council on January 25, 2021.	Business/Residential Park	IL-1

# Context & Background

- The three subject sites, 12333, 12345 and 12350 Pattullo Place, are either adjacent or directly encumbered by a TransLink Skytrain guideway. The sites are designated Mixed Employment in the Official Community Plan (OCP) and Highway Commercial in the South Westminster Neighbourhood Concept Plan (NCP). The sites are currently zoned Highway Commercial Industrial Zone (CHI).
- Council initially considered the subject Development Permit and Development Variance Permit (DVP) application at the July 11, 2022 Regular Council Land Use Meeting. At that time, the applicant was proposing the following variances:
  - o to reduce the minimum number of off-street parking spaces required for an eating establishment (banquet hall) from 650 to 430;
  - o to allow for parking spaces for the banquet hall use located at 12350 Pattullo Place to be provide on non-abutting or contiguous lots located at 12333 and 12345 Pattullo Place; and
  - o to allow the proposed surface parking lots at 12333 and 12345 Pattullo Place to be surfaced with gravel.
- The requested variances are to address parking requirements for the existing operational banquet hall (Aria Convention Centre).
- After Public Notification, the variances were supported by Council on July 25, 2022.
- Subsequently, the applicant advised City staff that the previous building and parking calculations were incorrect. As such, the applicant requested that the DVP be amended to further relax the required parking spaces from 695 to 420 and to increase the allowable building height under the CHI Zone.

- Council referred the revised proposal back to staff, noting a requirement to update the associated parking study.
- After the referral back to staff, the applicant elected to reduce the building/outdoor patio floor area of the banquet hall and adjusted the parking layout to match the previously supported parking variance of 650 to 430 parking stalls.
- Staff therefore presented the original DVP to Council for consideration of issuance at the November 20, 2023, Regular Council Public Hearing meeting. At that meeting Council raised concerns about the current unsightly condition of the overflow gravel parking lot and referred the proposal back to staff to require the applicant to pave the lot and paint the lines to delineate the parking stalls.

#### **DEVELOPMENT PROPOSAL**

#### **Planning Considerations**

- The applicant is agreeable to Council's request to pave the parking lot and paint the lines to delineate the spaces. This will improve the aesthetic of the parking lot and provide a more comfortable parking experience for banquet hall patrons.
- Council is therefore requested to consider supporting a modified variance, without the initial request for a gravel surface, and only including the following:
  - o to reduce the minimum number of off-street parking spaces required for an eating establishment (banquet hall) from 650 to 430;
  - o to allow for parking spaces for the banquet hall use located at 12350 Pattullo Place to be provide on non-abutting or contiguous lots located at 12333 and 12345 Pattullo Place; and
  - o to increase the allowable building height from 9 metres to 14.1 metres to accommodate the banquet hall building.
- The applicant has prepared an engineered drawing illustrating the proposed improvements to the parking lot. Staff are currently in conversation with the applicant's engineer and paving contractor to confirm whether it is appropriate to pave the lot in the winter months. It may be better to wait until the spring when the weather is warmer to ensure the successful application of the asphalt and long term durability of the paving surface. The applicant is agreeable to the City retaining a cash security, based on the estimated value of the work, to ensure the completion of the works should it be confirmed that waiting until the spring is the most practical option.
- The subject banquet hall building is in an employment area and is situated in the centre of the property with surrounding parking and landscaping. The increased height of the building is not anticipated to impact surrounding properties.

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#### Referrals

Engineering: The Engineering Department has no objection to the project as

outlined in the original Engineering Review.

Ministry of Transportation

& Infrastructure (MOTI):

Ministry of Transportation & Infrastructure has no objections.

Surrey Fire Department: The Surrey Fire Department has no objections.

Translink: TransLink has no objections, subject to a construction

management plan for works adjacent to the SkyTrain guideway.

#### **POLICY & BY-LAW CONSIDERATIONS**

## **Regional Growth Strategy**

• The subject site is designated "General Urban" under the Metro Vancouver Regional Growth Strategy (RGS). The existing use complies with the RGS designation.

#### Official Community Plan

#### **Land Use Designation**

• The subject site is designated "Mixed Employment" in the Official Community Plan (OCP). The existing use complies with the OCP designation.

# **Secondary Plans**

#### Land Use Designation

• The existing use complies with the "Highway Commercial" Designation in the South Westminster Neighborhood Concept Plan (NCP).

#### Variances

- The applicant is requesting the following variances, based on the revised proposal:
  - o to reduce the minimum number of off-street parking spaces required for an eating establishment (banquet hall) from 650 to 430;
  - to allow for parking spaces for the banquet hall use located at 12350 Pattullo Place to be provide on non-abutting or contiguous lots located at 12333 and 12345 Pattullo Place; and
  - o to increase the allowable building height for the banquet hall building, under the CHI Zone, from 9 metres to 14.1 metres.

- The applicant previously retained a Transportation Consultant (Binnie Engineering) to
  prepare a parking study for the site. The study included three site visits during various events
  at the banquet hall. The study observed a maximum parking demand of 371 parking spaces
  and therefore concluded that the proposed 430 parking spaces will be sufficient to
  accommodate the banquet hall operations.
- In addition to the 430 parking spaces available on the subject properties, there are approximately 20 on-street parking spaces available on the west site of Pattullo Place and a pay parking lot just north of the site at 11125-124 Street that accommodates a further 97 parking spaces. In addition, the applicant has also entered into an agreement with an adjacent property owner to allow vehicles for banquet hall patrons to park in the 26 spaces available at 12355 Pattullo Place after 6:30 pm.
- City staff also reviewed the proposed parking supply and support the proposed parking reduction. Staff note the following rationale in support of the variance:
  - The proposed patio area will not be a fully enclosed/covered and is located away from the main assembly/seating area, so the space is supplementary and not expected to generate parking demand;
  - A portion of the banquet hall (100 sq. m) is reserved for storing a large inventory of furniture and supplies to operate;
  - o The building contains a caretaker suite with 3 bedrooms, which will be parked at the same rate as ground oriented multi-family developments in the City (2 spaces total);
  - The site is in close proximity to Scott Road Skytrain station (approximately 300 m) which results in some guests and staff utilizing transit to attend events;
  - Given the proximity of the subject property to the Frequent Transit Network (FTN), including Scott Road SkyTrain Station, an additional 10% reduction in the rate used to calculate the required parking for the banquet hall use has merit;
  - Given the nature of the events and guest arrival patterns at this banquet hall, there is a higher proportion of carpooling/high-occupancy vehicles and new mobility services like ride hailing; and
  - There's currently on-street parking available fronting and adjacent the subject site, with low parking demand on evening and weekends (industrial and commercial uses adjacent), so some overflow can be accommodated on the street, without disruption to residents.
- The Zoning By-law requires that all off-street parking areas must be graded and drained so as
  to properly dispose of all surface water; as determined by the City; and surfaced with an
  asphalt, concrete, or similar pavement so as to provide a surface that is dust-free. The
  applicant is agreeable to paving the overflow parking lot in accordance with Council's
  direction.

- The subject banquet hall building is in an employment area and is situated in the centre of the property with surrounding parking and landscaping. The increased height of the building is not anticipated to impact surrounding properties.
- Staff support the proposed variances.

# **DEVELOPMENT PERMITS**

# Form and Character Development Permit Requirement

- Since the subject application was originally presented to Council, the general form & character of the building remains relatively unchanged.
- The existing banquet hall building has its main entrance along the street. The design incorporates elements that create a sense of entry with corrugated metal cladding and coloured hardi panel (arctic white, evening blue, pearl gray).
- The amended Development Permit will authorize exterior renovations to the existing banquet hall building previously completed without permits and accommodate the further additions to the banquet hall as proposed by the applicant.

#### INFORMATION ATTACHED TO THIS REPORT

The following information is attached to this Report:

Appendix I. Site Plan, Building Elevations and Perspective

Appendix II. Amended Development Variance Permit No. 7919-0017-00 Appendix III. Initial Planning Report No. 7919-0017-00, July 11, 2022

Appendix IV. Additional Planning Comments Report No. 7919-0017-00, September 11, 2023

approved by Ron Gill

Don Luymes General Manager Planning and Development

EM/ar

#### Drawing List

DRAWING TITLE DWG. NO.

Architectural

Sheet Number	Sheet Name
A0.1	CONTEXT PLAN
A0.2	MASTER PARKING PLAN
A0.2.1	ON-SITE PARKING PLAN
A0.2.2	OFF-SITE PARKING PLAN
A0.3	SURVEY PLAN
A0.4	GRADING PLAN
A0.5	LEASE PARKING PLAN
A0.6	ZONING SYNOPSIS AND BUILDING CODE
A1.1	BUILDING SITE PLAN
A1.2	BUILDING FIRST FLOOR PLAN
A1.3	BUILDING MEZZANINE/ SECOND FLOOR PLAN
A1.4	BUILDING ROOF PLAN
A2,1	BUILDING ELEVATIONS
A3.1	BUILDING SECTIONS
A4,1	STORAGE ADDITION PLANS
A4.2	STORAGE ADDITION ELEVATIONS
A4.3	STORAGE ADDITION ELEVATIONS
A4.4	STORAGE ADDITION SECTIONS
A4.5	STORAGE ADDITION SECTIONS
A4.6	STORAGE ADDITION DETAIL PLANS
A4.7	STORAGE ADDITION STAIR PLANS
A4.8	STORAGE ADDITION STAIR #4 SECTIONS
A4.9	STORAGE ADDITION STAIR #5 SECTIONS
A4.10	STORAGE ADDITION ENTRY STAIR DETAILS
A4.11	STORAGE ADDITION WALL SECTION DETAILS
A4.12	STORAGE ADDITION DETAILS
A4.13	STORAGE ADDITION HVAC DETAILS
A5.1	PATIO/ SERVERY PLAN
A5.2	PATIO/ SERVERY DETAILS
A6.1	REFUSE ENCLOSURE
A7,1	CONSTRUCTION ASSEMBLIES
A7.2	DOOR SCHEDULE

DRAWING TITLE DWG. NO.

STRUCTURAL

S-1 GENERAL NOTES
S-2 FOUNDATION PLAN
S-3 FRAMING PLANS
S-4 SECTIONS
S-5 BRACE ELEVATIONS

DWG. NO. DRAWING TITLE

ELECTRICAL

STEPLAN
POWER DISTRIBUTION
GOSTION THE PROPERTY OF STATES

GOSTION THE STATES
GOSTION OF STATES
GOSTION OF STATES
GOSTION OF STATES
FULL THOOR PLAN
- ROCKNOWN FLOOR
FULL TOOR PLAN
- ROCKNOWN

DRAWING TITLE DWG, NO.

MECHANICAL

SITE PLAN
FOUNDATION & GROUND FLOOR PLAN PLUMBING
SECOND FLOOR AND ROOF PLAN PLUMBING'
GROUND FLOOR PLAN, SECOND & ROOF PLAN HVAC
DETAIL & EQUIPMENT LIST
SPECIFICATIONS

DWG. NO. DRAWING TITLE

SPRINKLER

BUILDING ADDITION FIRE PROTECTION NEW STORAGE AREA FIRE PROTECTION

DRAWING TITLE DWG. NO.


Survey

TOPOGRAPHIC PLAN

DWG. NO. DRAWING TITLE

CIVIL

GRADING PLAN

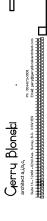



# **ARIA BANQUET HALL & CONVENTION CENTRE**

STORAGE ADDITION

12350 PATULLO PLACE SURREY, BC

GERRY BLONSKI ARCHITECT SUITE 1A- 12468 - 82 AVE., SURREY, B.C. V3W 3E9 TEL: (604) 889 3264 EMAİL: parmoanghera1@gmail.com TEL: (604) 572 3608 EMAL: gerry@gerryblonskiarchitect.com CONTACT: Gerry Blonski, a j.b.c. LONDON MAH & ASSOCIATES #103-1847 W BROADWAY VANCOUVER, B.C. V6J 1Y6

TEL: (604) 739 8544 EMAL: londonmah@telus.net CONTACT: Jim Mah

SRC ENGINEERING CONSULTANTS

TEL: (604) 268 9091 EMAIL: bill@src-eng.com CONTACT: Bill Khangura

SRC ENGINEERING CONSULTANTS #205-4180 LOUGHEED HWY BURNABY, B.C. V5C 347

TEL: (604) 268 9091 EMAL: — CONTACT: —

GEOPACIFIC CONSULTANTS #215-1200 W 73rd AVE, VANCOUVER, B.C. VSP 6P2

TEL: (604) 439 0922 EMAIL: carter@geopacific.ca CONTACT: John Carter

Energy Model: SRC ENGINEERING CONSULTANTS


TEL: (604) 268 9091 EMAIL: bill@sro-eng.com CONTACT: Bill Khangura

Survey: MURRAY & ASSOCIATES W201-12448 82 AVE SURREY, B.C. V3W 3E9

TEL: (604) 597 9189 EMAIL: survey@murrayls.com CONTACT: Ray Janzen


Sprinklers: CLOVER CONTRACTING LTD 6100 163B ST, SURREY, B.C. V3S 3W2

TEL: (778) 885 7432 EMAL: cam.clovercontrac CONTACT: Cam Nguyen

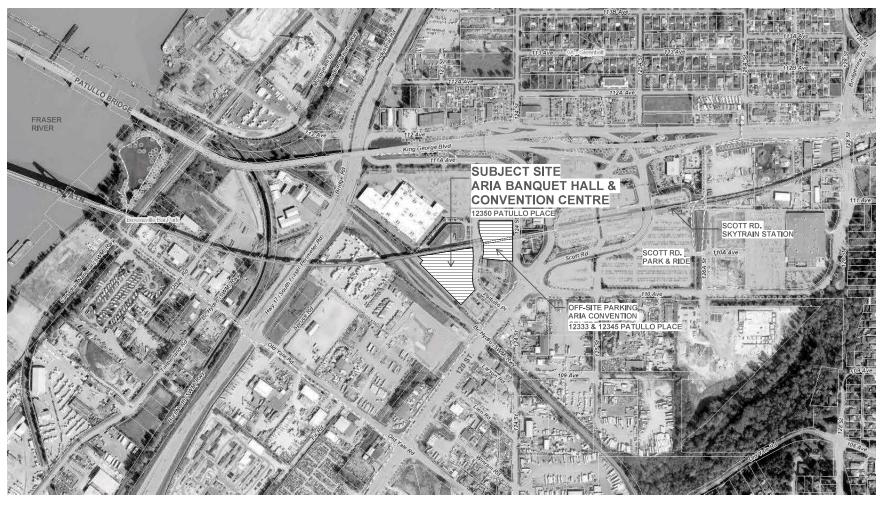

# **CONTEXT PLAN**

N.T.S.

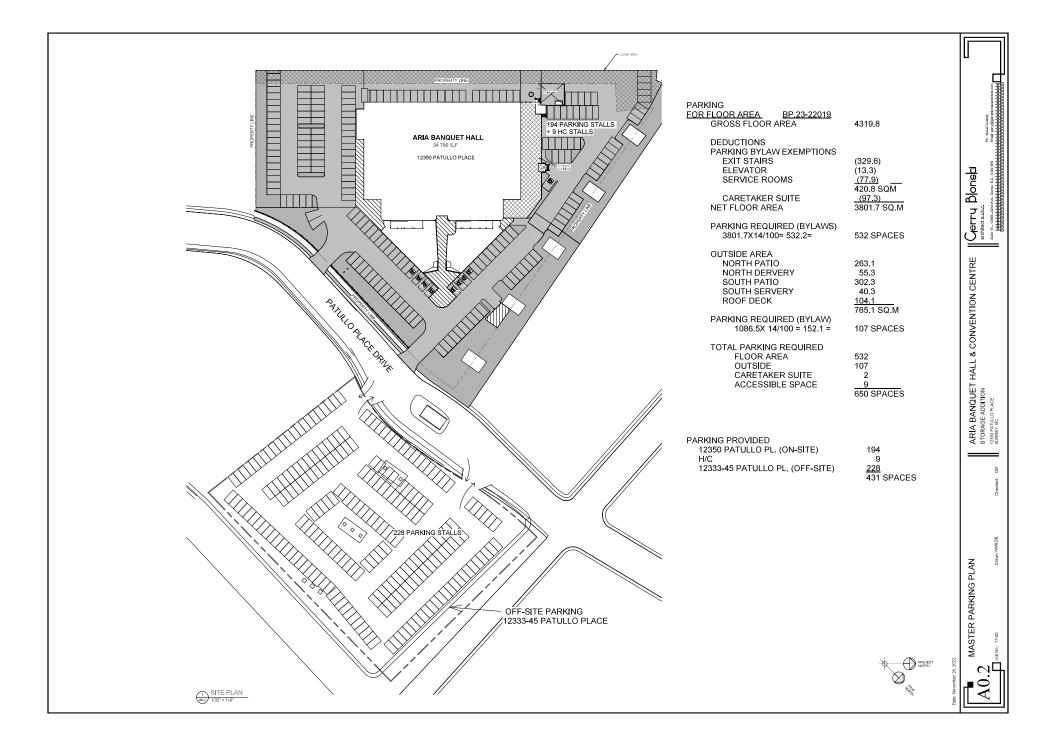

1,00	ZONE		СНІ
2.00	SITE AREA	2220	
3,00	F.A.R PERMITTED-	2230	10
3,00	F.A.R PROVIDED		-1.0
	TOTAL FLOOR AREA  BP 23-22019  SITE AREA  4319.8 = 12230		0.35
4.00	SITE COVERAGE PERMITTED		50%
	SITE COVERAGE PROVIDED - ORIGINAL BUILDING- BP 14.036402 - STORAGE ADDITION- BP 23-22019 FIRST FLOOR - NORTH SERVERY		2972.8 408.2 55.3
	- SOUTH SERVERY - ENTRANCE WALKWAY		40.3 110.8 3587.4 SQ.M
	3587.4/12230 = 0.29 =		29%
5,00	BUILDING HEIGHT		
	PERMITTED		9.0M
	HIGHEST POINT OF SKYLIGHT ON STAIR #4	EL.	17.792 M
	AVERAGE FINISHED GRADE 3,85+3,98+3,62+3,42 = 4	EL.	3.71 14.082M
	BUILDING HEIGHT PROVIDED		14.1 M
6.00	FLOOR AREA SUMMARY		
	FLOOR AREA AS APPROVED BP-14-036402 FIRST FLOOR ORIGINAL BUILDING: NORTH ADDITION (BP-14.036402): SOUTH ADDITION (BP-14.036402):		2972.8 118.2 83.6 3174.6 SQM
	MEZZANINE ORIGINAL BUILDING: REAR ADDITION (BP-14.036402):		449.7 
	TOTAL FLOOR AREA APPROVED:		3702.1 SQM
	PROPOSED ADDITION / DELETIONS ADDITION		
	FIRST FLOOR: SECOND FLOOR STORAGE: THIRD FLOOR		408.6 488.1 62.6 959.3 SQM
	DELETION NORTH ADDITION (BP-14.036402): SOUTH ADDITION (BP-14.036402): REAR MEZZANINE:		118.2 83.6 77.2 (279.0 SQM)
	NET ADDITION:		617.7 SQM
	PROPOSED TOTAL FLOOR AREA:		4319.8 SQM
7.00	PATIO SUMMARY		
	OUTSIDE AREA BP 23-22019 NORTH PATIO NORTH SERVERY SOUTH PATIO SOUTH SERVERY ROOF DECK		263.1 55.3 302.3 40.3 104.1 765.1 SQ.M
	APPROVED BP-14-036402 NORTH: SOUTH:		(158,9) (174,7) (333.6) SQM
	NET ADDITION		431.5 SQM

PARKING FOR FLOOR AREA BP.23-22019 GROSS FLOOR AREA	4319.8
DEDUCTIONS PARKING BYLAW EXEMPTIONS EXIT STARS ELEVATOR SERVICE ROOMS CARETAKER SUITE NET FLOOR AREA	(329.6) (13.3) (77.9) 420.8 SQM (97.3) 3801.7 SQ.M
PARKING REQUIRED (BYLAWS) 3801.7X14/100= 532.2=	532 SPACES
OUTSIDE AREA NORTH PATIO NORTH SERVERY SOUTH PATIO SOUTH SERVERY ROOF DECK	263.1 55.3 302.3 40.3 104.1 765.1 SO.M
PARKING REQUIRED (BYLAW) 765.1X 14/100 = 107.1 =	107 SPACES
TOTAL PARKING REQUIRED FLOOR AREA OUTSIDE CARETAKER SUITE ACCESSIBLE SPACE	532 107 2 9 650 SPACES
PARKING PROVIDED	
STANDARD STALLS 12350 PATULLO DR. ON SITE	194
12333/45 PATULLO PL OFF-SITE	228
ACCESSIBLE STALLS ON SITE	9
TOTAL STANDARD	431 STALLS

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BUILDING CODE SYNOPSIS
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2018 BC BUILDING CODE

1. MAJOR OCCUP-...
TABLE 3,12.1
GROUP A2 ASSEMBLY
2. EXISTING BUILDING PERMIT 14-036402
BUILDING AREA 3174,5 SQM
BUILDING HEIGHT 1-STOREY MEZZANINE
BUILDING IS SPRINKLERED
CONSTRUCTION NON-COMBUSTIBLE
COMBUSTIBLE
3,2,2,26

STORAGE ADDITION CHANGES
 BUILDING CHARACTERISTICS
 BUILDING AREA

LDING AREA EXISTING 3174.6 REMOVALS (201.8) ADDITION (2ND FL) 488.1 3381.4 SQM EXISTING REMOVALS

COMPLIANCE ARTICLE CHANGES TO 3.2.2.24

UNLIMITED 6-STORIES SPRINKLERED NON-COMBUSTIBLE MAXIMUM BUILDING AREA MAXIMUM BUILDING HEIGHT BUILDING MUST BE CONSTRICTION MUST BE COMBUSTIBLE MEZZANINE MUST BE REMOVED

#### SPATIAL SEPARATION

4. WEST WALL (FACING BC HYDRO RAILWAY) UNPROTECTED OPENINGS TABLE 3.2-3.D BLAZABA EASISTING 386 ADDITION 75 TOTAL 461 SOM LIMITING DISTANCE OPENINGS PERMITTED OPENINGS PROVIDED 7.6M 76% 2% WALL CONSTRUCTION TABLE 3.2.3.7 FIRE RESISTANCE RATING REQUIRED PROVIDED 45 MIN 50 MIN REFERENCE TABLE D2.3.4.A 5/8 GWB-X TABLE D2.3.4.E STEEL STUDS TOTAL 40

5. NORTH/ EAST WALLS
UNPROTECTED OPENINGS
TABLE 3.2.3.1,D
LIMITING DISTANCE TO PROPERTY LINE EXCEEDS 9M
OPENINGS PERMITTED 100%
WALL CONSTRUCTION
TABLE 3.2.37
NO FIRE RESISTANCE RATING REQUIRED

EXITS 3.2.4

ADDITION-FIRST
OF THE EXISTING FIRST FLOOR FIRE COMPARTMENT DOOR #105 IS NEW EXIT AND INCREASES THE TOTAL FIRSST FLOOR EXIT WIDTH BY 1727MM AND OCCUPANT LOAD BY 283 PERSONS

7. ADDITION-SECOND FLOOR (BANQUET ROOM)
1 NUMBER OF EXITS REQUIRED
3.4.2.1(1)
REQUIRED 2
PROVIDED 2 .2 DISTANCE BETWEEN EXITS 3.4.2.3(1)(B)


REQUIRED DIAGONAL DIM / 2
=134/2= 67 FT
PROVIDED 72 FT


.3 LOCATION OF EXITS 3.4.2.5(1)(C) MAX TRAVEL DISTANCE 45M PROVIDED 21M

4 EXIT CAPACITY EXIT CAPACITY
3.43.2.(1)(A)
ASSUME DOOR #202 IS 1/2 TOTAL CAPACITY
= 34\* x 25.4 | 6.1 = 140
TOTAL EXIT CAPACITY IS
= 2x140 = 280 PERSONS ARIA BANQUET HALL & CONVENTION CENTRE STORAGE ADDITION
STORAGE ADDITION
STORAGE ADDITION
STORAGE ADDITION

Gerry Blonski architect at lab.c.

ZONING SYNOPSIS AND BUILDING CODE

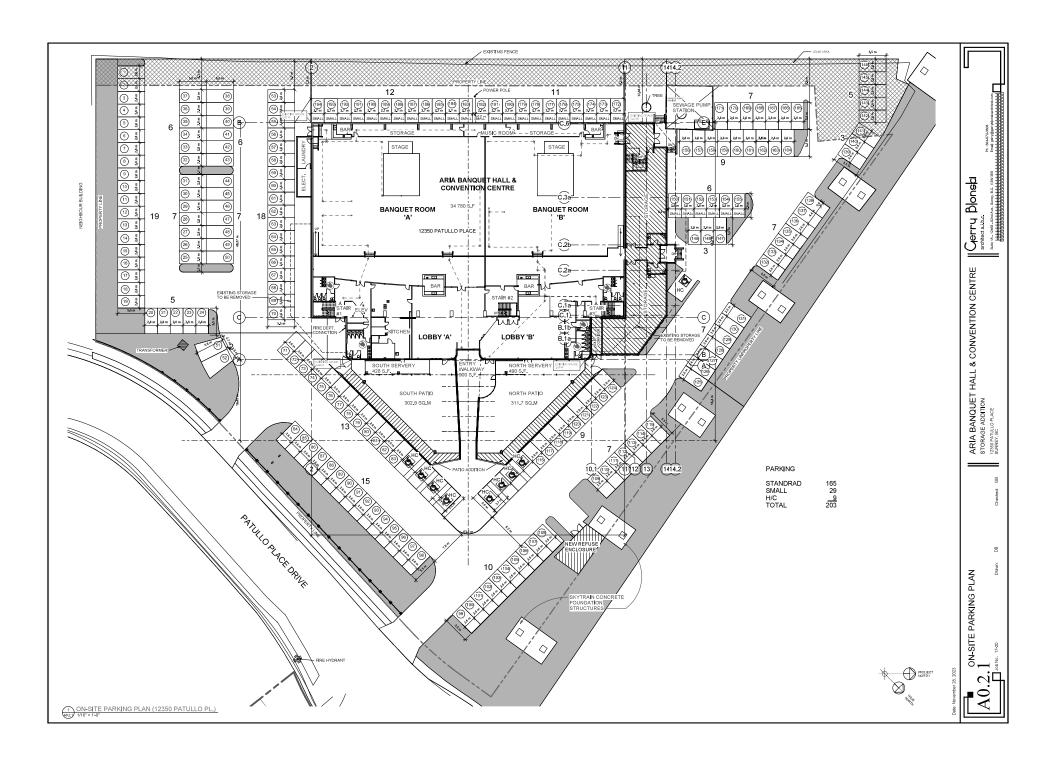

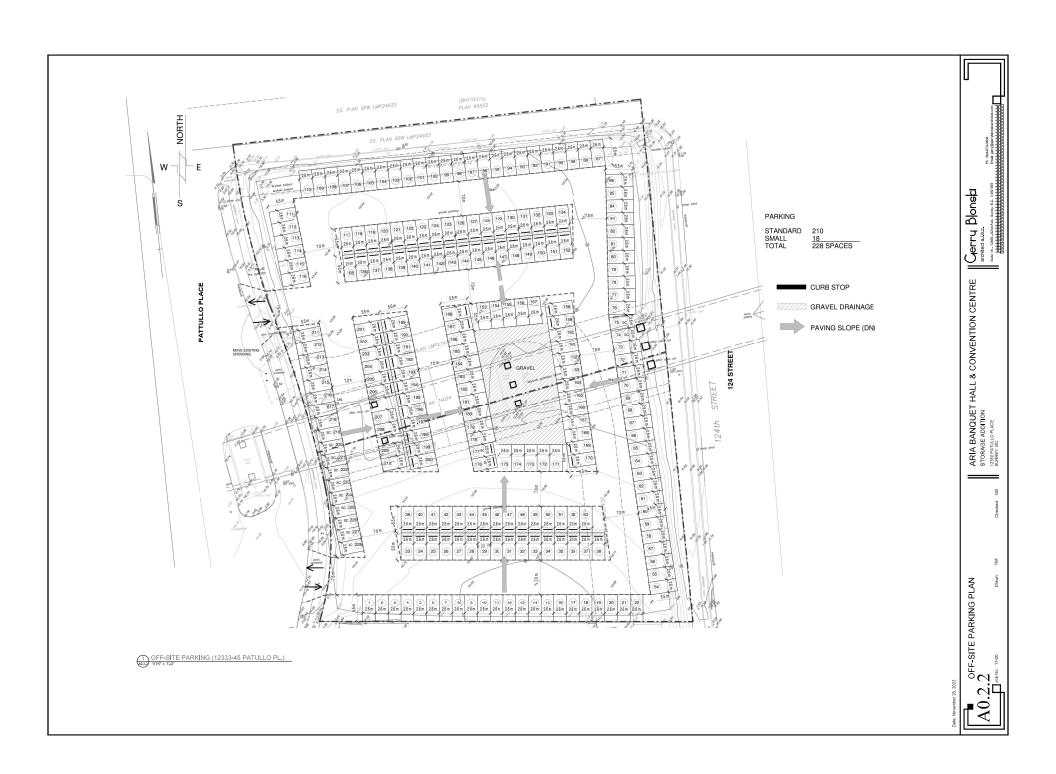

#### ZONING:

1.00	ZONE	CHI
2.00	SITE AREA	80 SQ.M)
3,00	F.A.R PERMITTED-	1,0
	F.A.R PROVIDED TOTAL FLOOR AREA BP 23-22019 SITE AREA 12230	0,35
4.00	SITE COVERAGE PERMITTED	50%
	SITE COVERAGE PROVIDED ORGENIA BILLDING- BP 14,036402 - STORAGE ADDITION- BP 23-22019 FIRST FLOOR - NORTH SERVERY - SOUTH SERVERY - ENTRANCE WALKWAY	2972.8 406.2 55.3 40.3 110.8 3587.4 SQ.M
	3587.4/12230 = 0.29 =	29%
5.00	BUILDING HEIGHT PERMITTED	9.0 M
	BUILDING HEIGHT PROVIDED HIGHEST POINT OF FLAT ROOF AVERAGE FINISHED GRADE 3.85+3.98+3.62+3.42 = 4 BUILDING HEIGHT	16.78 M 3.71 13.07 M
6.00	FLOOR AREA SUMMARY	
	FLOOR AREA AS APPROVED BP-14-036402 FIRST FLOOR ORIGINAL BUILDING: NORTH ADDITION (BP-14,036402); SOUTH ADDITION (BP-14,036402);	2972.8 118.2 83.6 3174.6 SQM
	MEZZANINE ORIGINAL BUILDING: REAR ADDITION (BP-14.036402):	449.7 
	TOTAL FLOOR AREA APPROVED:	3702.1 SQM
	PROPOSED ADDITION / DELETIONS ADDITION FIRST FLOOR: SECOND FLOOR STORAGE: THIRD FLOOR	408.6 488.1 62.6 959.3 SQM
	DELETION NORTH ADDITION (BP-14.036402): SOUTH ADDITION (BP-14.036402): REAR MEZZANINE:	118.2 83.6 77.2 (279.0 SQM)
	NET ADDITION:	617,7 SQM
	PROPOSED TOTAL FLOOR AREA:	4319.8 SQM
7.00	PATIO SUMMARY OUTSIDE AREA	
	BP 23-22019 NORTH PATIO NORTH SERVERY SOUTH PATIO SOUTH SERVERY ROOF DECK APPROVED BP-14-036402	263.1 55.3 302.3 40.3 104.1 765.1 SQ M
	NORTH: SOUTH:	(158.9) ( <u>174.7)</u> (333.6) SQM

NET ADDITION

PARKING	
FOR FLOOR AREA BP.23-22019 GROSS FLOOR AREA	4319.8
DEDUCTIONS PARKING BYLAW EXEMPTIONS EXT STARS ELEVATOR SERVICE ROOMS CARETAKER SUITE NET FLOOR AREA PARKING REQUIRED (BYLAWS)	(329.6) (13.3) (77.9) 420.8 SQM (97.3) 3801.7 SQ.M
3801.7X14/100= 532.2= OUTSIDE AREA	532 SPACES
NORTH PATIO NORTH SERVERY SOUTH PATIO SOUTH SERVERY ROOF DECK	263.1 55.3 302.3 40.3 104.1 765.1 SQ.M
PARKING REQUIRED (BYLAW) 765.1X 14/100 = 107.1 =	107 SPACES
TOTAL PARKING REQUIRED FLOOR AREA OUTSIDE CARETAKER SUITE ACCESSIBLE SPACE	532 107 2 9 650 SPACES
PARKING PROVIDED	
STANDARD STALLS 12350 PATULLO DR. ON SITE	194
12333/45 PATULLO PL OFF-SITE	228
ACCESSIBLE STALLS ON SITE	9
TOTAL STANDARD	431 STALLS

431.5 SQM

BUILDING HEIGHT

MEASURED FROM AVERAGE FINISHED GRADE TO RIDGE
OF SKYLIGHT ON STAIR #1

PERMITTED IN CHI ZONE PROPOSED 9.0M 14.1M

#### **BUILDING CODE SYNOPSIS**

2018 BC BUILDING CODE

TABLE 3,12.1

GROUP A2 ASSEMBLY

2. EXISTING BUILDING PERMIT 14-036402

BUILDING AREA 3174,5 SQM

BUILDING HEIGHT 1-STOREY MEZZANINE

BUILDING IS SPRINKLERED

ONSTRUCTION NON-COMBUSTIBLE

COMBUSTIBLE

3.2.2.26

STORAGE ADDITION CHANGES
 BUILDING CHARACTERISTICS
 BUILDING AREA

EXISTING 3174.6
REMOVALS (201.8)
ADDITION (2ND FL) 488.1
3381.4 SQM

COMPLIANCE ARTICLE CHANGES TO 3.2.2.24

UNLIMITED 6-STORIES SPRINKLERED NON-COMBUSTIBLE MAXIMUM BUILDING AREA MAXIMUM BUILDING HEIGHT BUILDING MUST BE CONSTRICTION MUST BE COMBUSTIBLE MEZZANINE MUST BE REMOVED

#### SPATIAL SEPARATION

4. WEST WALL (FACING BC HYDRO RAILWAY) UNPROTECTED OPENINGS TABLE 3.2-3.D BLAZABA EASISTING 386 ADDITION 75 TOTAL 461 SOM LIMITING DISTANCE OPENINGS PERMITTED OPENINGS PROVIDED 7.6M 76% 2% WALL CONSTRUCTION TABLE 3.2.3.7 FIRE RESISTANCE RATING REQUIRED PROVIDED 45 MIN 50 MIN REFERENCE TABLE D2.3.4.A 5/8 GWB-X TABLE D2.3.4.E STEEL STUDS TOTAL 40 5. NORTH/ EAST WALLS
UNPROTECTED OPENINGS
TABLE 3.2.1, D
LIMITING DISTANCE TO PROPERTY LINE EXCEEDS 9M
OPENINGS PERMITTED 100%
WALL CONSTRUCTION
TABLE 3.2.3.7
NO FIRE RESISTANCE RATING REQUIRED

EXITS 3.2.4

ADDITION-FIRST
OF THE EXISTING FIRST FLOOR FIRE COMPARTMENT DOOR #105 IS NEW EXIT AND INCREASES THE TOTAL FIRSST FLOOR EXIT WIDTH BY 1727MM AND OCCUPANT LOAD BY 283 PERSONS

7. ADDITION-SECOND FLOOR (BANQUET ROOM)
1 NUMBER OF EXITS REQUIRED
3.4.2.1(1)
REQUIRED 2
PROVIDED 2

.2 DISTANCE BETWEEN EXITS 3.4.2.3(1)(B)

REQUIRED DIAGONAL DIM / 2
=134/2= 67 FT
PROVIDED 72 FT

.3 LOCATION OF EXITS 3.4.2.5(1)(C) MAX TRAVEL DISTANCE 45M PROVIDED 21M

4 EXIT CAPACITY

EXIT CAPACITY
3.4.3.2.(1)(A)
ASSUME DOOR #202 IS 1/2 TOTAL CAPACITY
= 34 \* x 24 \* 16.1 = 140

TOTAL EXIT CAPACITY IS
= 2x140 = 280 PERSONS

Gerry Blonski architect at lab.c.


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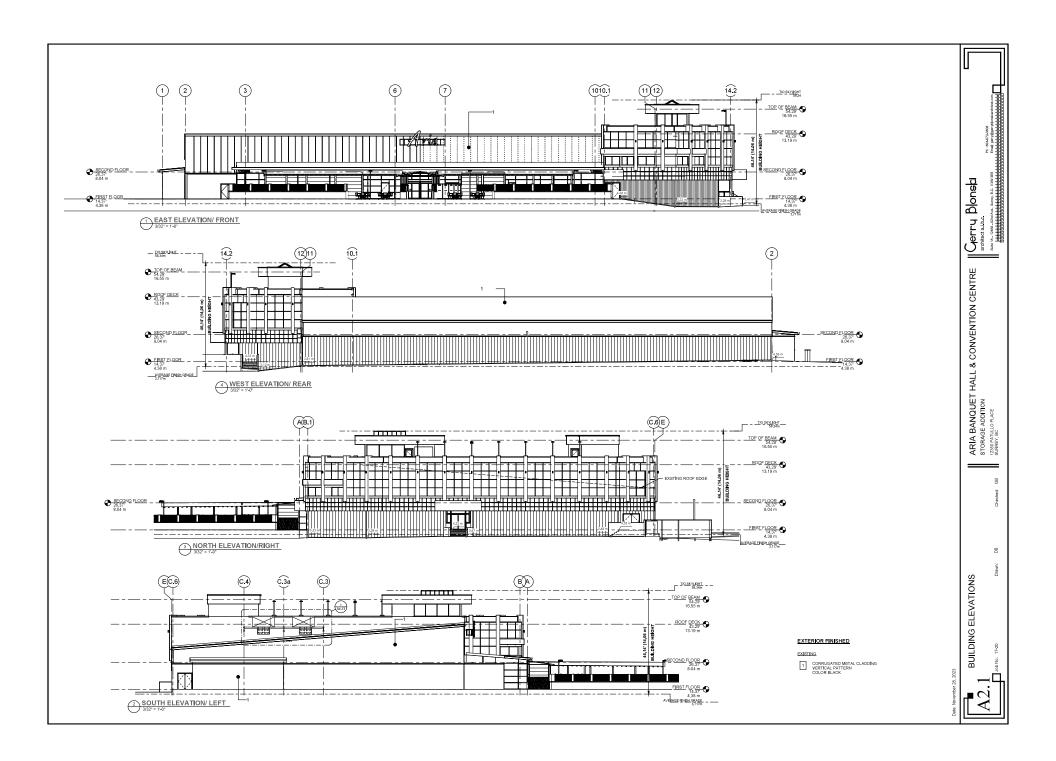
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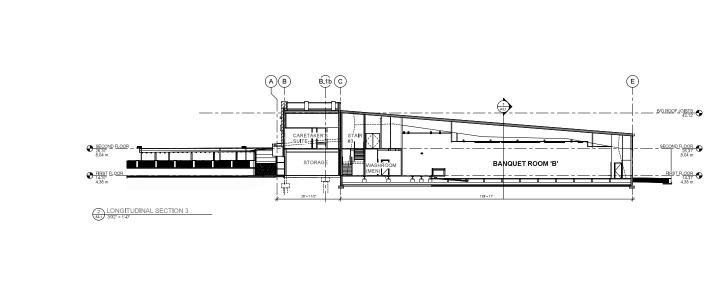
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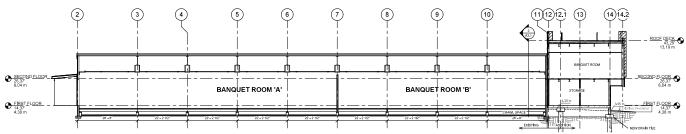
ZONING SYNOPSIS AND BUILDING









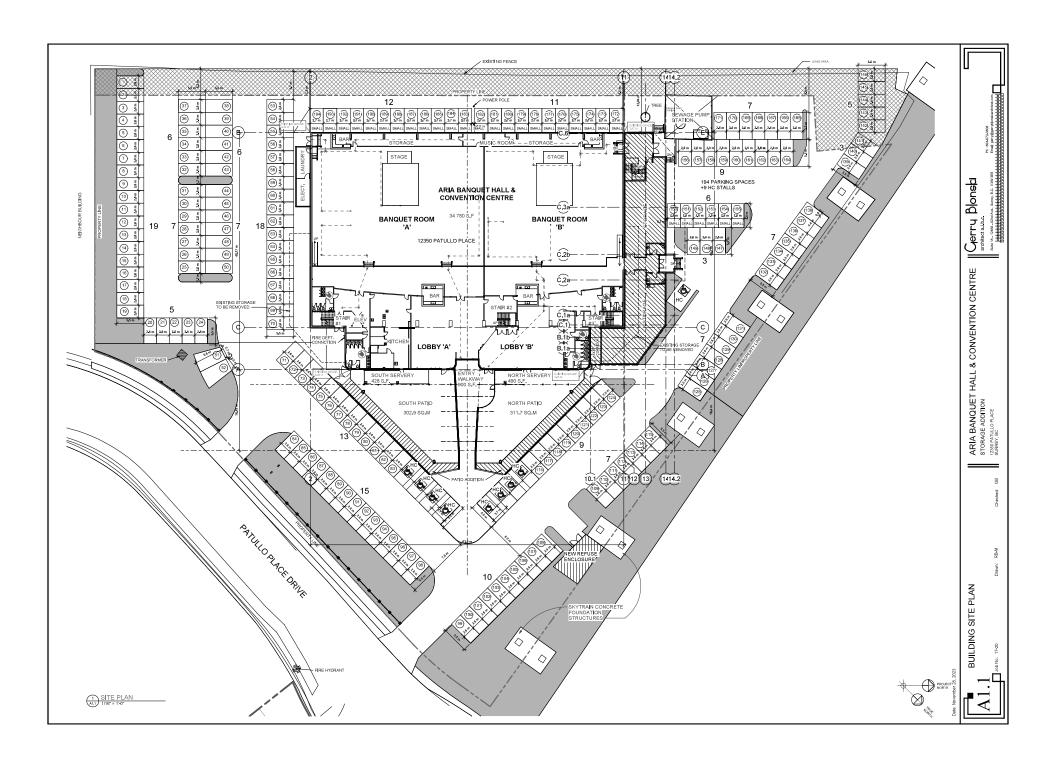


3 CROSS-SECTION 1 A3.1 3/32" = 1'-0"


BUILDING SECTIONS

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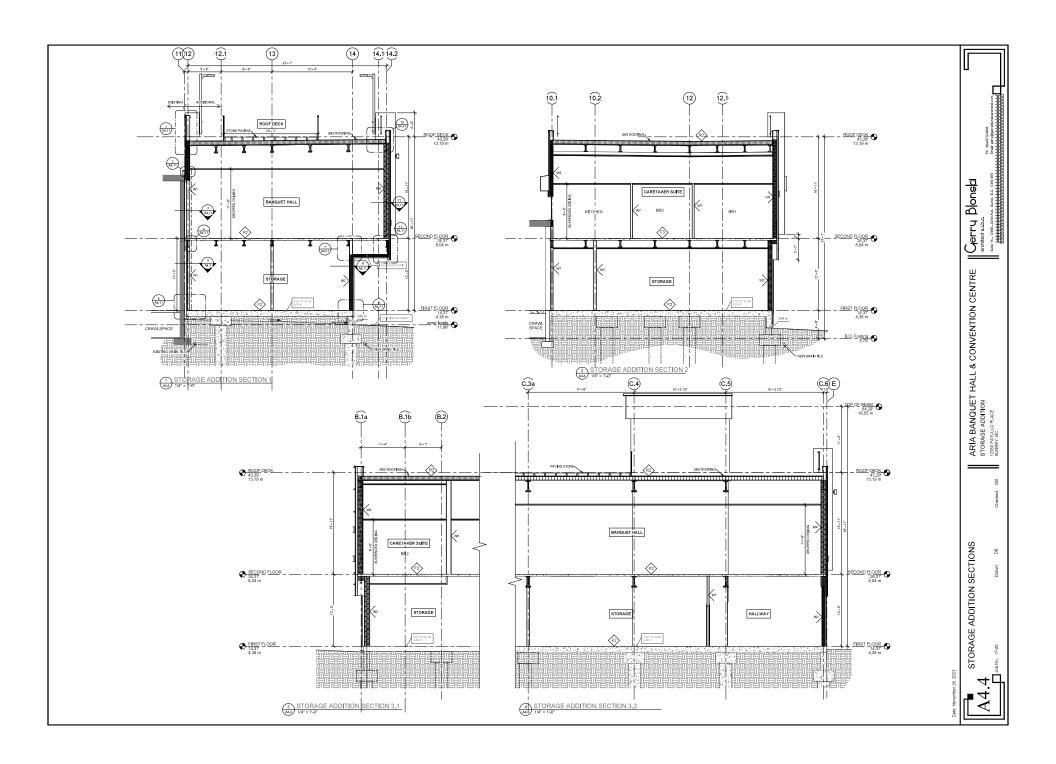



STORAGE ADDITION ELEVATIONS

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STORAGE ADDITION SECTIONS
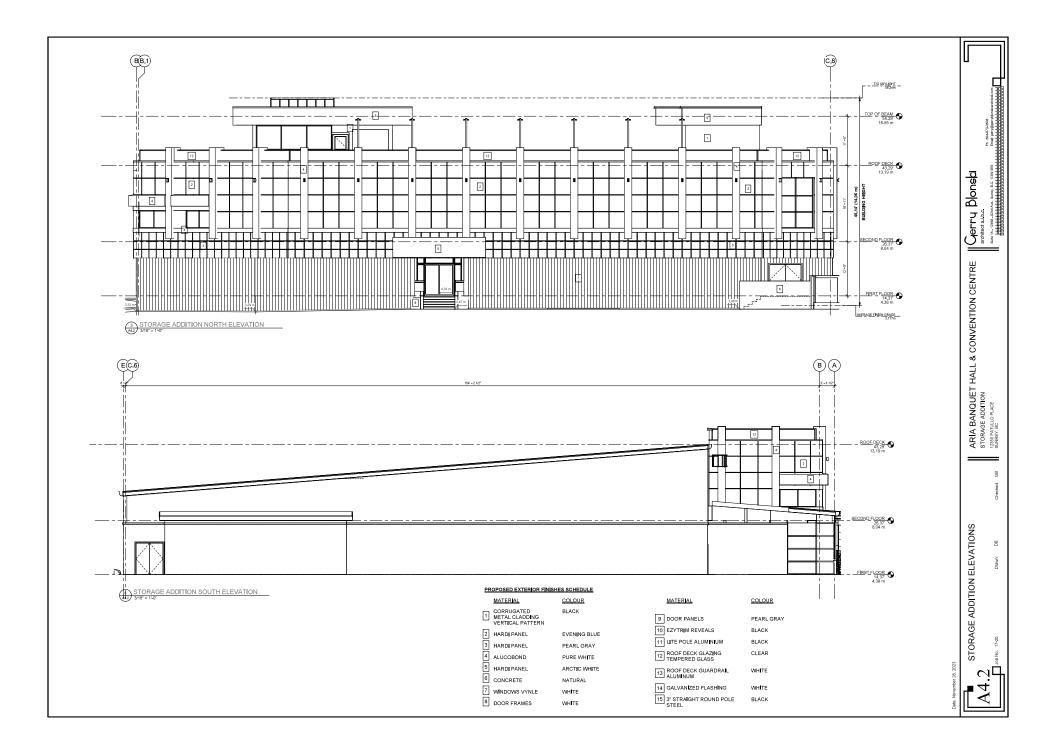
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#### **CITY OF SURREY**

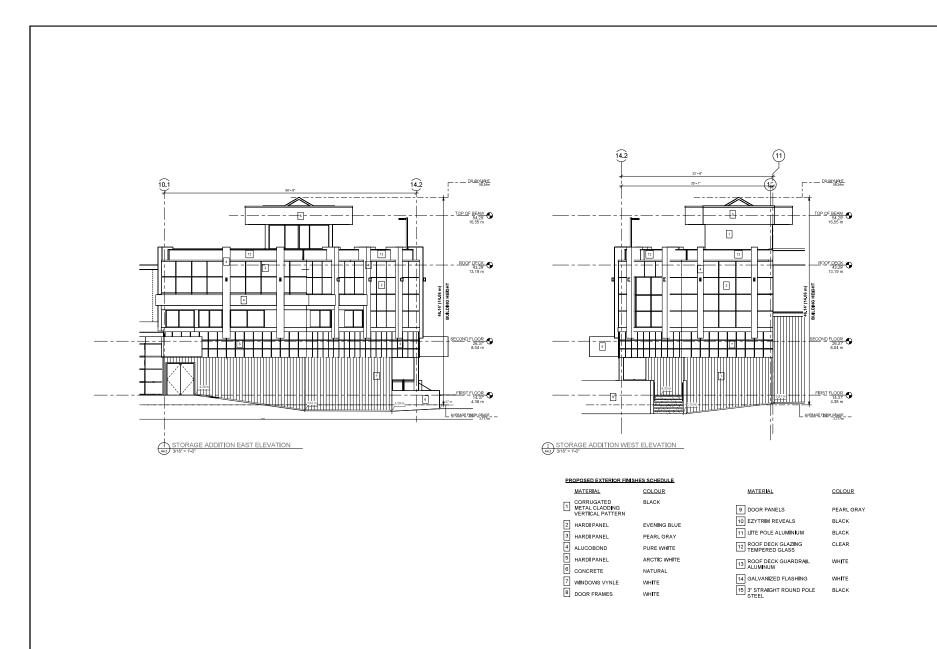(the "City")

#### **DEVELOPMENT VARIANCE PERMIT**

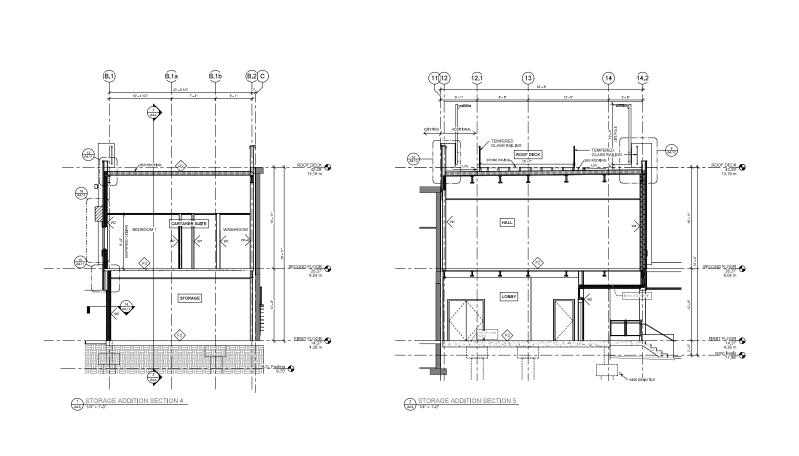NO.: 7919-0017-00

т 1	
Issued	10.
issucu	10.

("the Owners")

Address of Owner:

- 1. This development variance permit is issued subject to compliance by the Owner with all statutes, by-laws, orders, regulations or agreements, except as specifically varied by this development variance permit.
- 2. This development variance permit applies to that real property including land with or without improvements located within the City of Surrey, with the legal description and civic address as follows:

Parcel Identifier: 023-376-813

Lot 1 Section 17 Block 5 North Range 2 West New Westminster District Plan LMP27431 12333 - Pattullo Place

Parcel Identifier: 023-529-687

Lot 1 Section 17 Block 5 North Range 2 West New Westminster District Plan LMP30003 12350 - Pattullo Place

Parcel Identifier: 023-376-821

Lot 2 Section 17 Block 5 North Range 2 West New Westminster District Plan LMP27431 12345 - Pattullo Place

(the "Land")


- 3. Surrey Zoning By-law, 1993, No. 12000, as amended is varied as follows:
  - (a) In Table D.1 of Part 5 Off-Street Parking and Loading/Unloading, the required off-street parking spaces for an eating establishment (banquet hall) with a total floor area of 5,407 square metres (including patios and a caretaker suite) is reduced from 650 parking spaces to 430 parking spaces.
  - (b) In Section A.3(a)(b) of Part 5 Off-Street Parking and Loading/Unloading is varied to allow for parking spaces associated with an eating establishment (banquet hall)


- located at 12350 Patullo Place to be located on non-abutting or contiguous lots located at 12333 and 12345 Pattullo Place.
- (c) In Part 39 Highway Commercial Industrial Zone (CHI) Section G Height of Buildings the principal building height is increased from 9 metres to 14.1 metres for the banquet hall building on the site.
- 4. This development variance permit applies to only that portion of the buildings and structures on the Land shown on Schedule A which is attached hereto and forms part of this development variance permit. This development variance permit does not apply to additions to, or replacement of, any of the existing buildings shown on attached Schedule A, which is attached hereto and forms part of this development variance permit.
- 5. The Land shall be developed strictly in accordance with the terms and conditions and provisions of this development variance permit.
- 6. This development variance permit shall lapse if the Owner does not substantially start any construction with respect to which this development variance permit is issued, within two (2) years after the date this development variance permit is issued.
- 7. The terms of this development variance permit or any amendment to it, are binding on all persons who acquire an interest in the Land.
- 8. This development variance permit is not a building permit.


AUTHORIZING RESOLUTION PASSED BY THE COUNCIL, THE DAY OF , 20 . ISSUED THIS DAY OF , 20 .

Mayor – Brenda Locke

City Clerk – Jennifer Ficocelli

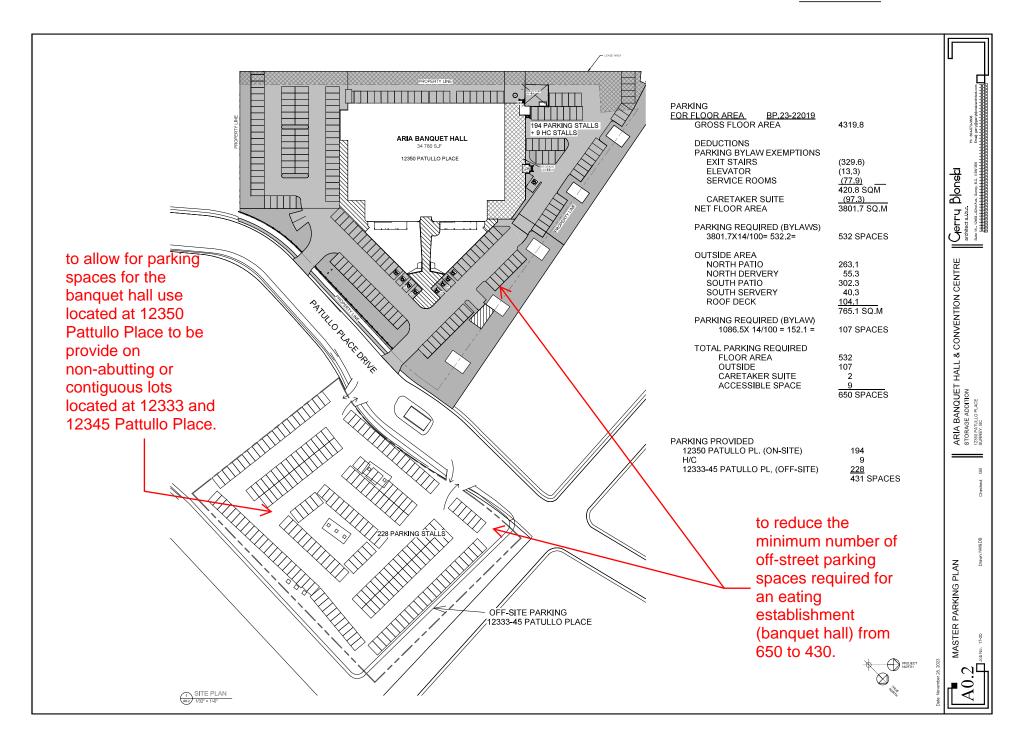

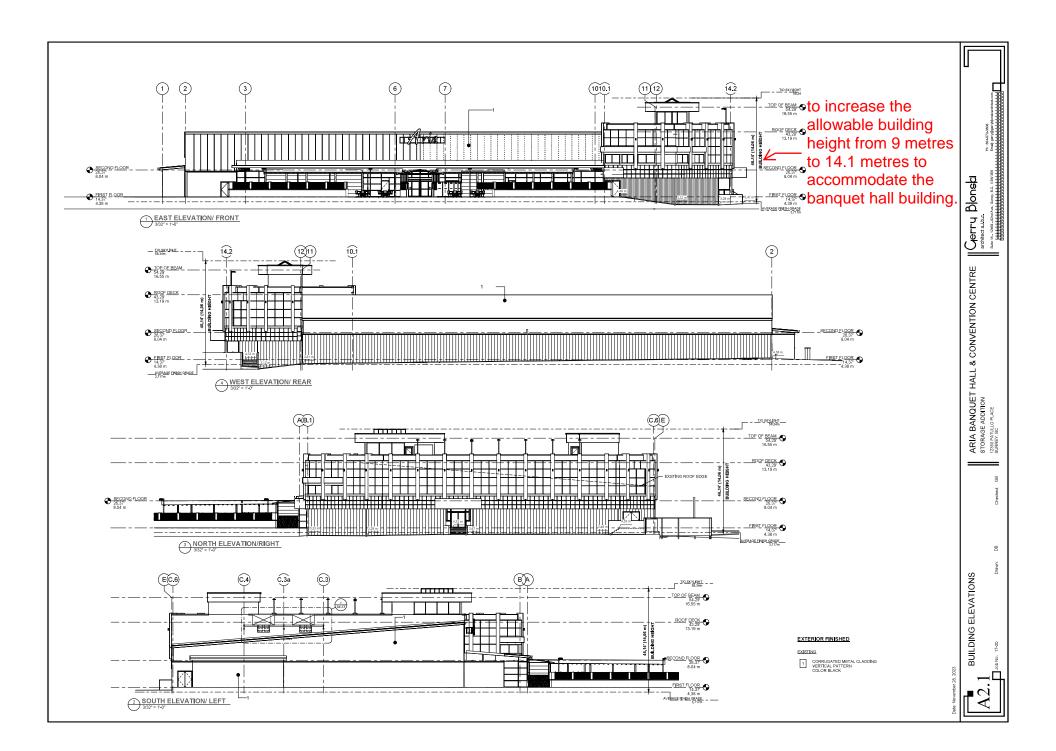

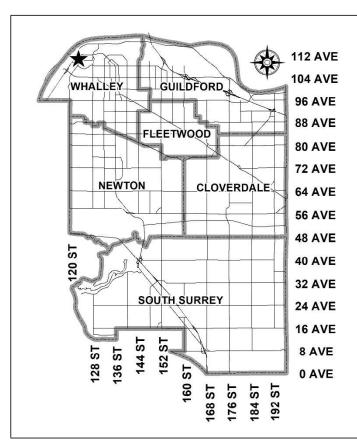

# City of Surrey PLANNING & DEVELOPMENT REPORT Application No.: 7919-0017-00

Planning Report Date: July 11, 2022

#### PROPOSAL:

- Development Permit
- Development Variance Permit


to address parking requirements, including proposed off-site surface parking lots, and to formalize exterior modifications already completed to an existing banquet hall.

LOCATION: 12333 - Pattullo Place

12345 - Pattullo Place 12350 - Pattullo Place

ZONING: CHI

OCP DESIGNATION: Mixed Employment NCP DESIGNATION: Highway Commercial

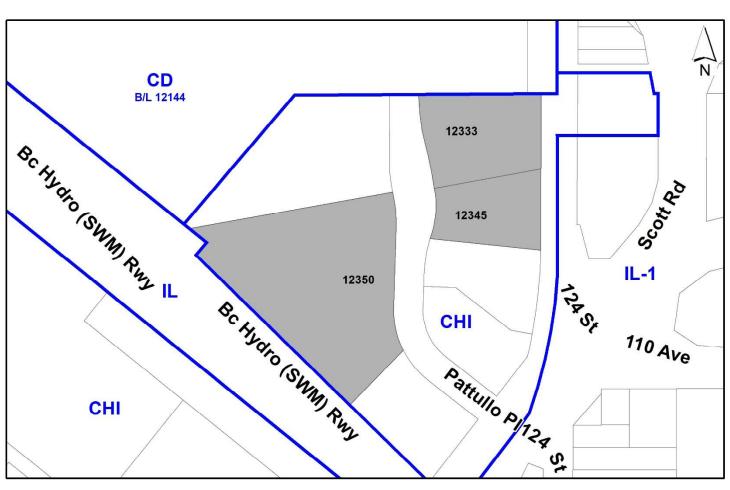

#### RECOMMENDATION SUMMARY

- Approval to draft Development Permit for Form and Character.
- Approval for Development Variance Permit to proceed to Public Notification.

# **DEVIATION FROM PLANS, POLICIES OR REGULATIONS**

- The applicant is seeking the following variances in order to address parking requirements for an existing operational banquet hall:
  - o to reduce the minimum number of off-street parking spaces required for an eating establishment (banquet hall) from 650 to 430;
  - o to allow for parking spaces for the banquet hall use located at 12350 Pattullo Place to be provide on non-abutting or contiguous lots located at 12333 and 12345 Pattullo Place; and
  - o to allow the proposed surface parking lots at 12333 and 12345 Pattullo Place to be surfaced with gravel.

#### RATIONALE OF RECOMMENDATION

- The proposal complies with the Mixed Employment designation in the Official Community Plan (OCP).
- The proposal complies with the Highway Commercial designation in the South Westminster Neighbourhood Concept Plan (NCP).
- The proposed Development Permit will authorize exterior renovations to the existing banquet hall building previously completed without permits
- The proposed formalizing of both 12333 and 12345 Pattullo Place as off-street parking facilities will help to formalize the existing informal parking use of these gravel lots.
  - As a condition of final approval of the proposed Development Permit and Development Variance Permit, the applicant will be required to register formal reciprocal access easements for shared parking over the three (3) subject properties.
  - The applicant retained a Transportation Consultant (Binnie Engineering) to prepare a parking study for the site. The study included three site visits during various events at the banquet hall. The study observed a maximum parking demand of 371 parking spaces and therefore concluded that the proposed 430 parking spaces will be sufficient to accommodate the banquet hall operations.

The parking study also notes that in addition to the 430 parking spaces available on the subject properties, there approximately 20 on-street parking spaces available on the west site of Pattullo Place and a pay parking lot just north of the site at 11125-124 Street that accommodates a further 97 parking spaces. In addition, the applicant has also entered into an agreement with an adjacent property owner to allow vehicles for banquet hall patrons to park in the 26 spaces available at 12355 Pattullo Place after 6:30 pm.

City staff also reviewed the proposed parking supply and support the proposed parking reduction. Staff note the following rationale in support of the variance:

- The proposed patio area will not be a fully enclosed/covered and is located away from the main assembly/seating area, so the space is supplementary and not expected to generate parking demand;
- A portion of the banquet hall (100 sq. m) is reserved for storing a large inventory of furniture and supplies to operate;
- The building contains a caretaker suite with 3 bedrooms, which will be parked at the same rate as ground oriented multi-family developments in the City (2 spaces total);
- The site is in close proximity to Scott Road Skytrain station (approximately 300 m) which results in some guests and staff utilizing transit to attend events; and
  - Given the proximity of the subject property to the Frequent Transit Network (FTN), including Scott Road SkyTrain Station, an additional 10% reduction in the rate used to calculate the required parking for the banquet hall use has merit; and
- Given the nature of the events and guest arrival patterns at this banquet hall, there is a higher proportion of carpooling/high-occupancy vehicles and new mobility services like ride hailing.
- There's currently on-street parking available fronting and adjacent the subject site, with low parking demand on evening and weekends (industrial and commercial uses adjacent), so some overflow can be accommodated on the street, without disruption to residents.

#### RECOMMENDATION

The Planning & Development Department recommends that:

- 1. Council approve Development Variance Permit No. 7919-0017-00 (Appendix III), varying the following to proceed to Public Notification:
  - (a) to reduce the minimum number of off-street parking spaces required for an eating establishment (banquet hall) from 650 to 430;
  - (b) to allow for parking spaces for the banquet hall use located at 12350 Pattullo Place to be provide on non-abutting or contiguous lots located at 12333 and 12345 Pattullo Place; and
  - (c) to allow the proposed surface parking lots at 12333 and 12345 Pattullo Place to be surfaced with gravel.
- 2. Council instruct staff to resolve the following issues prior to final approval:
  - (a) ensure that all engineering requirements and issues including restrictive covenants, dedications, and rights-of-way where necessary, are addressed to the satisfaction of the General Manager, Engineering;
  - (b) final approval from TransLink;
  - (c) resolution of all urban design issues to the satisfaction of the Planning and Development Department;
  - (d) submission of a finalized landscaping plan, landscaping cost estimate and arborist report to the specifications and satisfaction of the Planning and Development Department;
  - (e) submission of a finalized tree survey and a statement regarding tree preservation to the satisfaction of the City Landscape Architect;
  - (f) the applicant satisfy the deficiency in tree replacement on the site, to the satisfaction of the Planning and Development Department;
  - (g) registration of shared access easements and parking agreements to ensure the banquet hall has ongoing access to parking at 12333 and 12345 Pattullo Place;
  - (h) the applicant complete conversion of 4 parking spaces on the banquet hall site to accessible parking spaces (to increase from 5 to 9 accessible parking spaces);
  - (i) the applicant is to submit a revised sign permit to authorize existing signage already installed on the building and site; and
  - (j) submission of securities to ensure that curb stops are installed within the gravel parking lots for proper parking stall delineation to the satisfaction of the Planning & Development Department.

#### **SITE CONTEXT & BACKGROUND**

Direction	<b>Existing Use</b>	NCP Designation	<b>Existing Zone</b>
Subject Sites	Aria Convention Centre and vacant gravel lots	Highway Commercial, Parks and Open Spaces	CHI
North:	Highway commercial uses and parking for large multi- purpose building	Highway Commercial	CHI and CD Bylaw 12144
East (Across 124 Street):	Autobody repair, used car dealership	Highway Commercial	IL-1, CHI
Southeast:	Highway commercial uses	Highway Commercial	СНІ
Southwest (across BC Hydro (SWM) Railway):	Proposed two- storey industrial warehouse building with upper floor office space. Supported by Council on January 25, 2021.	Business/Residential Park	IL-1

#### **Context & Background**

- The three subject sites, 12333, 12345 and 12350 Pattullo Place, are either adjacent or directly encumbered by a TransLink Skytrain guideway. The sites are designated Mixed Employment in the Official Community Plan (OCP) and Highway Commercial in the South Westminster Neighbourhood Concept Plan (NCP). The sites are currently zoned Highway Commercial Industrial Zone (CHI).
- The existing banquet hall facility located on 12350 Pattullo Place and now formally known as the Aria Convention Centre was originally constructed as part of Application No. 7996-010-00, at which time the building was intended for a bowling centre and entertainment complex. The building has subsequently been converted to a banquet hall facility.
- Building permits were issued in 2014 permitting building additions resulting in a total floor
  area of 3702.1 square metres. Further additions have been added to the buildings without
  proper permits or approvals, however the applicant is working with Building Division staff to
  obtain the appropriate building permits for the unauthorized work. The subject Development
  Permit is intended to formalize all existing and proposed changes to the form and character of
  the building.
- Offsite parcels located at 12333 and 12345 Pattullo Place, are also owned by the same owner of 12350 Pattullo Place. These empty gravel lots are proposed to accommodate parking for the banquet hall. It is anticipated that these parcels will be redeveloped in the future.

#### **DEVELOPMENT PROPOSAL**

## **Planning Considerations**

- A Form and Character Development Permit is proposed to formalize previously constructed additional and external renovations to the building.
- The building has a combined total floor area of 4,703 square metres (including building interior and patio space). The building complies with the floor area ratio, lot coverage, building height, and setbacks of the CHI Zone.
- Based on the banquet hall facility's various components, which include the assembly area, storage space, patio space and a caretaker suite, the total required parking is 630 parking spaces under the Zoning By-law. There are a total of 218 parking spaces on the banquet hall site. The applicant is proposing to modify the existing gravel lots at 12333 and 12345 Pattullo Place with appropriate curb stops to delineate an additional 212 parking spaces (resulting in a total of 430 parking spaces).
- Development details are provided in the following table:

	Proposed
Lot Area	
Gross Site Area:	1.22 hectares
Road Dedication:	N/A
Undevelopable Area:	N/A
Net Site Area:	1.22 hectares
Number of Lots:	1
Building Height:	8.3 metres
Unit Density:	N/A
Floor Area Ratio (FAR):	0.39

#### Referrals

Engineering: The Engineering Department has no objection to the project.

Ministry of Transportation & Infrastructure (MOTI):

Ministry of Transportation & Infrastructure has no objections.

Surrey Fire Department: The Surrey Fire Department has no objections.

TransLink: TransLink has no objections, subject to a construction

management plan for works adjacent the SkyTrain guideway.

# **Transportation Considerations**

- The banquet hall facility requires 650 parking spaces (648 for banquet hall based on the required parking rate of 14 spaces/100 sq.m of floor area plus 2 parking spaces for caretaker suite) and the applicant is providing 430 parking spaces, combined between the banquet hall site and on the two properties located on the east side of Pattullo Place. As a result of this shortfall in total parking spaces, a variance is required (see Variances section).
- The rear of the site contains parking spaces as part of a lease agreement with BC Hydro, where parking is provided over top of an existing BC Hydro Right of Way (ROW) on the property. These spaces are included as part of the total parking count.
- There are two (2) driveway accesses for the banquet hall site (12350 Pattullo Place) and an additional two (2) driveway accesses for the offsite gravel parcels 12333 and 12345 Pattullo Place.
- Registration of a formal parking easement/shared parking agreement will be required in order to ensure ongoing access to the 212 offsite parking on 12333 and 12345 Pattullo Place for use by the banquet hall.

#### Parkland and/or Natural Area Considerations

- A Class C watercourse (ditch) is located within the BC Hydro Railway immediately south of the Aria Convention site at 12350 Pattullo Place.
- The applicant is not proposing any additional additions to the rear of the Aria Convention Centre building, which would impact the watercourse.
- A qualified Environmental Professional has assessed the watercourse and provided confirmation that the Class C designation is correct.
- Due to minimal risk of encroachment and development impact, further assessments are not required, nor is there a requirement for a Sensitive Ecosystem Development Permit.

# **Sustainability Considerations**

• The applicant has met all of the typical sustainable development criteria, as indicated in the Sustainable Development Checklist.

#### **POLICY & BYLAW CONSIDERATIONS**

#### **Regional Growth Strategy**

- The subject site is designated "General Urban" under the Metro Vancouver Regional Growth Strategy (RGS).
- The existing use complies with the RGS designation.

#### Official Community Plan

# **Land Use Designation**

- The subject site is designated "Mixed Employment" in the Official Community Plan (OCP).
- The existing use complies with the OCP designation.

# **Secondary Plans**

#### Land Use Designation

• The existing use complies with the "Highway Commercial" Designation in the South Westminster Neighborhood Concept Plan (NCP).

# **Zoning By-law**

• The building (with previously constructed additions) has a combined total floor area of 4,703 square metres (including building interior and patio space). The building complies with the floor area ratio, lot coverage, building height, and setbacks of the CHI Zone.

# **Parking Variances**

- The applicant is requesting the following variances:
  - o to reduce the minimum number of off-street parking spaces required for an eating establishment (banquet hall) from 650 to 430;
  - o to allow for parking spaces for the banquet hall use located at 12350 Pattullo Place to be provide on non-abutting or contiguous lots located at 12333 and 12345 Pattullo Place; and
  - o to allow the proposed surface parking lots at 12333 and 12345 Pattullo Place to be surfaced with gravel.
- The applicant retained a Transportation Consultant (Binnie Engineering) to prepare a parking study for the site. The study included three site visits during various events at the banquet hall. The study observed a maximum parking demand of 371 parking spaces and therefore concluded that the proposed 430 parking spaces will be sufficient to accommodate the banquet hall operations.
- The parking study also notes that in addition to the 430 parking spaces available on the subject properties, there approximately 20 on-street parking spaces available on the west site of Pattullo Place and a pay parking lot just north of the site at 11125- 124 Street that accommodates a further 97 parking spaces. In addition, the applicant has also entered into an agreement with an adjacent property owner to allow vehicles for banquet hall patrons to park in the 26 spaces available at 12355 Pattullo Place after 6:30 pm.

- City staff also reviewed the proposed parking supply and support the proposed parking reduction. Staff note the following rationale in support of the variance:
  - The proposed patio area will not be a fully enclosed/covered and is located away from the main assembly/seating area, so the space is supplementary and not expected to generate parking demand;
  - A portion of the banquet hall (100 sq. m) is reserved for storing a large inventory of furniture and supplies to operate;
  - The building contains a caretaker suite with 3 bedrooms, which will be parked at the same rate as ground oriented multi-family developments in the City (2 spaces total);
  - The site is in close proximity to Scott Road Skytrain station (approximately 300 m) which results in some guests and staff utilizing transit to attend events; and
    - Given the proximity of the subject property to the Frequent Transit Network (FTN), including Scott Road SkyTrain Station, an additional 10% reduction in the rate used to calculate the required parking for the banquet hall use has merit; and
  - Given the nature of the events and guest arrival patterns at this banquet hall, there is a higher proportion of carpooling/high-occupancy vehicles and new mobility services like ride hailing.
  - There's currently on-street parking available fronting and adjacent the subject site, with low parking demand on evening and weekends (industrial and commercial uses adjacent), so some overflow can be accommodated on the street, without disruption to residents.
- The Zoning By-law requires that all off-street parking areas must be:
  - graded and drained so as to properly dispose of all surface water; as determined by the City; and
  - o surfaced with an asphalt, concrete, or similar pavement so as to provide a surface that is dust-free.
- The applicant has future redevelopment plans for 12333 and 12345 Pattullo Place and as such a gravel surface is deemed to be supportable as an interim condition. The applicant is aware that any future redevelopment of 12333 and 12345 Pattullo Place will require both interim and permanent parking solutions to continue to accommodate the banquet hall at 12350 Pattullo Place. Curb stops are required to installed to ensure adequate parking space delineation in the surface parking lots. Additional securities will be required as a condition of final approval, should Council support the variances, to ensure that the curb stop work is completed.
- Staff noted that while the reduction in total parking spaces can be supported, the number of accessible on-site parking spaces is required to be increased from 5 spaces to 9 spaces. This will be a condition of final approval, should Council support the requested variances.

### **PUBLIC ENGAGEMENT**

• Pre-notification letters were sent on June 30, 2022, and the Development Proposal Signs were installed on July 4, 2022. Staff received have not received responses from neighbouring property owners.

### **DEVELOPMENT PERMITS**

### Hazard Lands (Flood Prone) Development Permit Requirement

- The subject property falls within the Hazard Lands (Flood Prone Area) Development Permit Area (DPA) in the OCP, given that the site is within the 200-year floodplain of the Fraser River. The Hazard Land (Flood Prone) Development Permit is required to protect developments from hazardous conditions.
- Further assessments are not required as the proposed scope of work is to capture completed additions and renovations to an already existing building.

### Form and Character Development Permit Requirement

- The proposed development is subject to a Development Permit for Form and Character and is also subject to the urban design guidelines in the South Westminster Neighbourhood Concept Plan (NCP).
- The existing building generally complies with the Form and Character Development Permit guidelines in the OCP and the design guidelines in the South Westminster Neighbourhood Concept Plan (NCP).
- Parking is intended to be delineated in a manner that allows for adequate onsite maneuverability along drive aisles.
- The existing banquet hall building has its main entrance along the street. The design incorporates elements that create a sense of entry with corrugated metal cladding and vertical black patterns.
- One existing fascia sign was installed, above the roofline, on the front east elevation without
  permits. A previous DVP was captured to allow for a fascia sign to extend above the roofline.
  A sign permit application will be required, prior to issuance of the subject Form and Character
  Development Permit and Development Variance Permit.

### TREES

 Corey Plester, ISA Certified Arborist of Mike Fadum and Associates Ltd. prepared an Arborist Assessment for the subject property. The table below provides a summary of the tree retention and removal by tree species:

Table 1: Summary of Tree Preservation by Tree Species:

Tree Species		isting	Remove	Retain	
Alder and Cottonwood Trees					
Cottonwood	1 0 1				
(excluding		ous Trees	ood Trees)		
Red Maple		12	1	11	
Japanese Maple		3	0	3	
Cherry		9	0	9	
Honey Locust		4	0	4	
	Conifer	rous Trees			
Austrian Pine		7	0	7	
Douglas Fir		1	0	1	
Western Red Cedar		12	0	12	
Lawson False Cypress		1	0	1	
<b>Total</b> (excluding Alder and Cottonwood Trees)		49	4	48	
Total Replacement Trees Proposed (excluding Boulevard Street Trees)					
Total Retained and Replacement Trees TBD					
Contribution to the Green City Program \$800					

- The Arborist Assessment states that there is a total of 49 mature trees on the site, excluding Alder and Cottonwood trees. It was determined that 48 trees can be retained as part of this development proposal. The proposed tree retention was assessed taking into consideration the location of services, building footprints, road dedication and proposed lot grading.
- For those trees that cannot be retained, the applicant will be required to plant trees on a 1 to 1 replacement ratio for Alder and Cottonwood trees, and a 2 to 1 replacement ratio for all other trees. This will require a total of 2 replacement trees on the site. No replacement trees have been proposed at this time. Submission of a revised arborist report and landscape plan is to be provided to Planning staff for review and approval prior to, and as condition of Development Permit and Development Variance Permit issuance.
- If no replacement trees are proposed to be accommodated on the subject site in a new arborist report submission, the deficit of 2 replacement trees will require a cash-in-lieu payment of \$800 representing \$400 per tree to the Green City Program, in accordance with the City's Tree Protection By-law.

### INFORMATION ATTACHED TO THIS REPORT

The following information is attached to this Report:

Appendix I. Site Plan, Building Elevations, Landscape Plans and Perspective

Appendix II. Summary of Tree Survey and Tree Preservation Appendix III. Development Variance Permit No. 7919-0017-00

Appendix IV. Parking Study

approved by Ron Gill

Jeff Arason Acting General Manager Planning & Development

ELM/cm



**ARIA BANQUET HALL** 

Gerry Blonsch and the sense of 
DP SUBMISSION

STORAGE ADDITION ARIA CONVENTION CENTER

Checked: CHECKED:

PERSPECTIVE VIEWS

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N Sibber

OP SUBMISSION


STORAGE ADDITION
ARIA CONVENTION CENTER


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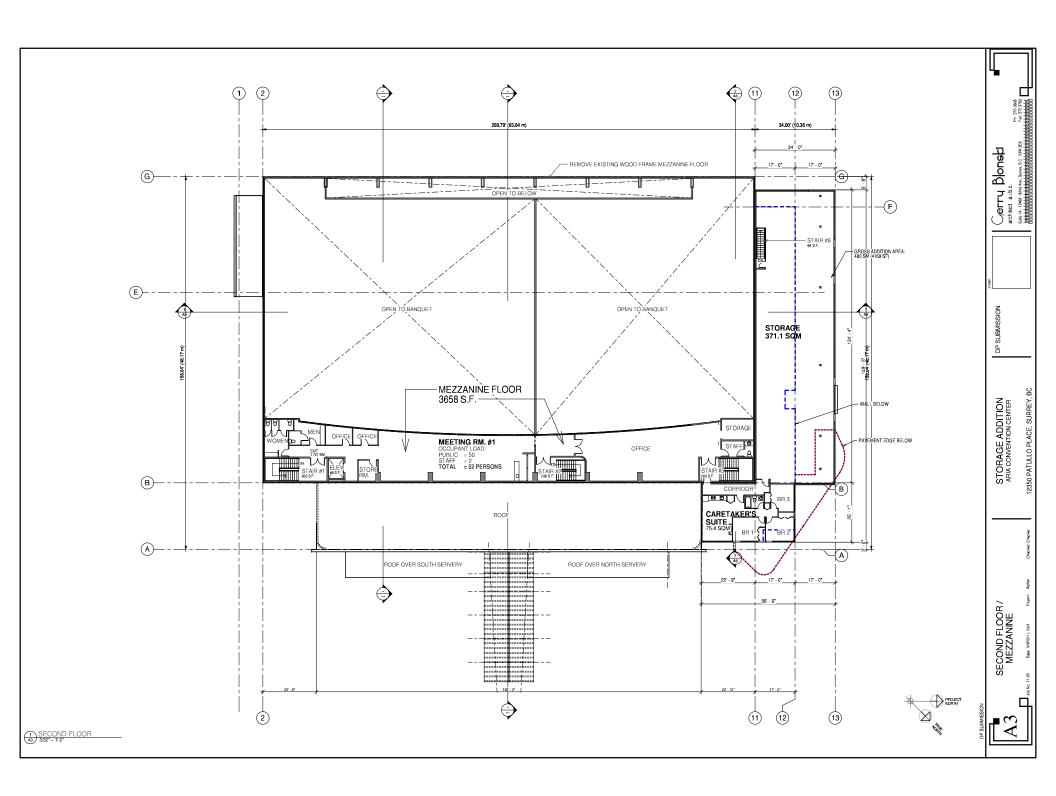
CONTEXT PLAN


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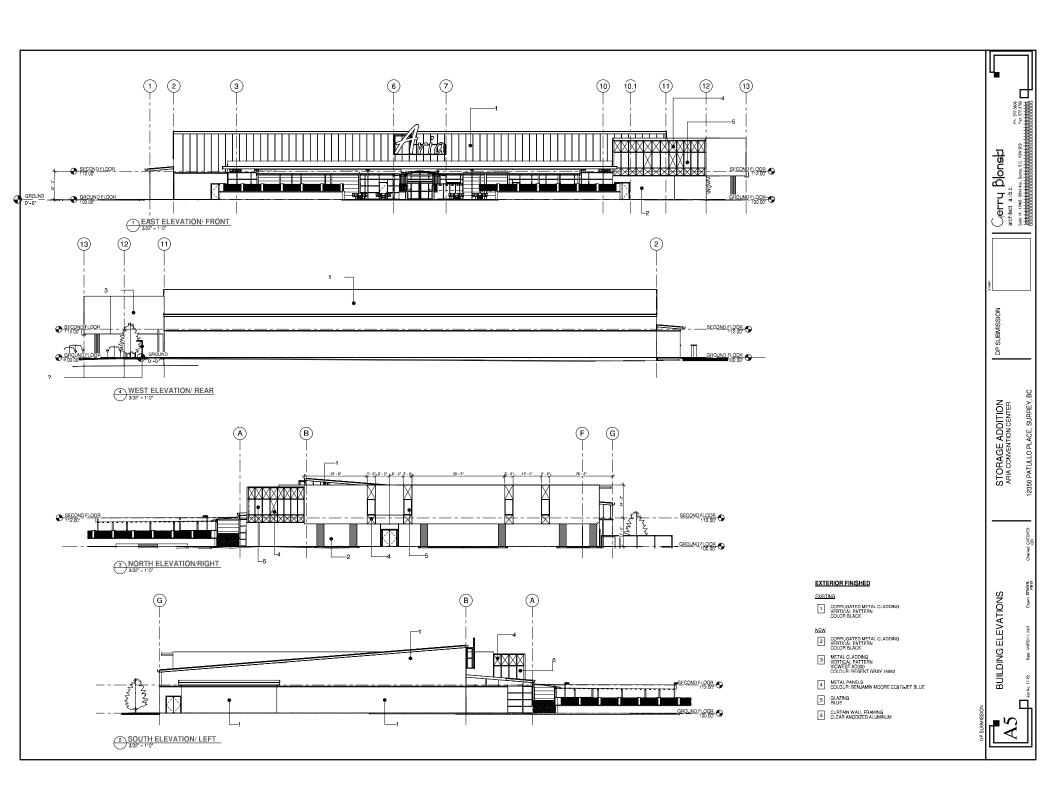







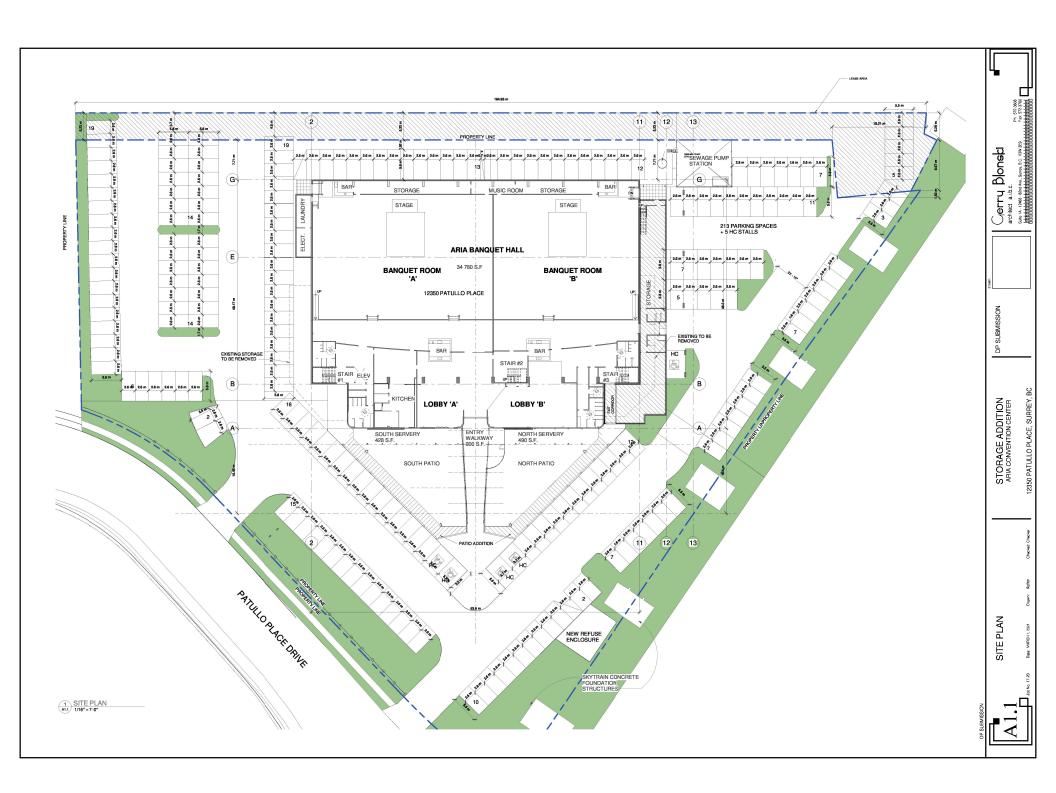

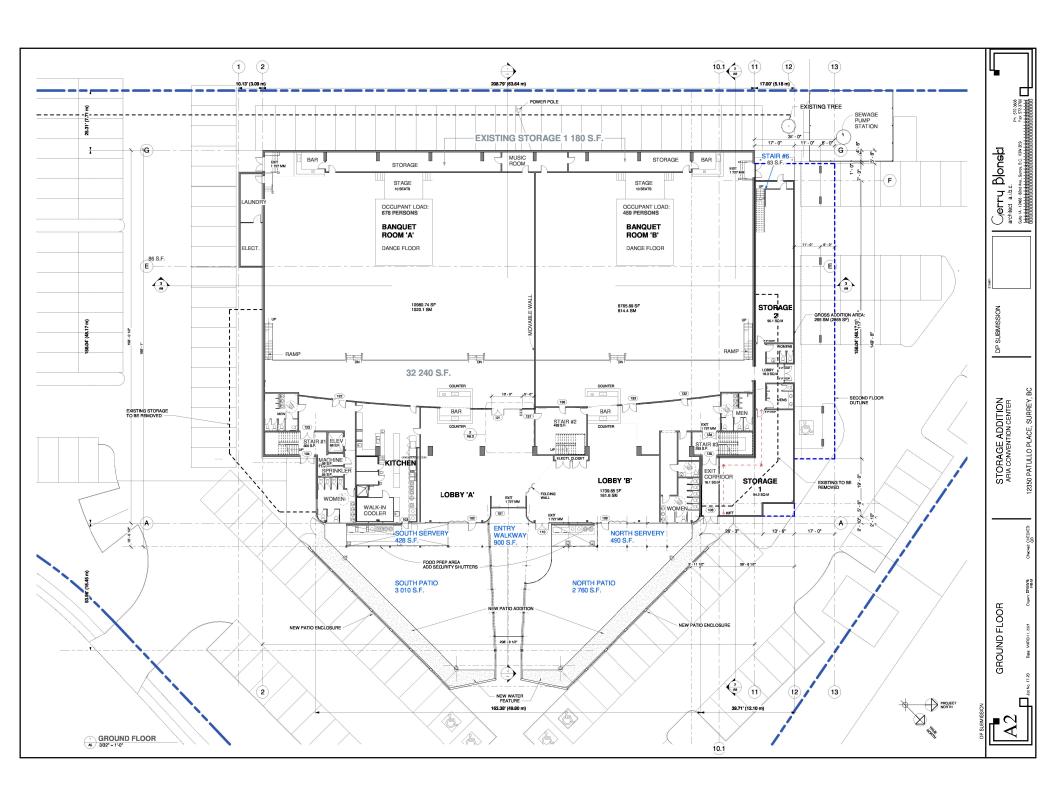

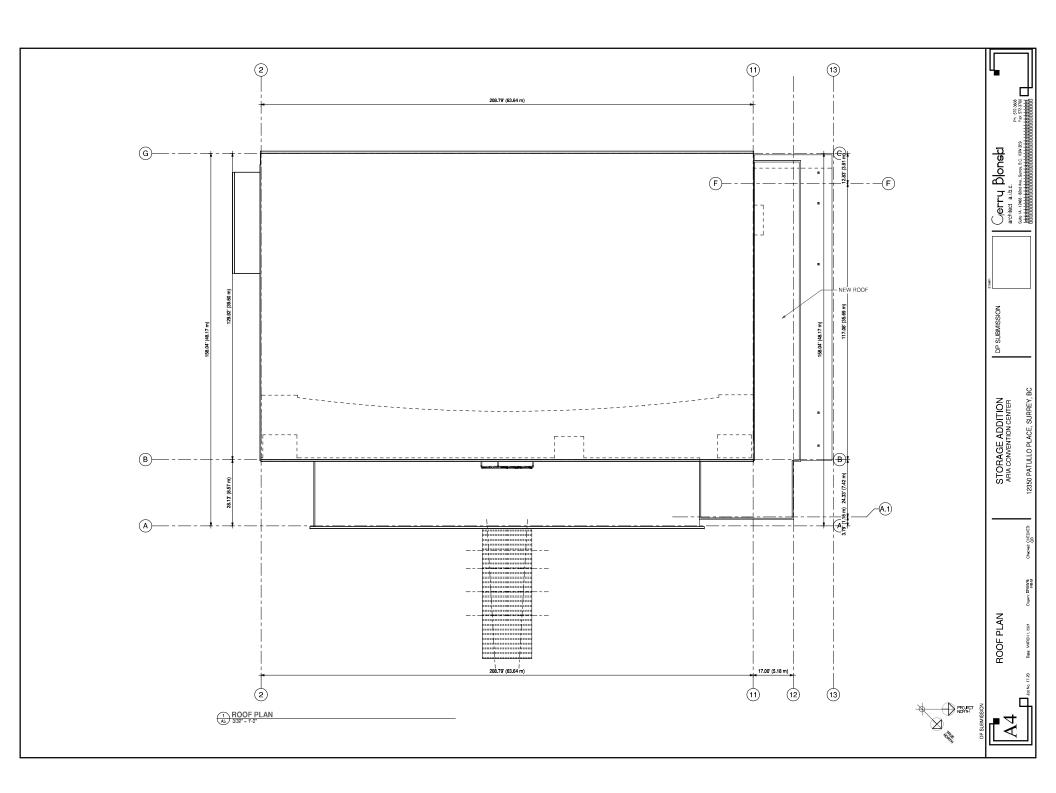

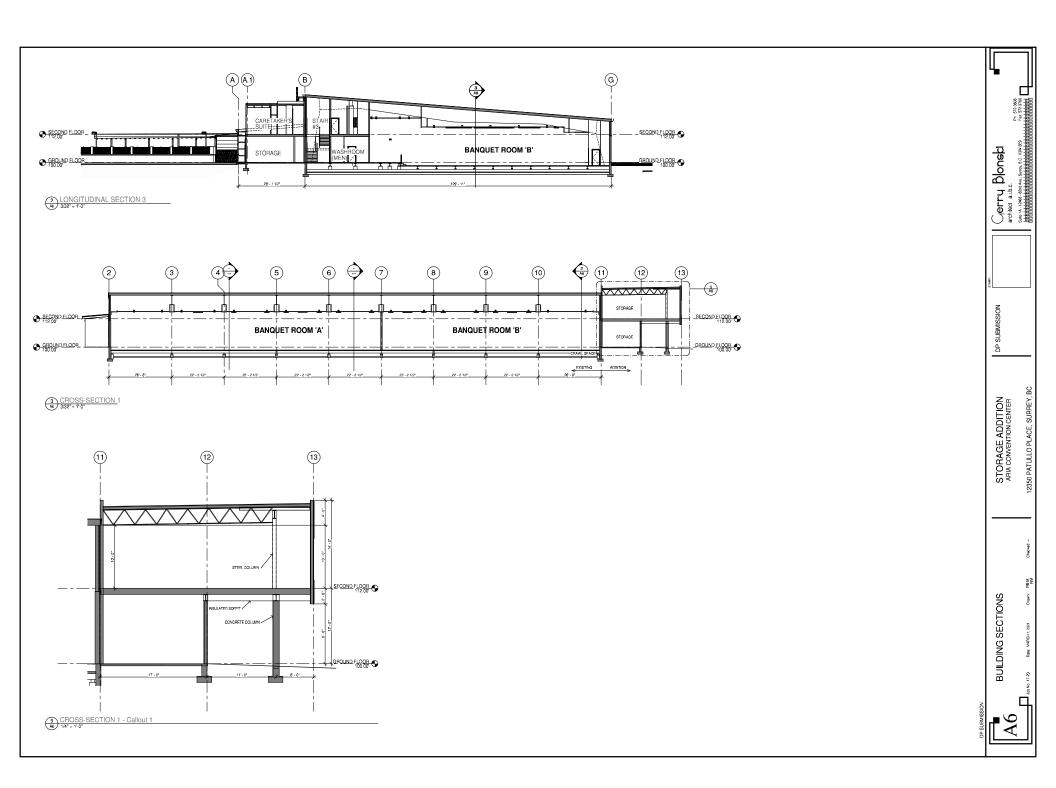

# MIKE FADUM AND ASSOCIATES LTD. VEGETATION CONSULTANTS

# **Tree Preservation Summary**

**Surrey Project No: TBD** 

Address: 12350 Pattullo Place, Surrey, BC Registered Arborist: Corey Plester #PN-8523A


On-Site Trees	Number of Trees
Protected Trees Identified	
(on-site and shared trees, including trees within boulevards and proposed streets	50
and lanes, but excluding trees in proposed open space or riparian areas)	
Protected Trees to be Removed	1
Protected Trees to be Retained	49
(excluding trees within proposed open space or riparian areas)	49
Total Replacement Trees Required:	
Relocated Trees Requiring 1 to 1 Replacement Ratio  0 X one (1) = 0  - All other Trees Requiring 2 to 1 Replacement Ratio  1 X two (2) = 2	2
Replacement Trees Proposed	TBD
Replacement Trees in Deficit	TBD
Protected Trees to be Retained in Proposed [Open Space / Riparian Areas]	NA

Off-Site Trees	Number of Trees
Protected Off-Site Trees to be Removed	0
Total Replacement Trees Required:	
<ul> <li>Alder &amp; Cottonwood Trees Requiring 1 to 1 Replacement Ratio</li> <li>0 X one (1) = 0</li> </ul>	0
- All other Trees Requiring 2 to 1 Replacement Ratio	
0 X two (2) = 0	
Replacement Trees Proposed	NA
Replacement Trees in Deficit	NA

Summary report and plan prepared and submitted by: Mike Fadum and Associates Ltd.		
Signature of Arborist:	Date: February 2, 2022	





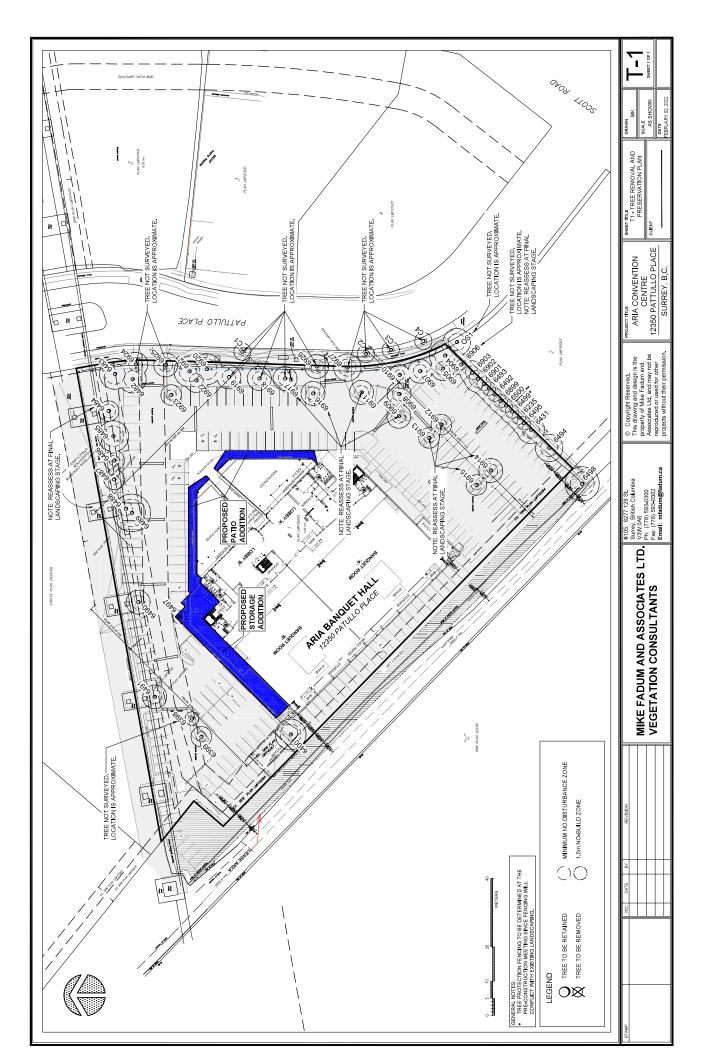

### **CITY OF SURREY**

(the "City")

### **DEVELOPMENT VARIANCE PERMIT**

NO.: 7919-0017-00

Issued To:

("the Owners")

Address of Owner:

- This development variance permit is issued subject to compliance by the Owner with all 1. statutes, by-laws, orders, regulations or agreements, except as specifically varied by this development variance permit.
- This development variance permit applies to that real property including land with or 2. without improvements located within the City of Surrey, with the legal description and civic address as follows:

Parcel Identifier: 023-376-813

Lot 1 Section 17 Block 5 North Range 2 West New Westminster District Plan LMP27431 12333 - Pattullo Place

Lot 1 Section 17 Block 5 North Range 2 West New Westminster District Plan LMP30003 12350 - Pattullo Place

Parcel Identifier: 023-529-687


Parcel Identifier: 023-376-821 Lot 2 Section 17 Block 5 North Range 2 West New Westminster District Plan LMP27431 12345 - Pattullo Place

(the "Land")

- Surrey Zoning By-law, 1993, No. 12000, as amended is varied as follows: 3.
  - (a) In Table D.1 of Part 5 Off-Street Parking and Loading/Unloading, the required offstreet parking spaces for an eating establishment (banquet hall) with a total floor area of 4,703 square metres (including a 75 square metre caretaker suite) is reduced from 650 parking spaces to 430 parking spaces.
  - (b) Section A.3(a)(b) of Part 5 Off-Street Parking and Loading/Unloading is varied to allow for parking spaces associated with an eating establishment (banquet hall) located at 12350 Patullo Place to be located on non-abutting or contiguous lots located at 12333 and 12345 Pattullo Place.

	(c)	Section A.4(a)ii. of Part 5 Off-Street Parking and Loading/Unloading is varied to allow parking lots located at 12333 and 12345 Pattullo Place to be surfaced with gravel.
4.	structu this de additio	evelopment variance permit applies to only that portion of the buildings and ares on the Land shown on Schedule A which is attached hereto and forms part of evelopment variance permit. This development variance permit does not apply to ons to, or replacement of, any of the existing buildings shown on attached Schedule ch is attached hereto and forms part of this development variance permit.
5.		and shall be developed strictly in accordance with the terms and conditions and cons of this development variance permit.
6.	constr	evelopment variance permit shall lapse if the Owner does not substantially start any uction with respect to which this development variance permit is issued, within two rs after the date this development variance permit is issued.
7.		rms of this development variance permit or any amendment to it, are binding on all s who acquire an interest in the Land.
8.	This d	evelopment variance permit is not a building permit.
	ORIZIN D THIS	IG RESOLUTION PASSED BY THE COUNCIL, THE DAY OF , 20 . DAY OF , 20 .
		M
		Mayor – Doug McCallum

City Clerk – Jennifer Ficocelli

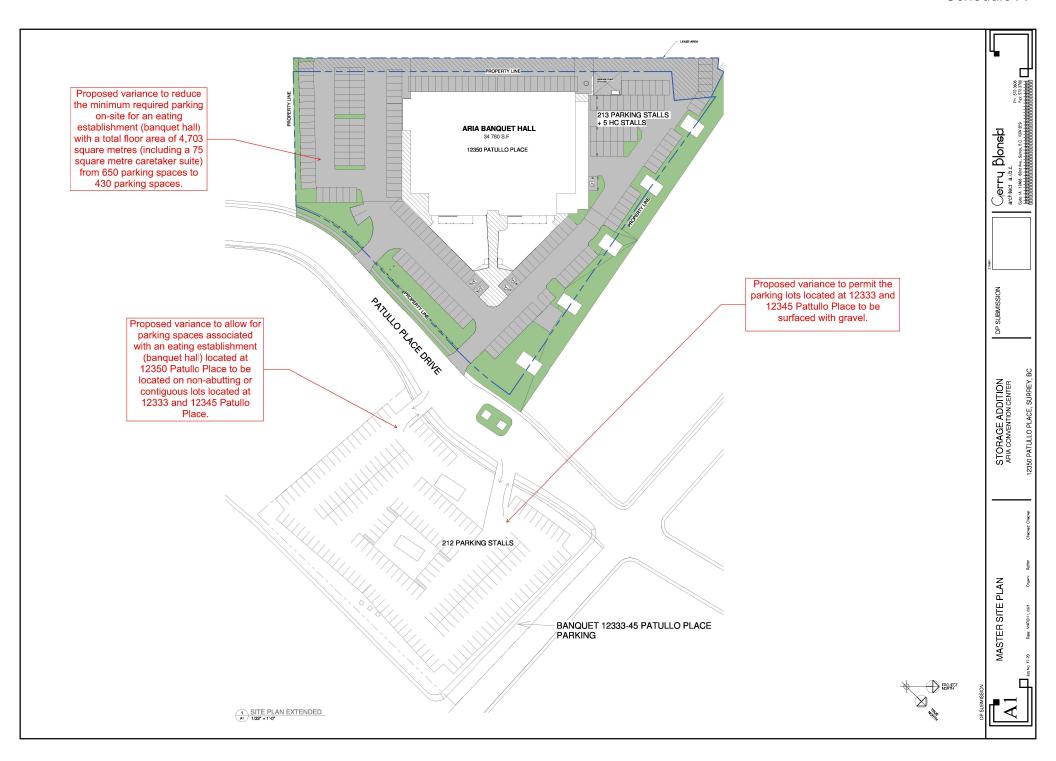



#### R.F. BINNIE & ASSOCIATES LTD.

300 - 4940 Canada Way, Burnaby, BC VSG 4K6 TEL 604 420 1721 BINNIE.com

# Memorandum

То:	Parm Sanghera, Aria Convention Centre	From:	Ava Li, Binnie Kelly Bullivant, Binnie
Cc:	Gerry Blonski, Gerry Blonski Architect	Date:	June 28, 2022
Project Title:	Aria Convention Centre	File No.:	19-1125-05
Re:	Parking Study Memorandum - FINAL Rev.4		

### 1 INTRODUCTION

### 1.1 Background

R.F. Binnie & Associates Ltd. (Binnie) was retained by Aria Convention Centre (the Client) to prepare a parking study for the existing Aria Banquet Hall and Convention Centre (Aria Convention Centre), located at 12350 Pattullo Place in the City of Surrey (the City).

The objectives of this parking review are to:

- Review the existing building layout and proposed expansion site plan for the Aria Convention Centre:
- Review the existing on-site parking requirement based on the City's bylaw and parking generation rates published by the Institute of Transportation Engineers (ITE);
- Perform field visits to observe parking demands when events are held at Aria Convention Centre; and
- Propose strategies to address the parking shortfall based on field observations.

### 1.2 Building Layout and Parking Provision

The Aria Convention Centre is located at 12350 Pattullo Place, just south of King George Boulevard and between Highway 17 and 120 Street. The project site is easily accessed via several adjacent arterial roadways, various bus routes that are part of TransLink's Frequent Transit Network (FTN), and the Scott Road SkyTrain Station which is located approximately 500 m east of the convention centre.

Based on information provided by the Client on June 10, 2022, the existing Aria Convention Centre building has a net floor area of 4,036 m<sup>2</sup> (including patio space) and a maximum capacity of 1,200 guests. The net floor area is comprised of 3,702 m<sup>2</sup> of indoor space and 334 m<sup>2</sup> of outdoor patio space.

Based on field visits conducted by Binnie, 231 parking spaces were counted on-site and approximately 156 non-marked parking spaces are available in a gravel parking lot located at 12333-45 Pattullo Place, just east of the convention centre, for a total of 387 parking spaces available for guests. There are also approximately 20 on-street parking spaces available on the west site of Pattullo Place and a



pay parking lot just north of the convention centre at 11125 124 Street that accommodates a further 97 parking spaces.

An expansion is currently being proposed for the convention centre to increase the storage space within the building (net addition of 392 m<sup>2</sup>), to provide an on-site caretaker suite (75 m<sup>2</sup>), and to increase the patio space outside the building (201 m<sup>2</sup>), while maintaining the current assembly area and guest capacity. The proposed expansion will increase the Aria Convention Centre to 4,169 m<sup>2</sup> of indoor space and 534 m<sup>2</sup> of outdoor patio space, for a total net floor area of 4,703 m<sup>2</sup>.

The project location is shown in Figure 1-1.



Figure 1-1: Project Location

### 2 PARKING SUPPLY AND DEMAND ESTIMATE

The planned expansion of the storage space is not expected to generate new parking demand as it will not increase the current seating capacity of the convention centre; as such, it is expected that the existing building's parking demand will be maintained.

The caretaker suite is expected to generate a nominal amount of parking.

The outdoor patio space is noted to be supplementary to the indoor assembly area by providing additional ambiance and its use is weather dependent. As the patio space is physically separated from the banquet rooms by the lobby and bar areas, it cannot feasibly accommodate additional seating for an event. As such, the planned expansion of the outdoor patio space is not expected to generate new parking demand and the existing building's parking demand will be maintained.



### 2.1 Bylaw Requirement

Based on the City's current zoning bylaw, 12000 Part 5: Off-Street Parking and Loading/Unloading, banquet halls require 14 parking spaces per 100 m<sup>2</sup> of gross floor area, balconies, terrace, and deck when the total building area is greater than or equal to 950 m<sup>2</sup>. Caretaker units generally require 2 parking spaces to be provided.

Given the proximity of the Aria Convention Centre to the FTN and SkyTrain, a 10% parking relaxation of the City's bylaw requirement is requested.

It is noted that a significant portion of the convention centre's floor area includes a planned expansion of storage space and patio space that is not expected to increase the current building's parking demand. As such, a variance to exclude the proposed increase of storage space and the patio in its entirety is requested.

The required and requested number of parking spaces necessary to satisfy the City's requirements are shown in Table 2-1.

Table 2-1: Required and Requested Parking Spaces

	Floor Area (m²)	Required Parking	Requested Parking
Assemby Area	3702	518	518
Storage Space	392	55	(1 sa)
Patio Space	534	75	348
Caretaker Suite	75	2	2
sub-total	4703	650	520
10% FTN Relaxation	1 ×	-65	-52
Total	4703	585	468

To accommodate the caretaker suite and the remaining floor area of 4,628 m² (including patio space) once the expansion is complete, 650 parking spaces will be necessary to satisfy the City's bylaw requirement. It is noted that this requirement is drastically higher than what is currently observed for events at Aria Convention Centre, which is discussed further in Section 4. Based on site visits conducted by Binnie, the maximum parking demand for the study site is expected to be 371 parking spaces, which is noted to be just slightly more than half of the City's bylaw requirement.

If the variance requests to provide a 10% relaxation to parking requirements due to the convention centre's proximity to the FTN and SkyTrain, and to exclude the storage space and patio space from the parking requirement calculation are granted, then only 468 parking spaces would be necessary to satisfy the City's requirements.

### 2.2 Parking Generation Rates

The parking demand for the study site was estimated based on the parking generation rates published in ITE's Parking Generation Manual, 5th Edition. The Convention Centre (ITE Ref. 595) land use was assumed to be representative of the Aria Convention Centre.

Based on the average parking rate per attendee, it is estimated that the maximum parking demand for the convention centre is 372 parking spaces on weekdays and 480 parking spaces on weekends given its 1,200-guest capacity.

It is noted that the requested number of parking spaces necessary to satisfy the City's requirements are generally in line with the estimated weekend ITE parking generation rates.



### 2.3 Proposed Parking Supply

Based on the proposed site plan provided by the Client, there will be a total of 430 parking spaces provided for convention centre guests and the caretaker unit after the proposed expansion is complete, with 218 parking spaces on-site and 212 parking spaces at the gravel parking lot located at 12333-45 Pattullo Place. Curb stops will be used at the gravel lot to delineate each parking space.

To supplement the provided parking supply, the Client has entered into an agreement to lease space from BC Hydro on the adjacent railway property to provide additional on-site parking spaces (inclusive of the 218 spaces noted above). The Client has also entered into an agreement with an adjacent property owner to allow vehicles for the convention centre to park in the 26 spaces available at 12355 Pattullo Place after 6:30 PM. There are also 20 on-street parking spaces available on the west site of Pattullo Place and 97 parking spaces available at a pay parking lot just north of the convention centre.

The provided and supplemental parking supply is shown in Table 2-2.

Table 2-2: Provided and Supplemental Parking Supply

	Location	Parking Supply
-	On-Site	218
Provided Parking	12333-45 Pattullo Place	212
	sub-total	430
	On-street	.20
	12355 Pattullo Place	26
Supplemental Parking	Pay Parking	97
r arming	sub-total	143
	Total	573

As noted in Section 2.1, the City's parking bylaw requires 650 parking spaces; therefore, the provided parking supply of 430 parking spaces does not meet the City's parking requirements and there is a shortfall of 155 parking spaces. Taking the supplemental parking supply of 143 parking spaces surrounding the convention center into consideration would reduce this shortfall to 12 parking spaces.

If the variance requests to provide a 10% relaxation to parking requirements and to exclude the storage space and patio space from the parking requirement calculation are granted, then only 468 parking spaces would be necessary to satisfy the City's parking bylaw. While the provided parking supply of 430 parking spaces still does not meet the City's parking requirements, the shortfall is reduced to only 38 parking spaces. With the addition of the surrounding supplemental parking supply, it is expected that the parking requirements for the Aria Convention Centre would be accommodated.

The variance for the required and requested parking spaces are shown in Table 2-3.

Table 2-3: Parking Space Variance

	Required Parking	Requested Parking
Per City's Bylaw	650	468
Provided Parking	4	30
Variance	155	38
Supplemental Parking	1	43
Variance	12	n/a



## 3 SITE OBSERVATIONS

Existing parking data was collected at the Aria Convention Centre on three separate occasions:

November 29<sup>th</sup>, 2019, December 4<sup>th</sup>, 2019, and January 25<sup>th</sup>, 2020. The site visits were conducted on event days when the facility was expected to be operating at a "typical" capacity or near its maximum capacity to capture both the typical and maximum parking demand.

## 3.1 November 29th, 2019 Site Visit

The first site visit was conducted on Friday, November 29th, 2019, at 7 PM for two concurrent events running from 6 PM to 12 AM with approximately 600 guests total. The two events were a wedding and a social gathering.

Out of the 231 available on-site parking spaces, a total of 153 parked cars were observed on-site. A total of 16 cars were parked at the property located east of the convention centre, and 6 cars were parked on the west side of Pattullo Place adjacent to the convention centre. As the on-site parking was not at its capacity, it is assumed that all guests parked on-site. The parking distribution for this site visit is shown in **Figure 3-1**.

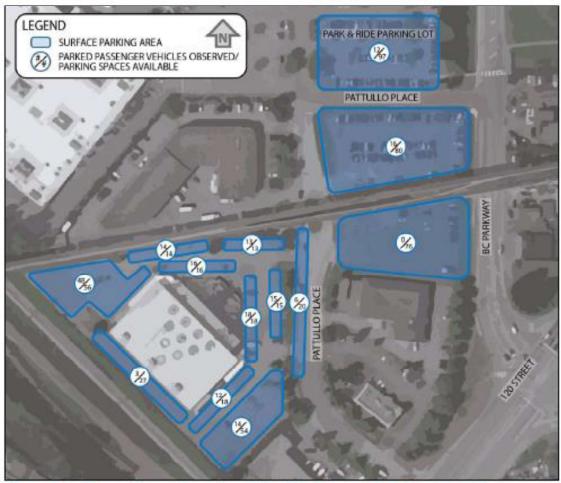


Figure 3-1: Observation on November 29th, 2019, Between 7:00 PM - 8:00 PM



# 3.2 December 4th, 2019 Site Visit

The second site visit was conducted on Wednesday, December 4<sup>th</sup>, 2019, at 10 AM for an event running from 9 AM to 2 PM with approximately 1,000 guests. The event was an education career fair for high school students.

Out of the 231 available on-site parking spaces, a total of 159 parked cars and 7 school buses were observed on-site. A total of 130 cars and 8 trailer trucks were parked at the property located east of the convention centre, and 3 cars were parked on the west side of Pattullo Place adjacent to the convention centre. The Client confirmed that the 8 trailer trucks parked on the separate property are not part of the event-generated traffic. As the on-site parking was not at its capacity, it is assumed that all guests parked on-site.

The parking distribution for this site visit is shown in Figure 3-2.

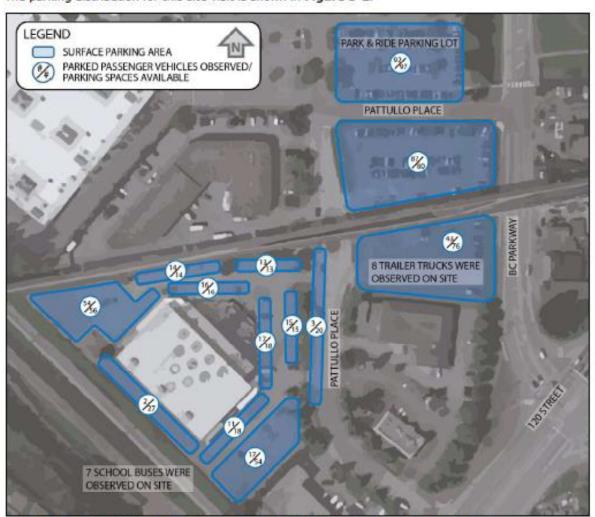


Figure 3-2: Observation on December 4th, 2019, Between 10:00 AM - 11:00 AM



# 3.3 January 25th, 2020 Site Visit

The third site visit was conducted on Saturday, January 25th, 2020, at 7 PM for two concurrent events running from 6 PM to 12 AM with approximately 900 guests total. The two events were a work party and a wedding.

Out of the 231 available on-site parking spaces, a total of 223 parked cars were observed on-site, which is generally considered to be at capacity. A total of 55 cars were parked at the property located east of the convention centre, and 12 cars were parked on the west side of Pattullo Place adjacent to the convention centre. It is assumed that the cars parked at the property located east of the convention centre are part of the convention centre generated traffic as the on-site parking was at capacity.

The parking distribution for this site visit is shown in Figure 3-3.

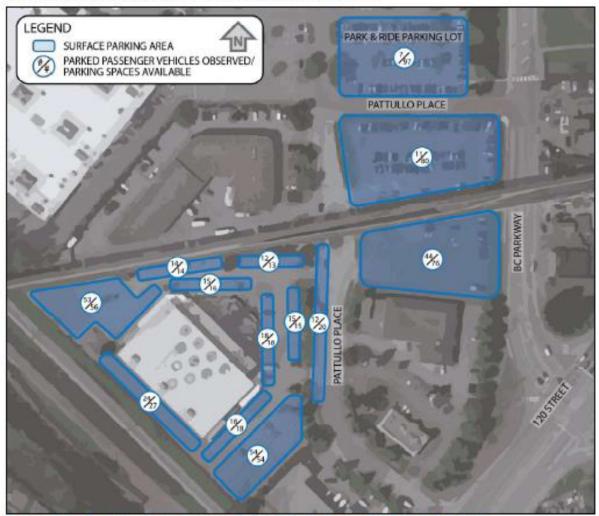


Figure 3-3: Observation on January 25th, 2020, Between 7:15 PM - 8:15 PM



### 4 FINDINGS

Based on the site visit observations, there is a maximum parking demand rate of 0.31 parking spaces per guest. As the Aria Convention Centre has a maximum capacity of 1,200 guests, it is estimated that the maximum observed parking demand for the study site is 371 parking spaces.

This demand is noted to be significantly lower than the City's bylaw requirement, on-par with ITE's weekday parking generation rate, and moderately lower than ITE's weekend parking generation rate. Given that convention centres generally have many layouts for several different types of events, parking rates that are determined based on the maximum occupancy rate of the facility rather than the gross floor area of the facility are expected to be provide more accurate demand estimates.

The parking demand ratios from the site visits are summarized in Table 4-1.

Table 4-1: Parking Ratio Summary

Event Date	#Guests	# Parked Cars	Parking Ratio (to # Guests)
November 29th, 2019	600	169	0.28
December 4th, 2019	1000	289	0.29
January 25th, 2020	900	278	0.31

Based on the maximum observed parking demand of 371 parking spaces, the proposed parking supply of 430 parking spaces will be able to accommodate any event at the Aria Convention Centre. If there is ever a shortfall in the parking supply, there are additional parking opportunities in the vicinity of the study site, including on-street parking on the west side of Pattullo Place, the paid parking lot at 11125 124 Street to the north of the convention centre, and the evening-only parking agreement at 12355 Pattullo Place.

It is noted that the paid parking lot at 11125 124 Street is generally used as a park-and-ride facility by SkyTrain users and is typically only busy during standard work hours on weekdays. The Client has noted that larger events generally take place outside of standard work hours, i.e., on weekends or at nighttime. The field visits conducted on November 29<sup>th</sup>, 2019 and January 25<sup>th</sup>, 2020 were during large evening events and it is noted that the usage of this parking lot was minimal at that time. Therefore, if it is anticipated that an event will require more than 371 parking spaces, the Client could make advance arrangements for guests to park their cars at the adjacent pay parking lot just north of the convention centre.

As such, the site's variance request to reduce parking requirements by 10% due to FTN and SkyTrain proximity and to exclude the storage and patio spaces from the parking requirement calculation as they will not increase the current seating capacity and subsequent parking demand is considered acceptable from a transportation engineering standpoint based on the existing field conditions.

Memorandum Prepared by:

N N DLL-VAROT

# 84 (2)

Kelly Bullivant, P.Eng.


Senior Transportation Engineer

Memorandum Reviewed by:

Ava Li, P.Eng. Project Manager

# **APPENDIX A**

PROPOSED SITE PLAN

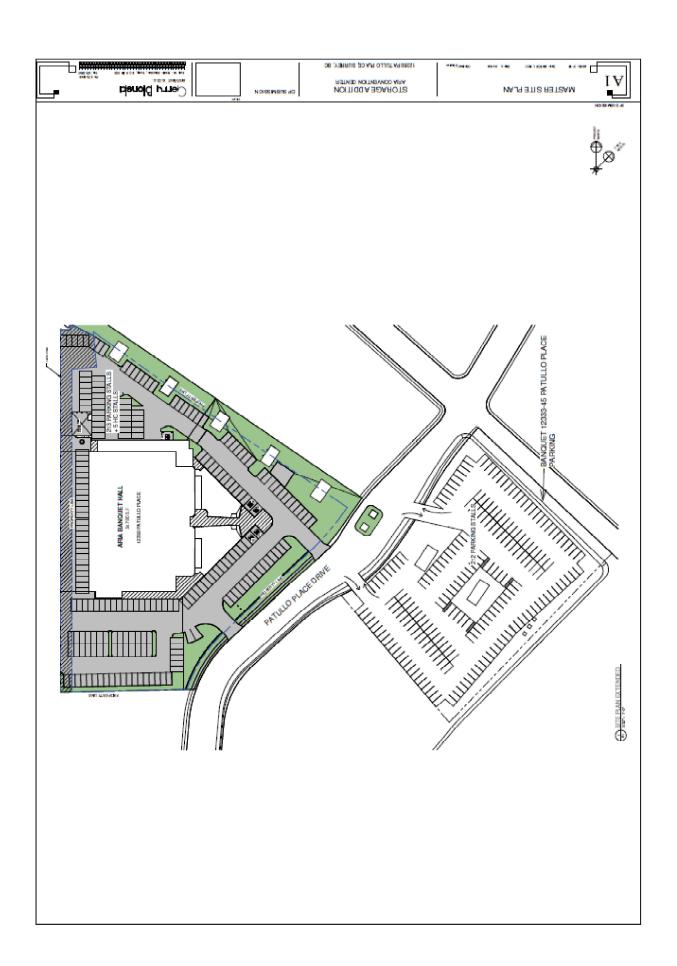



# INTER-OFFICE MEMO

Regular Council - Public Hearing H. 16 7919-0017-00 Monday September 25, 2023 Supplemental Information

TO: **Mayor and Council** 

FROM: City Clerk and Director of Legislative Services

DATE: September 22, 2023 FILE: 7919-0017-00

RE: Regular Council Public Hearing Meeting – Item H16– Application 7919-0017-00

Item H<sub>1</sub>6 on the September 25, 2023, Regular Council Public Hearing meeting agenda is out of order and will be removed from the agenda.

At the September 11, 2023 Regular Council Land Use meeting, Council considered application 7919-0017-00 under Item C.4 and passed the following resolution:


"That Application 7919-0017-00 be referred to staff for an updated parking study."

Accordingly, this item is not in order for consideration by Council at this time and will be brought forward to a future Council meeting.

Jennifer Ficocelli

troalli

City Clerk and Director of Legislative Services

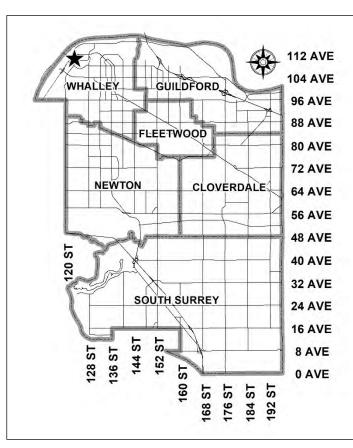

# City of Surrey ADDITIONAL PLANNING COMMENTS Application No.: 7919-0017-00

Planning Report Date: September 11, 2023

### PROPOSAL:

• Development Permit

• Development Variance Permit


to address parking requirements, including proposed off-site surface parking lots, and to increase allowable building height to permit already constructed and proposed additions and modifications to an existing banquet hall.

LOCATION: 12333 - Pattullo Place

12350 - Pattullo Place 12345 - Pattullo Place

ZONING: CHI

OCP DESIGNATION: Mixed Employment NCP DESIGNATION: Highway Commercial

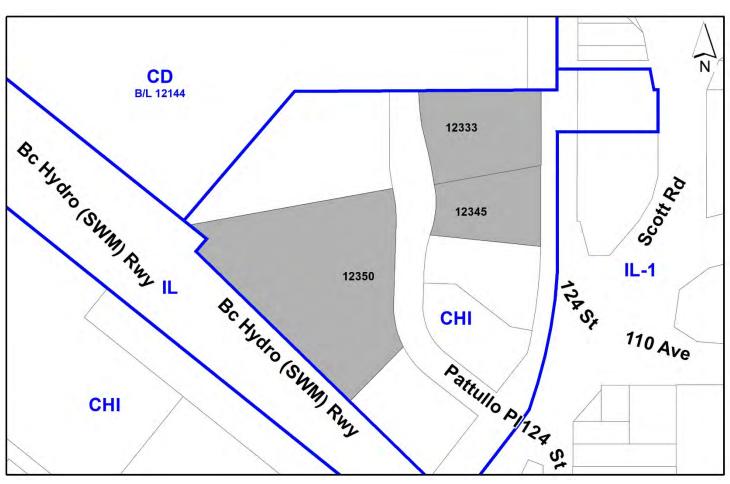

### RECOMMENDATION SUMMARY

- Approval to draft an amended Development Permit for Form and Character.
- Approval for an amended Development Variance Permit to proceed to Public Notification.

### DEVIATION FROM PLANS, POLICIES OR REGULATIONS

- The applicant is seeking the following variances in order to address parking requirements for an existing operational banquet hall:
  - o to reduce the minimum number of off-street parking spaces required for an eating establishment (banquet hall) from 695 to 420;
  - o to allow for parking spaces for the banquet hall use located at 12350 Pattullo Place to be provide on non-abutting or contiguous lots located at 12333 and 12345 Pattullo Place; and
  - o to allow the proposed surface parking lots at 12333 and 12345 Pattullo Place to be surfaced with gravel.
- The applicant is also proposing to increase the allowable building height from 9 metres to 13.1 metres to accommodate the banquet hall building.

### RATIONALE OF RECOMMENDATION

- Council considered the subject Development Permit and Development Variance Permit application at the July 11, 2022 Regular Council Land Use Meeting . At that time, the applicant was proposing the following variances:
  - o to reduce the minimum number of off-street parking spaces required for an eating establishment (banquet hall) from 650 to 430;
  - o to allow for parking spaces for the banquet hall use located at 12350 Pattullo Place to be provide on non-abutting or contiguous lots located at 12333 and 12345 Pattullo Place; and
  - o to allow the proposed surface parking lots at 12333 and 12345 Pattullo Place to be surfaced with gravel.
- The requested variances were to address parking requirements for the existing operational banquet hall (Aria Convention Centre).
- After Public Notification, the variances were supported by Council on July 25, 2022.

- Since that time, the applicant has clarified the proposal, noting that the previous building and parking calculations were incorrect, the correct data includes an additional 703.3 square metres of floor area. As such, the applicant has requested that the Development Variance Permit be amended to modify the requested relaxation to be from 695 required parking spaces to 420 parking spaces. The applicant has also clarified the actual building height, which triggers an additional variance to increase the allowable building height under the CHI Zone.
- The rationale to support the parking relaxation is unchanged from the initial Planning Report dated July 11, 2022 (attached).
- The subject banquet hall building is in an employment area and is situated in the centre of the property with surrounding parking and landscaping. The increased height of the building is not anticipated to impact surrounding properties.
- It is recommended that Council approve an amended Development Variance Permit No. 7919-0017-00, including the updated requested parking space reduction and building height increase, to proceed to Public Notification.
- It is also recommended that Council authorize staff to draft an amended Development Permit No. 7919-0017-00 generally in accordance with the updated site plan attached as Appendix I.
- The amended Development Variance Permit and Development Permit will authorize exterior renovations to the existing banquet hall building previously completed without permits and accommodate the further additions to the banquet hall as proposed by the applicant.

### RECOMMENDATION

The Planning & Development Department recommends that:

- 1. Council approve an amended Development Variance Permit No. 7919-0017-00 (Appendix II) varying the following, to proceed to Public Notification:
  - (a) to reduce the minimum number of off-street parking spaces required for an eating establishment (banquet hall) from 695 to 420;
  - (b) to allow for parking spaces for the banquet hall use located at 12350 Pattullo Place to be provide on non-abutting or contiguous lots located at 12333 and 12345 Pattullo Place;
  - (c) to allow the proposed surface parking lots at 12333 and 12345 Pattullo Place to be surfaced with gravel; and
  - (d) to increase the allowable building height for the banquet hall building, under the CHI Zone, from 9 metres to 13.1 metres.
- 2. Council authorize staff to draft amended Development Permit No. 7919-0017-00 generally in accordance with the updated site plan attached as Appendix I.
- 3. Council instruct staff to resolve the following issues prior to final adoption:
  - (a) Completion of all conditions of approval identified in the original Planning Report for Development Application No. 7919-0017-00 dated July 11, 2022.

### SITE CONTEXT & BACKGROUND

Direction	Existing Use	NCP Designation	<b>Existing Zone</b>
		*** 1	27.77
Subject Site	Aria Convention	Highway	CHI
	Centre and vacant	Commercial, Parks	
	gravel lots	and Open Spaces	
North:	Highway	Highway	CHI and CD
	commercial uses	commercial uses	Bylaw 12144
	and parking for	and parking for	
	large multi-	large multi-purpose	
	purpose building	building	

Direction	Existing Use	NCP Designation	<b>Existing Zone</b>
East (Across 124 Street):	Autobody repair, used car dealership	Highway Commercial	IL-1, CHI
Southeast:	Highway commercial uses	Highway Commercial	СНІ
West (Across BC Hydro (SWM) Railway):	Proposed two- storey industrial warehouse building with upper floor office space. Supported by Council on January 25, 2021.	Business/Residential Park	IL-1

### **Context & Background**

- The three subject sites, 12333, 12345 and 12350 Pattullo Place, are either adjacent or directly encumbered by a TransLink Skytrain guideway. The sites are designated Mixed Employment in the Official Community Plan (OCP) and Highway Commercial in the South Westminster Neighbourhood Concept Plan (NCP). The sites are currently zoned Highway Commercial Industrial Zone (CHI).
- The existing banquet hall facility located on 12350 Pattullo Place and now formally known as the Aria Convention Centre was originally constructed as part of Application No. 7996-0110-00, at which time the building was intended for a bowling centre and entertainment complex. The building has subsequently been converted to a banquet hall facility.
- Building permits were issued in 2014 permitting building additions resulting in a total floor area of 3702.1 square metres. Further additions have been added to the buildings without proper permits or approvals, however the applicant is working with Building Division staff to obtain the appropriate building permits for unauthorized work.
- Offsite parcels located at 12333 and 12345 Pattullo Place, are also owned by the same owner of 12350 Pattullo Place. These empty gravel lots are proposed to accommodate parking for the banquet hall. It is anticipated that these parcels will be redeveloped in the future.
- The subject Development Permit and Development Variance Permit is intended formalize previously constructed work on the banquet hall, and to accommodate further additions, and to bring the proposed parking arrangement into compliance with the Zoning By-law.
- Council considered the subject application at the July 11, 2022 Regular Council Land Use Meeting . At that time, the applicant was proposing the following variances:
  - to reduce the minimum number of off-street parking spaces required for an eating establishment (banquet hall) from 650 to 430;

- o to allow for parking spaces for the banquet hall use located at 12350 Pattullo Place to be provide on non-abutting or contiguous lots located at 12333 and 12345 Pattullo Place; and
- o to allow the proposed surface parking lots at 12333 and 12345 Pattullo Place to be surfaced with gravel.
- The requested variances were to address parking requirements for the existing operational banquet hall. After Public Notification, the variances were supported by Council on July 25, 2022.
- Since that time, the applicant has clarified the proposal which has resulted in an additional 703.3 square metres of floor area that was previously miscalculated in the original submission. As such, the applicant has requested that the Development Variance Permit be amended to modify the requested relaxation to be from 695 required parking spaces to 420 parking spaces. The applicant has also clarified the building height which triggers an additional variance to increase the allowable building height under the CHI Zone.

### **DEVELOPMENT PROPOSAL**

### **Planning Considerations**

- Since the subject application was initially considered by Council, the applicant has corrected the floor area calculations from 4,703 square metres to 5,406.3 square metres (including building interior and patio space). The building data, as revised, complies with the floor area ratio, lot coverage, and setbacks of the CHI Zone.
- Based on the banquet hall facility's various components, which include the assembly area, storage space, patio space and a caretaker suite, the total required parking is 695 parking spaces under the Zoning By-law. There are a total of 206 parking spaces on the banquet hall site. The applicant is proposing to modify the existing gravel lots at 12333 and 12345 Pattullo Place with appropriate curb stops to delineate an additional 214 parking spaces resulting in a total of 420 parking spaces).

• Development details are provided in the following table:

	Proposed
Lot Area	
Gross Site Area:	1.22 hectares
Road Dedication:	N/A
Undevelopable Area:	N/A
Net Site Area:	1.22 hectares
Number of Lots:	1
Building Height:	13.1 metres
Unit Density:	N/A
Floor Area Ratio (FAR):	0.35

### Referrals

Engineering: The Engineering Department has no objection to the project as

outlined in the original Engineering Review.

Ministry of Transportation

& Infrastructure (MOTI):

Ministry of Transportation & Infrastructure has no objections.

Surrey Fire Department: The Surrey Fire Department has no objections.

Translink: TransLink has no objections, subject to a construction

management plan for works adjacent the SkyTrain guideway.

## **Transportation Considerations**

• The banquet hall facility requires 695 parking spaces (693 for banquet hall based on the required parking rate of 14 spaces/100 sq.m of floor area, excluding stairways and mechanical rooms, plus 2 parking spaces for caretaker suite) and the applicant is providing 420 parking spaces, combined between the banquet hall site and on the two properties located on the east side of Pattullo Place. As a result of this shortfall in total parking spaces, a variance is required (see Variances section).

- The rear of the site contains parking spaces as part of a lease agreement with BC Hydro, where parking is provided over top of an existing BC Hydro Right of Way (ROW) on the property. These spaces are included as part of the total parking count.
- There are two (2) driveway accesses for the banquet hall site (12350 Pattullo Place) and an additional two (2) driveway accesses for the offsite gravel parcels 12333 and 12345 Pattullo Place.
- Registration of a formal parking easement/shared parking agreement will be required in order
  to ensure ongoing access to the 214 offsite parking on 12333 and 12345 Pattullo Place for use by
  the banquet hall.

### **POLICY & BY-LAW CONSIDERATIONS**

### **Regional Growth Strategy**

- The subject site is designated "General Urban" under the Metro Vancouver Regional Growth Strategy (RGS).
- The existing use complies with the RGS designation.

### Official Community Plan

### Land Use Designation

- The subject site is designated "Mixed Employment" in the Official Community Plan (OCP).
- The existing use complies with the OCP designation.

### **Secondary Plans**

### Land Use Designation

• The existing use complies with the "Highway Commercial" Designation in the South Westminster Neighborhood Concept Plan (NCP).

### **Variances**

- The applicant is requesting the following variances, based on the revised proposal:
  - o to reduce the minimum number of off-street parking spaces required for an eating establishment (banquet hall) from 695 to 420;
  - o to allow for parking spaces for the banquet hall use located at 12350 Pattullo Place to be provide on non-abutting or contiguous lots located at 12333 and 12345 Pattullo Place;
  - o to allow the proposed surface parking lots at 12333 and 12345 Pattullo Place to be surfaced with gravel; and
  - o to increase the allowable building height for the banquet hall building, under the CHI Zone, from 9 metres to 13.1 metres.
- The applicant retained a Transportation Consultant (Binnie Engineering) to prepare a parking study for the site. The study included three site visits during various events at the banquet hall. The study observed a maximum parking demand of 371 parking spaces and therefore concluded that the proposed 420 parking spaces will be sufficient to accommodate the banquet hall operations. Council previously supported a reduction from 650 spaces to 430 spaces on the site. The City's Transportation Division has confirmed that this same parking study is acceptable for the revised parking proposal.
- In addition to the 420 parking spaces available on the subject properties, there are approximately 20 on-street parking spaces available on the west site of Pattullo Place and a pay parking lot just north of the site at 11125-124 Street that accommodates a further 97 parking spaces. In addition, the applicant has also entered into an agreement with an adjacent property owner to allow vehicles for banquet hall patrons to park in the 26 spaces available at 12355 Pattullo Place after 6:30 pm.
- City staff also reviewed the proposed parking supply and support the proposed parking reduction. Staff note the following rationale in support of the variance:
  - The proposed patio area will not be a fully enclosed/covered and is located away from the main assembly/seating area, so the space is supplementary and not expected to generate parking demand;

- A portion of the banquet hall (100 sq. m) is reserved for storing a large inventory of furniture and supplies to operate;
- The building contains a caretaker suite with 3 bedrooms, which will be parked at the same rate as ground oriented multi-family developments in the City (2 spaces total);
- The site is in close proximity to Scott Road Skytrain station (approximately 300 m) which results in some guests and staff utilizing transit to attend events; and
  - Given the proximity of the subject property to the Frequent Transit Network (FTN), including Scott Road SkyTrain Station, an additional 10% reduction in the rate used to calculate the required parking for the banquet hall use has merit.
- Given the nature of the events and guest arrival patterns at this banquet hall, there is a higher proportion of carpooling/high-occupancy vehicles and new mobility services like ride hailing.
- There's currently on-street parking available fronting and adjacent the subject site, with low parking demand on evening and weekends (industrial and commercial uses adjacent), so some overflow can be accommodated on the street, without disruption to residents.
- The Zoning By-law requires that all off-street parking areas must be:
  - o graded and drained so as to properly dispose of all surface water; as determined by the City; and
  - o surfaced with an asphalt, concrete, or similar pavement so as to provide a surface that is dust-free.
- The applicant has future redevelopment plans for 12333 and 12345 Pattullo Place and as such a gravel surface is deemed to be supportable as an interim condition. The applicant is aware that any future redevelopment of 12333 and 12345 Pattullo Place will require both interim and permanent parking solutions to continue to accommodate the banquet hall at 12350 Pattullo Place. Curb stops are required to installed to ensure adequate parking space delineation in the surface parking lots. Additional securities will be required as a condition of final approval, should Council support the variances, to ensure that the curb stop work is completed.
- The subject banquet hall building is in an employment area and is situated in the centre of the property with surrounding parking and landscaping. The increased height of the building is not anticipated to impact surrounding properties.

#### **PUBLIC ENGAGEMENT**

• Pre-notification letters were sent on June 30, 2022, and the Development Proposal Signs were installed on July 4, 2022. Staff received no responses from neighbouring property owners.

#### **DEVELOPMENT PERMITS**

# Form and Character Development Permit Requirement

- Since the subject application was originally presented to Council, the overall proposed size of the banquet hall facility has increased by 703.3 square metres. The general form & character of the building remains unchanged from that previously presented to Council.
- Parking is intended to be delineated in a manner that allows for adequate onsite maneuverability along drive aisles.
- The existing banquet hall building has its main entrance along the street. The design incorporates elements that create a sense of entry with corrugated metal cladding and vertical black patterns.
- There is one existing fascia sign on the banquet hall building in addition to a tenant panel on an existing free-standing sign on the site. This signage is in keeping with previous signage approvals for the site. No further signage is proposed.

#### TREES

Corey Plester, ISA Certified Arborist of Mike Fadum and Associates Ltd. prepared an Arborist Assessment for the subject property. The table below provides a summary of the tree retention and removal by tree species:

Table 1: Summary of Tree Preservation by Tree Species:				
Tree Species	Ex	isting	Remove	Retain
Alde	r and Co	ttonwood	Ггееѕ	
Cottonwood		1	О	1
(excludin		ous Trees	ood Trees)	
Red Maple		12	3	9
Japanese Maple		3	0	3
Cherry		10	0	10
Honey Locust		4	0	4
	Conifer	ous Trees		
Austrian Pine		7	0	7
Douglas Fir		1	0	1
Western Red Cedar		12	0	12
Lawson False Cypress	1		0	1
<b>Total</b> (excluding Alder and Cottonwood Trees)		50	3	47
Total Replacement Trees Proposed (excluding Boulevard Street Trees)			TBD	
Total Retained and Replacement Trees			TBD	

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Contribution to the Green City Program	TBD

- The initial Arborist Assessment for the site stated that there was a total of 49 mature trees on the site, excluding Alder and Cottonwood trees and it was determined that 48 trees could be retained as part of the development proposal. As the applicant is now proposing an increase in floor area and parking stalls, a revised arborist report has been provided noting a total of 50 mature trees on the site, excluding Alder and Cottonwood trees with 47 trees to be retained as part of the revised development proposal.
- For those trees that cannot be retained, the applicant will be required to plant trees on a 1 to 1 replacement ratio for Alder and Cottonwood trees, and a 2 to 1 replacement ratio for all other trees. This will require a total of 6 replacement trees on the site. No replacement trees have been proposed at this time. Submission of a revised arborist report is to be provided to Planning staff for review and approval prior to, and as condition of Development Permit and Development Variance Permit issuance.
- If no replacement trees are proposed to be provided on the subject site in the new arborist report submission, the deficit of 6 replacement trees will require a cash-in-lieu payment of \$3,300 representing \$550 per tree to the Green City Program, in accordance with the City's Tree Protection By-law.

#### INFORMATION ATTACHED TO THIS REPORT

The following information is attached to this Report:

Appendix I. Site Plan, Building Elevations and Perspective Appendix II. Development Variance Permit No. 7919-0017-00

Appendix III. Tree Management Plans

Appendix IV. Initial Planning Report No. 7919-0017-00, July 11, 2022

approved by Ron Gill

Don Luymes General Manager Planning and Development

EM/ar

#### **Drawing List**

DRAWING TITLE DWG. NO.

Architectural

Sheet Number	Sheet Name
A0.1	CONTEXT PLAN
A0.2	MASTER PARKING PLAN
A0.3	SURVEY PLAN
A0.4	GRADING PLAN
A0.5	LEASE PARKING PLAN
A0.6	ZONING SYNOPSIS AND BUILDING CODE
A1.1	BUILDING SITE PLAN
A1.2	BUILDING FIRST FLOOR PLAN
A1.3	BUILDING MEZZANINE/ SECOND FLOOR PLAN
A1.4	BUILDING ROOF PLAN
A2.1	BUILDING ELEVATIONS
A3.1	BUILDING SECTIONS
A4.1	STORAGE ADDITION PLANS
A4.2	STORAGE ADDITION ELEVATIONS
A4.3	STORAGE ADDITION ELEVATIONS
A4.4	STORAGE ADDITION SECTIONS
A4.5	STORAGE ADDITION SECTIONS
A4.6	STORAGE ADDITION DETAIL PLANS
A4.7	STORAGE ADDITION STAIR PLANS
A4.8	STORAGE ADDITION STAIR #4 SECTIONS
A4.9	STORAGE ADDITION STAIR #5 SECTIONS
A4.10	STORAGE ADDITION ENTRY STAIR DETAILS
A4.11	STORAGE ADDITION WALL SECTION DETAILS
A4.12	STORAGE ADDITION DETAILS
A4.13	STORAGE ADDITION HVAC DETAILS
A5.1	PATIO/ SERVERY PLAN
A5.2	PATIO/ SERVERY DETAILS
A6.1	REFUSE ENCLOSURE
A7.1	CONSTRUCTION ASSEMBLIES
A7.2	DOOR SCHEDULE

DWG. NO.	DRAWING TITLE

#### STRUCTURAL

S-1 GENERAL NOTES
S-2 FOUNDATION PLAN
S-3 FRAMING PLANS
S-4 SECTIONS
S-5 BRACE ELEVATIONS

DRAWING TITLE DWG. NO.

#### ELECTRICAL

SITE PLAN
POMENS TRIBLITION
LIGHTMO FATURE SCHEDULE AND DETAILS
PLUL FLOOR PLAN - GROUND FLOOR
FULL FLOOR PLAN - GROUND FLOOR
FULL FLOOR PLAN - 200 FLOOR
STORAGE ADDITION FLOOR FLOOR
STORAGE ADDITION FLOOR FLAN - ROOF DECK
SPECIFICATION 10 F4
SPECIFICATION 10 F4
SPECIFICATION 10 F4
SPECIFICATION 10 F4

SPECIFICATION 3 OF 4 SPECIFICATION 4 OF 4

DWG, NO. DRAWING TITLE

#### MECHANICAL

SITE PLAN
FOUNDATION & GROUND FLOOR PLAN PLUMBING
SECOND FLOOR AND ROOF PLAN PLUMBING'
GROUND FLOOR PLAN, SECOND & ROOF PLAN HVAC
DETAIL & EQUIPMENT LIST
SPECIFICATIONS

DWG. NO. DRAWING TITLE


#### SPRINKLER

BUILDING ADDITION FIRE PROTECTION NEW STORAGE AREA FIRE PROTECTION

DWG, NO. DRAWING TITLE Survey DWG. NO. DRAWING TITLE CIVIL

GRADING PLAN

0.1

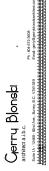





# **ARIA BANQUET HALL & CONVENTION CENTRE**

STORAGE ADDITION

12350 PATULLO PLACE SURREY, BC

Parm Sanghera

TEL: (604) 889 3264 EMAIL: parmcanghera1@gmail.com

Architectural: GERRY BLONSKI ARCHITECT SUITE 1A - 12468 - 82 AVE., SURREY, B.C. V3W 3E9

TEL: (604) 572 3608

Structural: LONDON MAH & ASSOCIATES #103-1847 W BROADWAY VANCOUVER, B.C. V6J 1Y6

TEL: (604) 739 8544 EMAIL: londonmah@telus.net CONTACT: Jim Mah Mechanical: SRC ENGINEERING CONSULTANTS #205-4180 LOUGHEED HWY BURNABY, B.C. VSC 3A7

TEL: (604) 268 9091 EMAIL: bill@src-eng.com CONTACT: Bill Khangura

Electrical: SRC ENGINEERING CONSULTANTS #205-4180 LOUGHEED HWY BURNABY, B.C. V5C 3A7

TEL: (604) 268 9091 EMAIL: --CONTACT: --

Geotechnical: GEOPACIFIC CONSULTANTS

Energy Model: SRC ENGINEERING CONSULTANTS

TEL: (604) 268 9091 EMAIL: bill@ src-eng.com CONTACT: Bill Khangura


Survey: MURRAY & ASSOCIATES #201-12448 82 AVE SURREY, B.C. V3W 3E9

TEL: (604) 597 9189 EMAIL: survey@murrayls.com CONTACT: Ray Janzen


Sprinklers: CLOVER CONTRACTING LTD 6100 163B ST. SURREY, B.C. V3S 3W2

TEL: (778) 885 7432 EMAIL: cam.clovercontracting@gmail.com CONTACT: Cam Nguyen



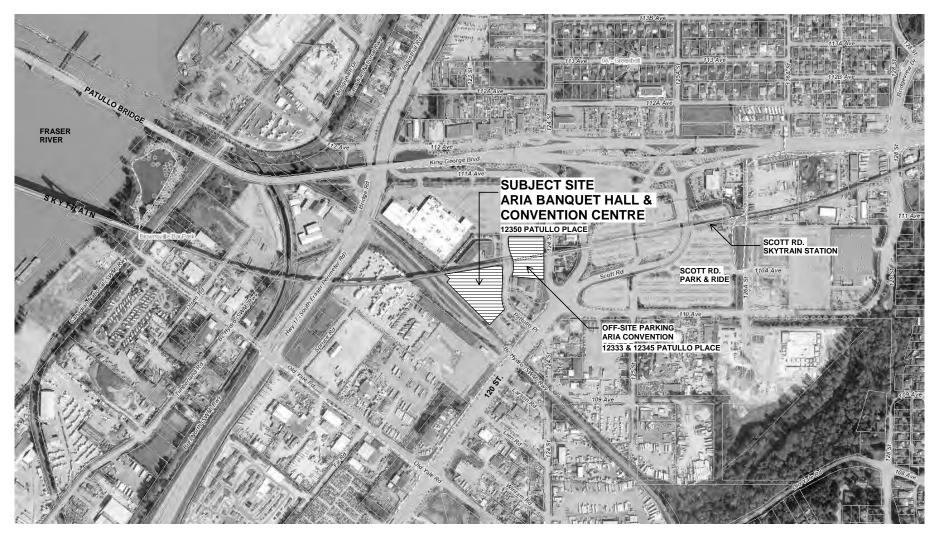

# **CONTEXT PLAN** N.T.S.

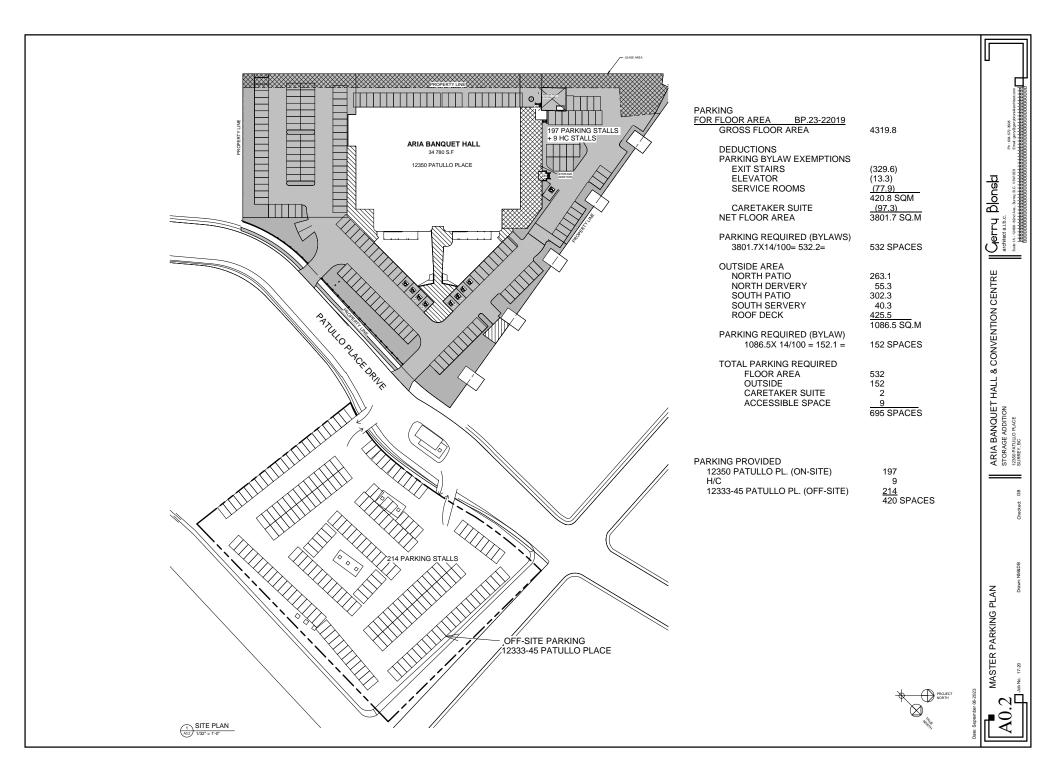

2.00

5.00

REAR MEZZANINE:

PROPOSED TOTAL FLOOR AREA:

NORTH PATIO

ROOF DECK

NORTH: SOUTH:

NET ADDITION

NORTH SERVERY

SOUTH PATIO SOUTH SERVERY

APPROVED BP-14-036402

OUTSIDE AREA BP 23-22019

NET ADDITION:

PATIO SUMMARY

7 00

(279.0 SQM)

617.7 SQM

4319.8 SQM

425.5 1086.5 SQ.M

(333.6) SQM

752.9 SQM

(158.9) (174.7)

263.1 55.3 302.3 40.3 MAJOR OCCUPANCIES
TABLE 3.1.2.1
GROUP A2 ASSEMBLY

2. EXISTING BUILDING PERMIT 14-036402
BUILDING APEA 3774.6 SOM
BUILDING HEIGHT 1-STOREY/ MEZZANINE
BUILDING IS SPRINKLERED
SPRINKLERED SPR NON-COMBUSTIBLE/ CONSTRUCTION COMBUSTIBLE 3.2.2.26

COMPLIANCE ARTICLE

STORAGE ADDITION CHANGES BUILDING CHARACTERISTICS BUILDING AREA 3174.6 (201.8)

ADDITION (2ND FL)488.1 3381 4 SOM

MAXIMUM BUILDING AREA UNLIMITED 6-STORIES SPRINKLERED NON-COMBUSTIBLE MAXIMUM BUILDING HEIGHT BUILDING MUST BE CONSTRICTION MUST BE NON-COMBUST COMBUSTIBLE MEZZANINE MUST BE REMOVED

COMPLIANCE ARTICLE CHANGES TO 3.2.2.24

#### SPATIAL SEPARATION

WEST WALL (FACING BC HYDRO RAILWAY) UNPROTECTED OPENINGS TABLE 3.2.3.D WALL AREA EXISTING 386 ADDITION 75 461 SQM

LIMITING DISTANCE 7.6M OPENINGS PERMITTED 76% 2% OPENINGS PROVIDED

WALL CONSTRUCTION TABLE 3.2.3.7 FIRE RESISTANCE RATING RECHIRED 45 MIN PROVIDED REFERENCE TABLE D2 3 4 A 5/8 GW/R<sub>\*</sub>X 40 TABLE D2.3.4.E STEEL STUDS

10 50 MIN TOTAL 5. NORTH/ EAST WALLS UNPROTECTED OPENINGS TABLE 3.2.3.1.D LIMITING DISTANCE TO PROPERTY LINE EXCEEDS 9M

OPENINGS PERMITTED
WALL CONSTRUCTION TABLE 3.2.3.7 NO FIRE RESISTANCE RATING REQUIRED

# **EXITS** 3.2.4

6 ADDITION-FIRST ADDITION-FIRST
OF THE EXISTING FIRST FLOOR FIRE COMPARTMENT
DOOR #105 IS NEW EXIT AND INCREASES THE TOTAL
FIRSST FLOOR EXIT WIDTH BY 1727MM AND OCCUPANT LOAD BY 283 PERSONS

 ADDITION-SECOND FLOOR (BANQUET ROOM) 1 NUMBER OF EXITS REQUIRED 3.4.2.1(1)

REQUIRED PROVIDED .2 DISTANCE BETWEEN EXITS

3.4.2.3(1)(B) REQUIRED DIAGONAL DIM / 2 =134/2= 67 FT 72 FT PROVIDED

.3 LOCATION OF EXITS 3.4.2.5(1)(C)

MAX TRAVEL DISTANCE

PROVIDED 21M

4 EXIT CAPACITY ATT CAPACITY
3.4.3.2.(1)(A)
ASSUME DOOR #202 IS 1/2 TOTAL CAPACITY
= 34" x 25.4 / 6.1 = 140
TOTAL EXIT CAPACITY IS

280 PERSONS =2x140 =

Blonsbi

Gerry architect a.i.b.c.


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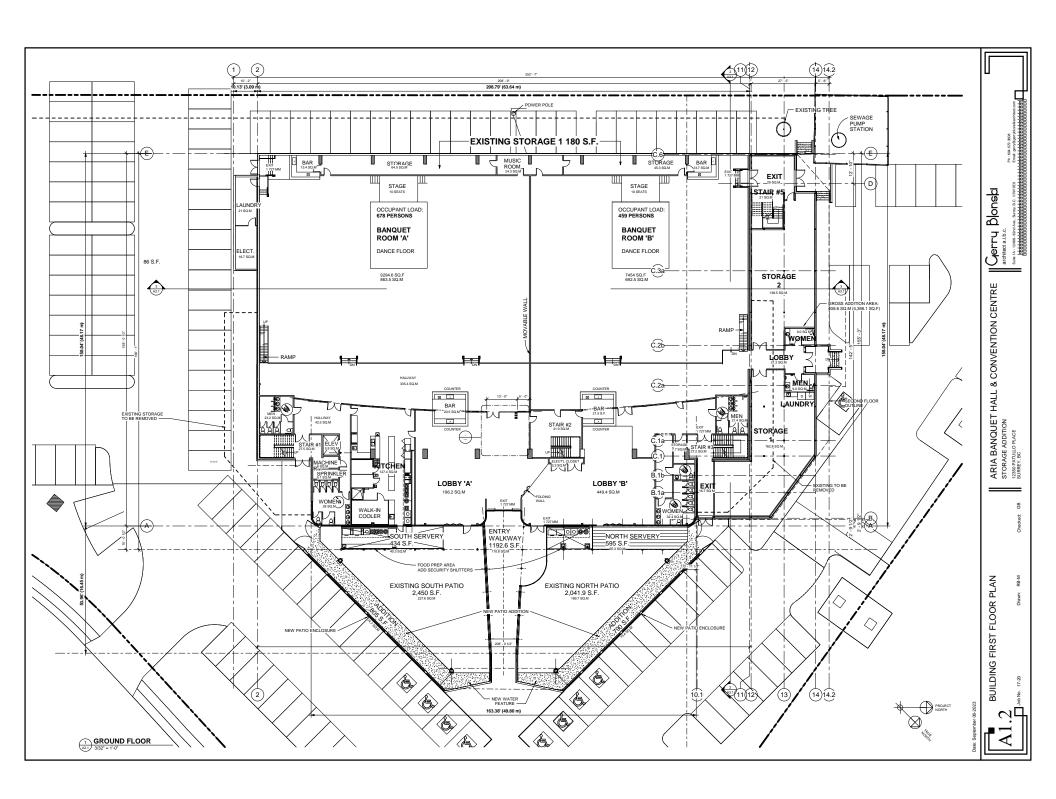
GB


SYNOPSIS





AND BUILDING ZONING



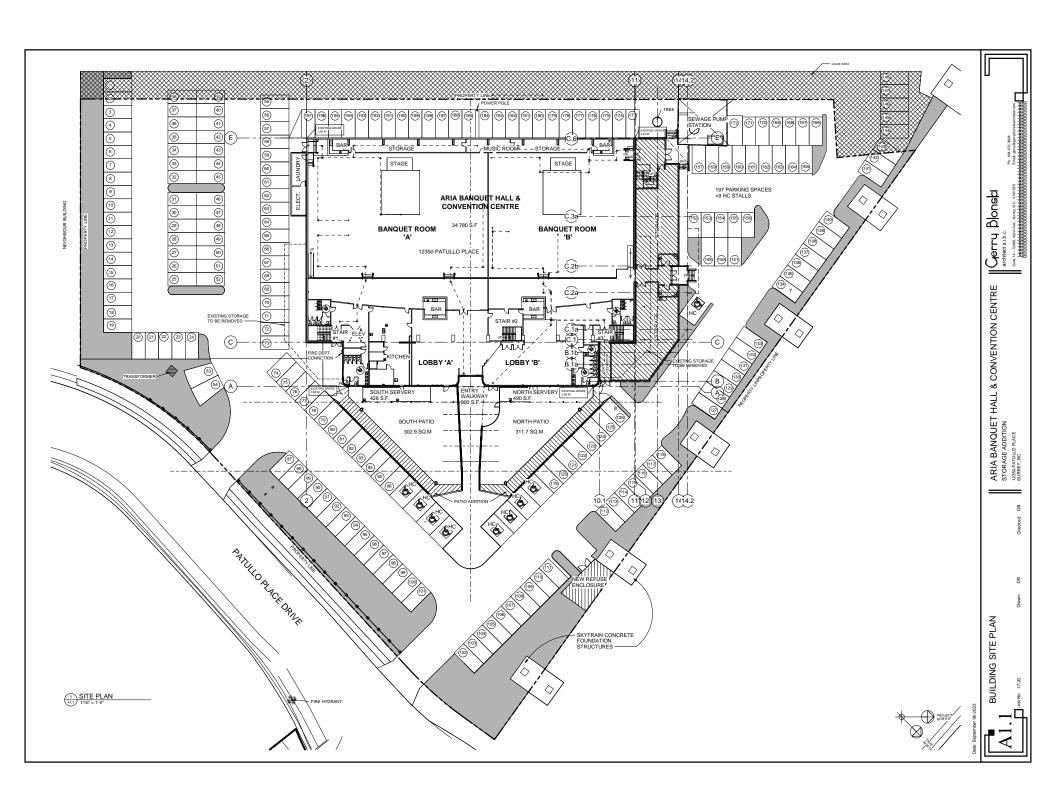

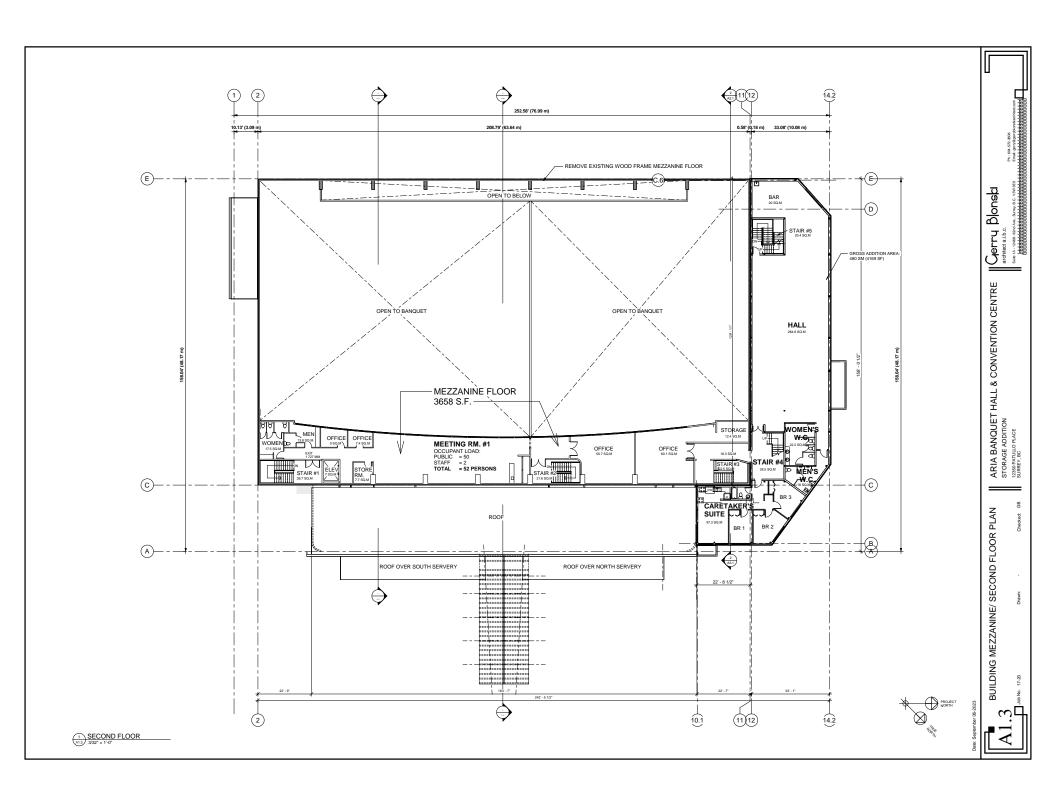


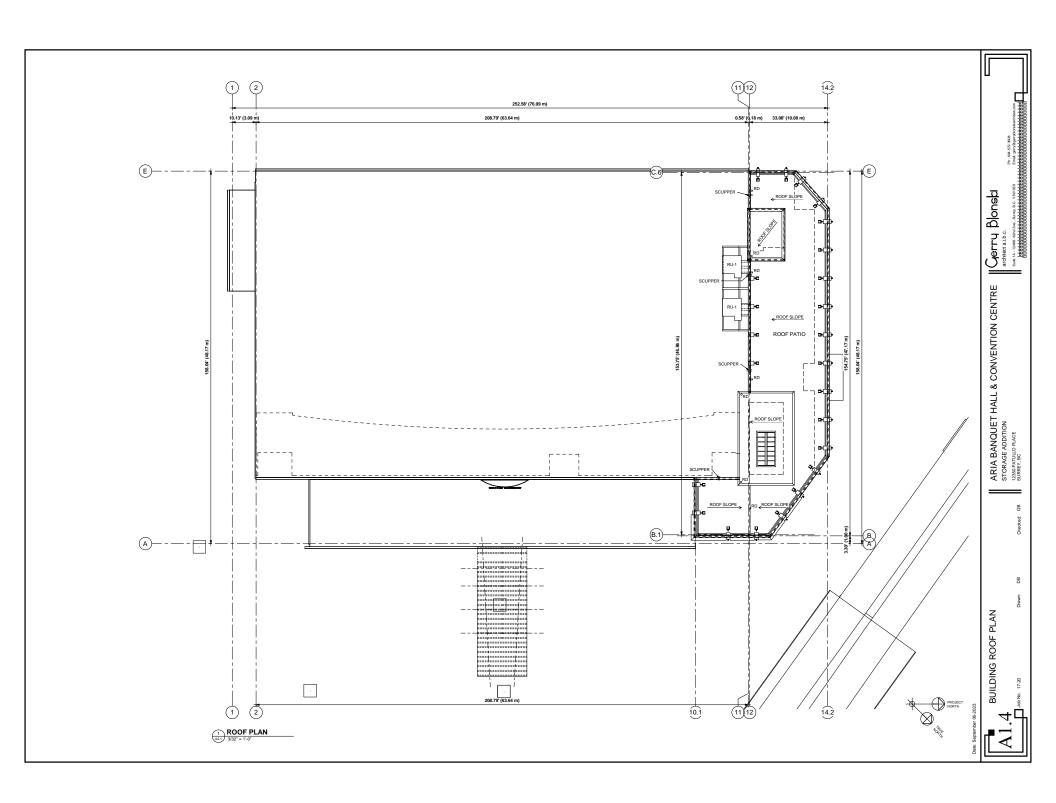

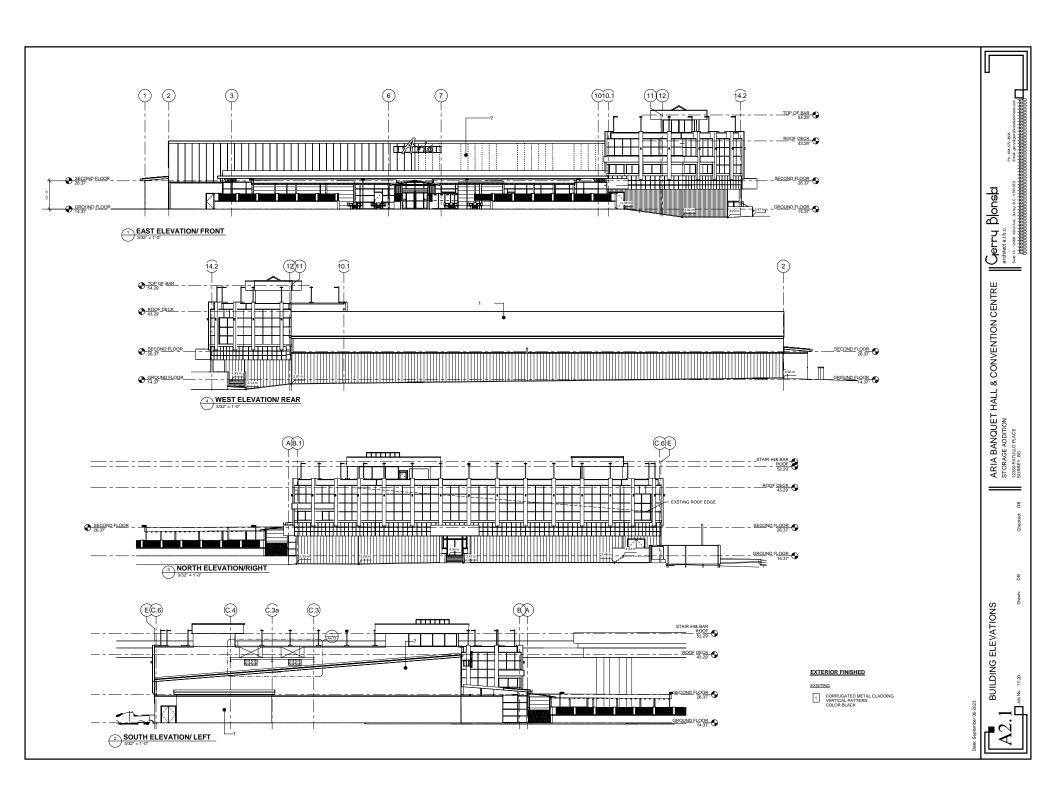


BUILDING SECTIONS

3 CROSS-SECTION 1 A3.1 3/32" = 1'-0"

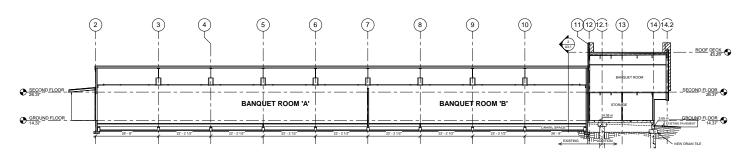



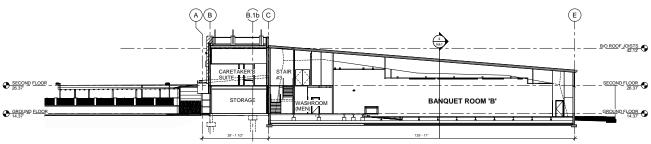

#### **CITY OF SURREY**

(the "City")

## **DEVELOPMENT VARIANCE PERMIT**

NO.: 7919-0017-00

Issued	l To:

("the Owners")

Address of Owner:

- 1. This development variance permit is issued subject to compliance by the Owner with all statutes, by-laws, orders, regulations or agreements, except as specifically varied by this development variance permit.
- 2. This development variance permit applies to that real property including land with or without improvements located within the City of Surrey, with the legal description and civic address as follows:

Parcel Identifier: 023-376-813

Lot 1 Section 17 Block 5 North Range 2 West New Westminster District Plan LMP27431 12333 - Pattullo Place

Parcel Identifier: 023-529-687

Lot 1 Section 17 Block 5 North Range 2 West New Westminster District Plan LMP30003 12350 - Pattullo Place

Parcel Identifier: 023-376-821

Lot 2 Section 17 Block 5 North Range 2 West New Westminster District Plan LMP27431 12345 - Pattullo Place

(the "Land")


- 3. Surrey Zoning By-law, 1993, No. 12000, as amended is varied as follows:
  - (a) In Table D.1 of Part 5 Off-Street Parking and Loading/Unloading, the required offstreet parking spaces for an eating establishment (banquet hall) with a total floor area of 5,407 square metres (including patios and a caretaker suite) is reduced from 695 parking spaces to 420 parking spaces.
  - (b) In Section A.3(a)(b) of Part 5 Off-Street Parking and Loading/Unloading is varied to allow for parking spaces associated with an eating establishment (banquet hall)

located at 12350 Patullo Place to be located on non-abutting or contiguous lots located at 12333 and 12345 Pattullo Place.

- (c) In Section A.4(a)ii. of Part 5 Off-Street Parking and Loading/Unloading is varied to allow parking lots located at 12333 and 12345 Pattullo Place to be surfaced with gravel.
- (d) In Part 39 Highway Commercial Industrial Zone (CHI) Section G Height of Buildings the principal building height is increased from 9 metres to 13.1 metres for the banquet hall building on the site.
- 4. This development variance permit applies to only that portion of the buildings and structures on the Land shown on Schedule A which is attached hereto and forms part of this development variance permit. This development variance permit does not apply to additions to, or replacement of, any of the existing buildings shown on attached Schedule A, which is attached hereto and forms part of this development variance permit.
- 5. The Land shall be developed strictly in accordance with the terms and conditions and provisions of this development variance permit.
- 6. This development variance permit shall lapse if the Owner does not substantially start any construction with respect to which this development variance permit is issued, within two (2) years after the date this development variance permit is issued.
- 7. The terms of this development variance permit or any amendment to it, are binding on all persons who acquire an interest in the Land.
- 8. This development variance permit is not a building permit.

AUTHORIZING	i resolutio	N PASSED	BY THE COUNCIL, THE	DAY OF	, 20 .
ISSUED THIS	DAY OF	, 20 .			

Mayor	– Brenda	a Locke		
City Cl	erk – Jen	nifer Fico	ocelli	

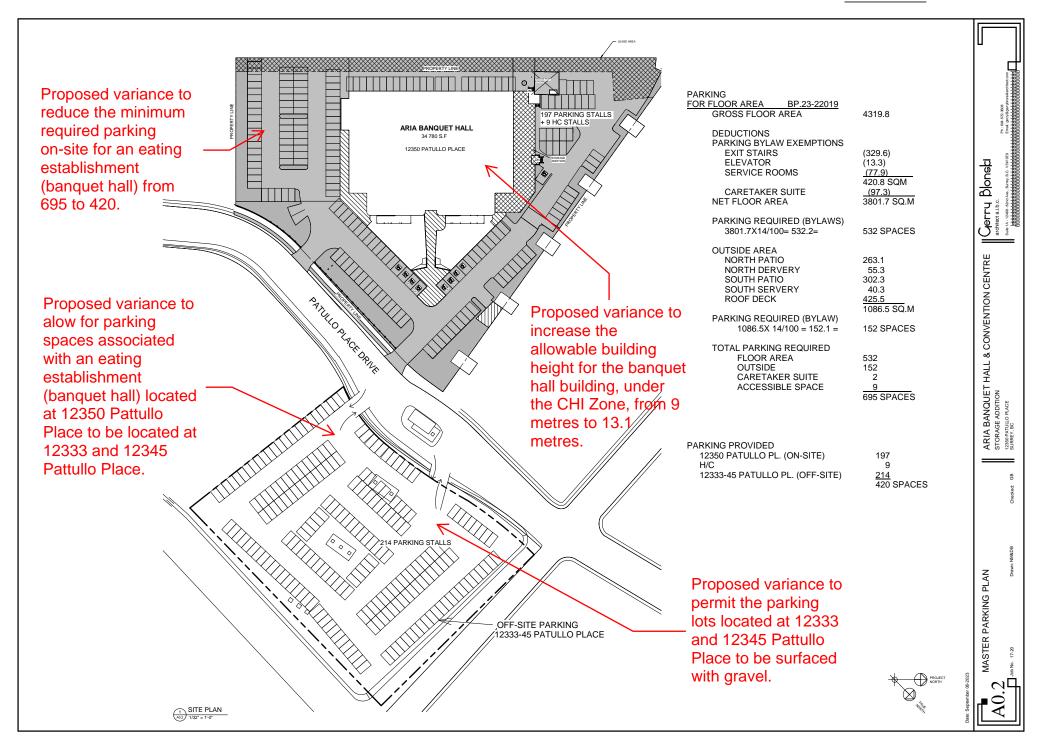

# MIKE FADUM AND ASSOCIATES LTD. VEGETATION CONSULTANTS

# **Tree Preservation Summary**

**Surrey Project No: TBD** 

Address: 12350 Pattullo Place, Surrey, BC Registered Arborist: Corey Plester #PN-8523A


On-Site Trees	Number of Trees
Protected Trees Identified	
(on-site and shared trees, including trees within boulevards and proposed streets	54
and lanes, but excluding trees in proposed open space or riparian areas)	
Protected Trees to be Removed	6
Protected Trees to be Retained	48
(excluding trees within proposed open space or riparian areas)	40
Total Replacement Trees Required:  Red Alder/ Black Cottonwood Trees Requiring 1 to 1 Replacement Ratio  0 X one (1) = 0  All other Trees Requiring 2 to 1 Replacement Ratio  3 X two (2) = 6  Dead Trees (Previously Planted) Requiring 2 to 1 Replacement Ratio  3 X one (1) = 3	9
Replacement Trees Proposed	TBD
Replacement Trees in Deficit	TBD
Protected Trees to be Retained in Proposed [Open Space / Riparian Areas]	NA


Off-Site Trees	Number of Trees
Protected Off-Site Trees to be Removed	0
Total Replacement Trees Required:	
- Alder & Cottonwood Trees Requiring 1 to 1 Replacement Ratio 0 X one (1) = 0	0
- All other Trees Requiring 2 to 1 Replacement Ratio 0 X two (2) = 0	
Replacement Trees Proposed	NA
Replacement Trees in Deficit	NA


Summary report and plan prepared and submitted by: Mike Fadum and Associates Ltd.		
Signature of Arborist:	Date: September 5, 2023	





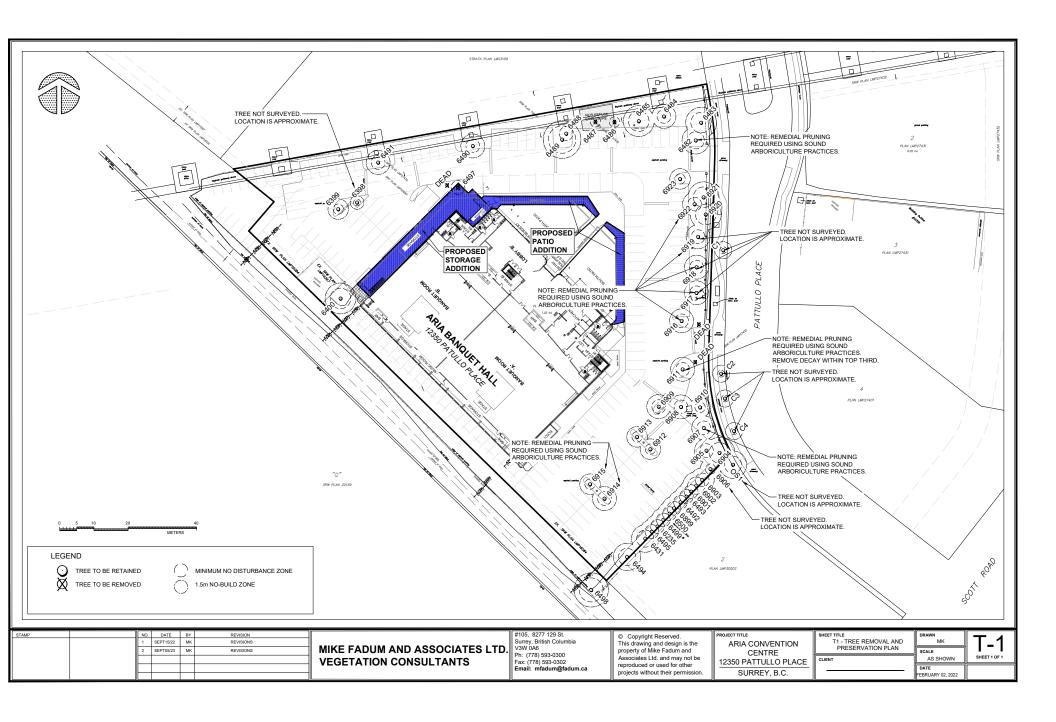

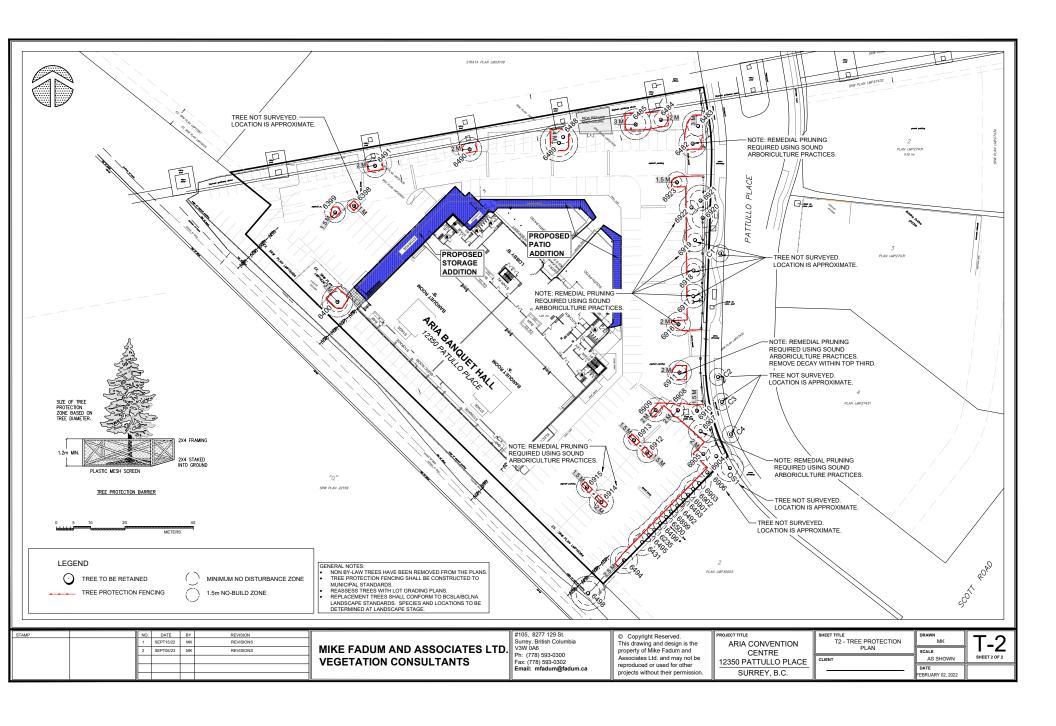

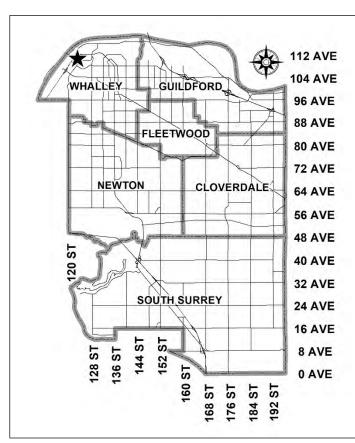

# City of Surrey PLANNING & DEVELOPMENT REPORT Application No.: 7919-0017-00

Planning Report Date: July 11, 2022

#### PROPOSAL:

- Development Permit
- Development Variance Permit


to address parking requirements, including proposed off-site surface parking lots, and to formalize exterior modifications already completed to an existing banquet hall.

LOCATION: 12333 - Pattullo Place

12345 - Pattullo Place 12350 - Pattullo Place

ZONING: CHI

OCP DESIGNATION: Mixed Employment NCP DESIGNATION: Highway Commercial

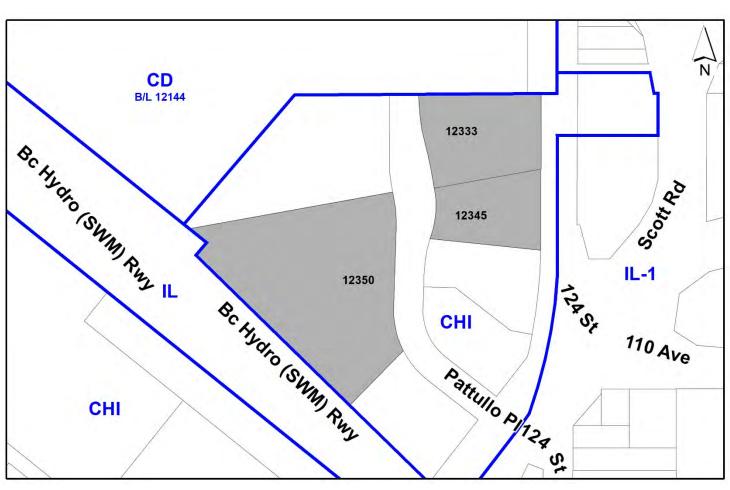

#### **RECOMMENDATION SUMMARY**

- Approval to draft Development Permit for Form and Character.
- Approval for Development Variance Permit to proceed to Public Notification.

# DEVIATION FROM PLANS, POLICIES OR REGULATIONS

- The applicant is seeking the following variances in order to address parking requirements for an existing operational banquet hall:
  - o to reduce the minimum number of off-street parking spaces required for an eating establishment (banquet hall) from 650 to 430;
  - o to allow for parking spaces for the banquet hall use located at 12350 Pattullo Place to be provide on non-abutting or contiguous lots located at 12333 and 12345 Pattullo Place; and
  - o to allow the proposed surface parking lots at 12333 and 12345 Pattullo Place to be surfaced with gravel.

#### RATIONALE OF RECOMMENDATION

- The proposal complies with the Mixed Employment designation in the Official Community Plan (OCP).
- The proposal complies with the Highway Commercial designation in the South Westminster Neighbourhood Concept Plan (NCP).
- The proposed Development Permit will authorize exterior renovations to the existing banquet hall building previously completed without permits
- The proposed formalizing of both 12333 and 12345 Pattullo Place as off-street parking facilities will help to formalize the existing informal parking use of these gravel lots.
  - As a condition of final approval of the proposed Development Permit and Development Variance Permit, the applicant will be required to register formal reciprocal access easements for shared parking over the three (3) subject properties.
  - The applicant retained a Transportation Consultant (Binnie Engineering) to prepare a parking study for the site. The study included three site visits during various events at the banquet hall. The study observed a maximum parking demand of 371 parking spaces and therefore concluded that the proposed 430 parking spaces will be sufficient to accommodate the banquet hall operations.

The parking study also notes that in addition to the 430 parking spaces available on the subject properties, there approximately 20 on-street parking spaces available on the west site of Pattullo Place and a pay parking lot just north of the site at 11125-124 Street that accommodates a further 97 parking spaces. In addition, the applicant has also entered into an agreement with an adjacent property owner to allow vehicles for banquet hall patrons to park in the 26 spaces available at 12355 Pattullo Place after 6:30 pm.

City staff also reviewed the proposed parking supply and support the proposed parking reduction. Staff note the following rationale in support of the variance:

- The proposed patio area will not be a fully enclosed/covered and is located away from the main assembly/seating area, so the space is supplementary and not expected to generate parking demand;
- A portion of the banquet hall (100 sq. m) is reserved for storing a large inventory of furniture and supplies to operate;
- The building contains a caretaker suite with 3 bedrooms, which will be parked at the same rate as ground oriented multi-family developments in the City (2 spaces total);
- The site is in close proximity to Scott Road Skytrain station (approximately 300 m) which results in some guests and staff utilizing transit to attend events; and
  - Given the proximity of the subject property to the Frequent Transit
    Network (FTN), including Scott Road SkyTrain Station, an additional
    10% reduction in the rate used to calculate the required parking for the
    banquet hall use has merit; and
- o Given the nature of the events and guest arrival patterns at this banquet hall, there is a higher proportion of carpooling/high-occupancy vehicles and new mobility services like ride hailing.
- There's currently on-street parking available fronting and adjacent the subject site, with low parking demand on evening and weekends (industrial and commercial uses adjacent), so some overflow can be accommodated on the street, without disruption to residents.

#### RECOMMENDATION

The Planning & Development Department recommends that:

- 1. Council approve Development Variance Permit No. 7919-0017-00 (Appendix III), varying the following to proceed to Public Notification:
  - (a) to reduce the minimum number of off-street parking spaces required for an eating establishment (banquet hall) from 650 to 430;
  - (b) to allow for parking spaces for the banquet hall use located at 12350 Pattullo Place to be provide on non-abutting or contiguous lots located at 12333 and 12345 Pattullo Place; and
  - (c) to allow the proposed surface parking lots at 12333 and 12345 Pattullo Place to be surfaced with gravel.
- 2. Council instruct staff to resolve the following issues prior to final approval:
  - (a) ensure that all engineering requirements and issues including restrictive covenants, dedications, and rights-of-way where necessary, are addressed to the satisfaction of the General Manager, Engineering;
  - (b) final approval from TransLink;
  - (c) resolution of all urban design issues to the satisfaction of the Planning and Development Department;
  - (d) submission of a finalized landscaping plan, landscaping cost estimate and arborist report to the specifications and satisfaction of the Planning and Development Department;
  - (e) submission of a finalized tree survey and a statement regarding tree preservation to the satisfaction of the City Landscape Architect;
  - (f) the applicant satisfy the deficiency in tree replacement on the site, to the satisfaction of the Planning and Development Department;
  - (g) registration of shared access easements and parking agreements to ensure the banquet hall has ongoing access to parking at 12333 and 12345 Pattullo Place;
  - (h) the applicant complete conversion of 4 parking spaces on the banquet hall site to accessible parking spaces (to increase from 5 to 9 accessible parking spaces);
  - (i) the applicant is to submit a revised sign permit to authorize existing signage already installed on the building and site; and
  - (j) submission of securities to ensure that curb stops are installed within the gravel parking lots for proper parking stall delineation to the satisfaction of the Planning & Development Department.

#### **SITE CONTEXT & BACKGROUND**

Direction	Existing Use	NCP Designation	<b>Existing Zone</b>
Subject Sites	Aria Convention Centre and vacant	Highway Commercial, Parks	СНІ
	gravel lots	and Open Spaces	
North:	Highway	Highway	CHI and CD
	commercial uses and parking for	Commercial	Bylaw 12144
	large multi-		
	purpose building		
East (Across 124 Street):	Autobody repair,	Highway	IL-1, CHI
	used car	Commercial	
	dealership		
Southeast:	Highway	Highway	CHI
	commercial uses	Commercial	
Southwest (across BC Hydro	Proposed two-	Business/Residential	IL-1
(SWM) Railway):	storey industrial	Park	
	warehouse		
	building with		
	upper floor office		
	space. Supported		
	by Council on		
	January 25, 2021.		

# Context & Background

- The three subject sites, 12333, 12345 and 12350 Pattullo Place, are either adjacent or directly encumbered by a TransLink Skytrain guideway. The sites are designated Mixed Employment in the Official Community Plan (OCP) and Highway Commercial in the South Westminster Neighbourhood Concept Plan (NCP). The sites are currently zoned Highway Commercial Industrial Zone (CHI).
- The existing banquet hall facility located on 12350 Pattullo Place and now formally known as the Aria Convention Centre was originally constructed as part of Application No. 7996-010-00, at which time the building was intended for a bowling centre and entertainment complex. The building has subsequently been converted to a banquet hall facility.
- Building permits were issued in 2014 permitting building additions resulting in a total floor
  area of 3702.1 square metres. Further additions have been added to the buildings without
  proper permits or approvals, however the applicant is working with Building Division staff to
  obtain the appropriate building permits for the unauthorized work. The subject Development
  Permit is intended to formalize all existing and proposed changes to the form and character of
  the building.
- Offsite parcels located at 12333 and 12345 Pattullo Place, are also owned by the same owner of 12350 Pattullo Place. These empty gravel lots are proposed to accommodate parking for the banquet hall. It is anticipated that these parcels will be redeveloped in the future.

#### **DEVELOPMENT PROPOSAL**

# **Planning Considerations**

- A Form and Character Development Permit is proposed to formalize previously constructed additional and external renovations to the building.
- The building has a combined total floor area of 4,703 square metres (including building interior and patio space). The building complies with the floor area ratio, lot coverage, building height, and setbacks of the CHI Zone.
- Based on the banquet hall facility's various components, which include the assembly area, storage space, patio space and a caretaker suite, the total required parking is 630 parking spaces under the Zoning By-law. There are a total of 218 parking spaces on the banquet hall site. The applicant is proposing to modify the existing gravel lots at 12333 and 12345 Pattullo Place with appropriate curb stops to delineate an additional 212 parking spaces (resulting in a total of 430 parking spaces).
- Development details are provided in the following table:

	Proposed
Lot Area	
Gross Site Area:	1.22 hectares
Road Dedication:	N/A
Undevelopable Area:	N/A
Net Site Area:	1.22 hectares
Number of Lots:	1
Building Height:	8.3 metres
Unit Density:	N/A
Floor Area Ratio (FAR):	0.39

#### Referrals

Engineering: The Engineering Department has no objection to the project.

Ministry of Transportation & Infrastructure (MOTI):

Ministry of Transportation & Infrastructure has no objections.

Surrey Fire Department: The Surrey Fire Department has no objections.

TransLink: TransLink has no objections, subject to a construction

management plan for works adjacent the SkyTrain guideway.

## **Transportation Considerations**

- The banquet hall facility requires 650 parking spaces (648 for banquet hall based on the required parking rate of 14 spaces/100 sq.m of floor area plus 2 parking spaces for caretaker suite) and the applicant is providing 430 parking spaces, combined between the banquet hall site and on the two properties located on the east side of Pattullo Place. As a result of this shortfall in total parking spaces, a variance is required (see Variances section).
- The rear of the site contains parking spaces as part of a lease agreement with BC Hydro, where parking is provided over top of an existing BC Hydro Right of Way (ROW) on the property. These spaces are included as part of the total parking count.
- There are two (2) driveway accesses for the banquet hall site (12350 Pattullo Place) and an additional two (2) driveway accesses for the offsite gravel parcels 12333 and 12345 Pattullo Place.
- Registration of a formal parking easement/shared parking agreement will be required in order to ensure ongoing access to the 212 offsite parking on 12333 and 12345 Pattullo Place for use by the banquet hall.

### Parkland and/or Natural Area Considerations

- A Class C watercourse (ditch) is located within the BC Hydro Railway immediately south of the Aria Convention site at 12350 Pattullo Place.
- The applicant is not proposing any additional additions to the rear of the Aria Convention Centre building, which would impact the watercourse.
- A qualified Environmental Professional has assessed the watercourse and provided confirmation that the Class C designation is correct.
- Due to minimal risk of encroachment and development impact, further assessments are not required, nor is there a requirement for a Sensitive Ecosystem Development Permit.

#### **Sustainability Considerations**

• The applicant has met all of the typical sustainable development criteria, as indicated in the Sustainable Development Checklist.

#### **POLICY & BYLAW CONSIDERATIONS**

#### **Regional Growth Strategy**

- The subject site is designated "General Urban" under the Metro Vancouver Regional Growth Strategy (RGS).
- The existing use complies with the RGS designation.

# Official Community Plan

# **Land Use Designation**

- The subject site is designated "Mixed Employment" in the Official Community Plan (OCP).
- The existing use complies with the OCP designation.

# **Secondary Plans**

## Land Use Designation

• The existing use complies with the "Highway Commercial" Designation in the South Westminster Neighborhood Concept Plan (NCP).

# **Zoning By-law**

• The building (with previously constructed additions) has a combined total floor area of 4,703 square metres (including building interior and patio space). The building complies with the floor area ratio, lot coverage, building height, and setbacks of the CHI Zone.

# **Parking Variances**

- The applicant is requesting the following variances:
  - o to reduce the minimum number of off-street parking spaces required for an eating establishment (banquet hall) from 650 to 430;
  - o to allow for parking spaces for the banquet hall use located at 12350 Pattullo Place to be provide on non-abutting or contiguous lots located at 12333 and 12345 Pattullo Place; and
  - o to allow the proposed surface parking lots at 12333 and 12345 Pattullo Place to be surfaced with gravel.
- The applicant retained a Transportation Consultant (Binnie Engineering) to prepare a parking study for the site. The study included three site visits during various events at the banquet hall. The study observed a maximum parking demand of 371 parking spaces and therefore concluded that the proposed 430 parking spaces will be sufficient to accommodate the banquet hall operations.
- The parking study also notes that in addition to the 430 parking spaces available on the subject properties, there approximately 20 on-street parking spaces available on the west site of Pattullo Place and a pay parking lot just north of the site at 11125- 124 Street that accommodates a further 97 parking spaces. In addition, the applicant has also entered into an agreement with an adjacent property owner to allow vehicles for banquet hall patrons to park in the 26 spaces available at 12355 Pattullo Place after 6:30 pm.

- City staff also reviewed the proposed parking supply and support the proposed parking reduction. Staff note the following rationale in support of the variance:
  - o The proposed patio area will not be a fully enclosed/covered and is located away from the main assembly/seating area, so the space is supplementary and not expected to generate parking demand;
  - o A portion of the banquet hall (100 sq. m) is reserved for storing a large inventory of furniture and supplies to operate;
  - The building contains a caretaker suite with 3 bedrooms, which will be parked at the same rate as ground oriented multi-family developments in the City (2 spaces total);
  - The site is in close proximity to Scott Road Skytrain station (approximately 300 m) which results in some guests and staff utilizing transit to attend events; and
    - Given the proximity of the subject property to the Frequent Transit Network (FTN), including Scott Road SkyTrain Station, an additional 10% reduction in the rate used to calculate the required parking for the banquet hall use has merit; and
  - Given the nature of the events and guest arrival patterns at this banquet hall, there is a higher proportion of carpooling/high-occupancy vehicles and new mobility services like ride hailing.
  - There's currently on-street parking available fronting and adjacent the subject site, with low parking demand on evening and weekends (industrial and commercial uses adjacent), so some overflow can be accommodated on the street, without disruption to residents.
- The Zoning By-law requires that all off-street parking areas must be:
  - o graded and drained so as to properly dispose of all surface water; as determined by the City; and
  - o surfaced with an asphalt, concrete, or similar pavement so as to provide a surface that is dust-free.
- The applicant has future redevelopment plans for 12333 and 12345 Pattullo Place and as such a gravel surface is deemed to be supportable as an interim condition. The applicant is aware that any future redevelopment of 12333 and 12345 Pattullo Place will require both interim and permanent parking solutions to continue to accommodate the banquet hall at 12350 Pattullo Place. Curb stops are required to installed to ensure adequate parking space delineation in the surface parking lots. Additional securities will be required as a condition of final approval, should Council support the variances, to ensure that the curb stop work is completed.
- Staff noted that while the reduction in total parking spaces can be supported, the number of accessible on-site parking spaces is required to be increased from 5 spaces to 9 spaces. This will be a condition of final approval, should Council support the requested variances.

#### **PUBLIC ENGAGEMENT**

• Pre-notification letters were sent on June 30, 2022, and the Development Proposal Signs were installed on July 4, 2022. Staff received have not received responses from neighbouring property owners.

#### **DEVELOPMENT PERMITS**

# Hazard Lands (Flood Prone) Development Permit Requirement

- The subject property falls within the Hazard Lands (Flood Prone Area) Development Permit Area (DPA) in the OCP, given that the site is within the 200-year floodplain of the Fraser River. The Hazard Land (Flood Prone) Development Permit is required to protect developments from hazardous conditions.
- Further assessments are not required as the proposed scope of work is to capture completed additions and renovations to an already existing building.

## Form and Character Development Permit Requirement

- The proposed development is subject to a Development Permit for Form and Character and is also subject to the urban design guidelines in the South Westminster Neighbourhood Concept Plan (NCP).
- The existing building generally complies with the Form and Character Development Permit guidelines in the OCP and the design guidelines in the South Westminster Neighbourhood Concept Plan (NCP).
- Parking is intended to be delineated in a manner that allows for adequate onsite maneuverability along drive aisles.
- The existing banquet hall building has its main entrance along the street. The design incorporates elements that create a sense of entry with corrugated metal cladding and vertical black patterns.
- One existing fascia sign was installed, above the roofline, on the front east elevation without permits. A previous DVP was captured to allow for a fascia sign to extend above the roofline. A sign permit application will be required, prior to issuance of the subject Form and Character Development Permit and Development Variance Permit.

#### **TREES**

 Corey Plester, ISA Certified Arborist of Mike Fadum and Associates Ltd. prepared an Arborist Assessment for the subject property. The table below provides a summary of the tree retention and removal by tree species:

Table 1: Summary of Tree Preservation by Tree Species:

Tree Species	Ex	isting	Remove	Retain
Alder and Cottonwood Trees				
Cottonwood	1		0	1
Deciduous Trees (excluding Alder and Cottonwood Trees)				
Red Maple	12		1	11
Japanese Maple	3		0	3
Cherry	9		0	9
Honey Locust	4		0	4
Coniferous Trees				
Austrian Pine	7		0	7
Douglas Fir	1		0	1
Western Red Cedar	12		0	12
Lawson False Cypress	1		0	1
<b>Total</b> (excluding Alder and Cottonwood Trees)	49		4	48
Total Replacement Trees Proposed (excluding Boulevard Street Trees)		TBD		
Total Retained and Replacement Trees		TBD		
Contribution to the Green City Program		\$800		

- The Arborist Assessment states that there is a total of 49 mature trees on the site, excluding Alder and Cottonwood trees. It was determined that 48 trees can be retained as part of this development proposal. The proposed tree retention was assessed taking into consideration the location of services, building footprints, road dedication and proposed lot grading.
- For those trees that cannot be retained, the applicant will be required to plant trees on a 1 to 1 replacement ratio for Alder and Cottonwood trees, and a 2 to 1 replacement ratio for all other trees. This will require a total of 2 replacement trees on the site. No replacement trees have been proposed at this time. Submission of a revised arborist report and landscape plan is to be provided to Planning staff for review and approval prior to, and as condition of Development Permit and Development Variance Permit issuance.
- If no replacement trees are proposed to be accommodated on the subject site in a new arborist report submission, the deficit of 2 replacement trees will require a cash-in-lieu payment of \$800 representing \$400 per tree to the Green City Program, in accordance with the City's Tree Protection By-law.

# INFORMATION ATTACHED TO THIS REPORT

The following information is attached to this Report:

Appendix I. Site Plan, Building Elevations, Landscape Plans and Perspective

Appendix II. Summary of Tree Survey and Tree Preservation Appendix III. Development Variance Permit No. 7919-0017-00

Appendix IV. Parking Study

approved by Ron Gill

Jeff Arason Acting General Manager Planning & Development

ELM/cm



**ARIA BANQUET HALL** 

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DP SUBMISSION

STORAGE ADDITION ARIA CONVENTION CENTER

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PERSPECTIVE VIEWS

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P SUBMISSION


STORAGE ADDITION ARIA CONVENTION CENTER


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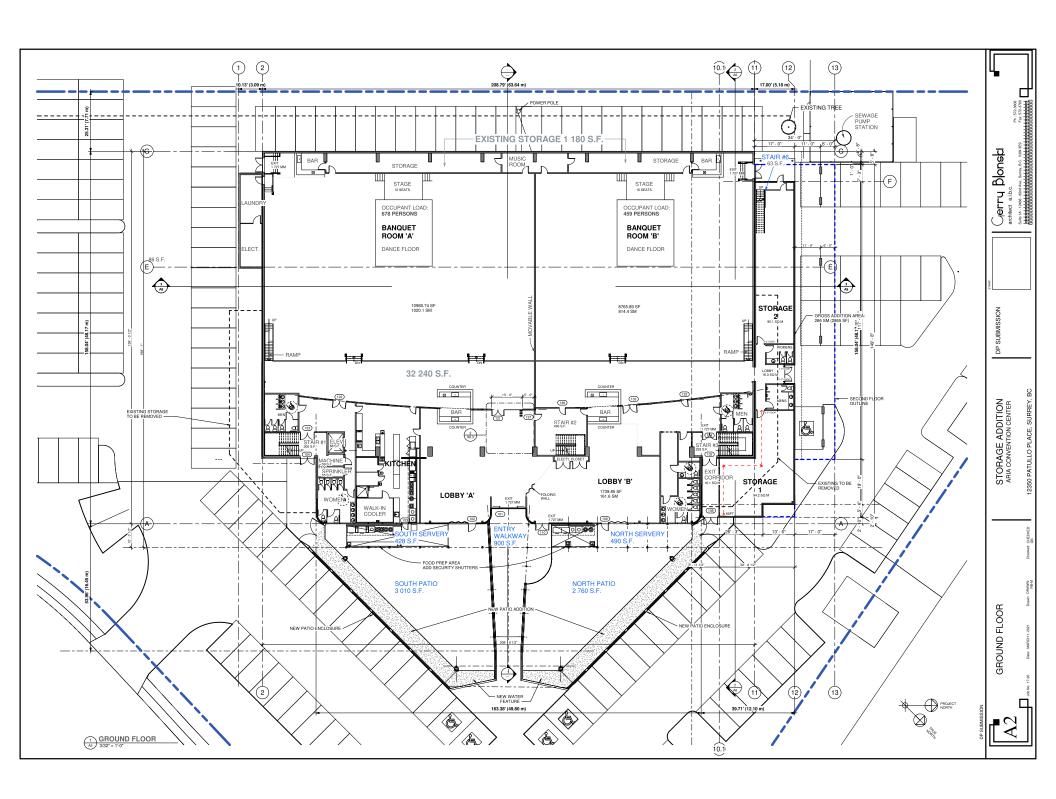
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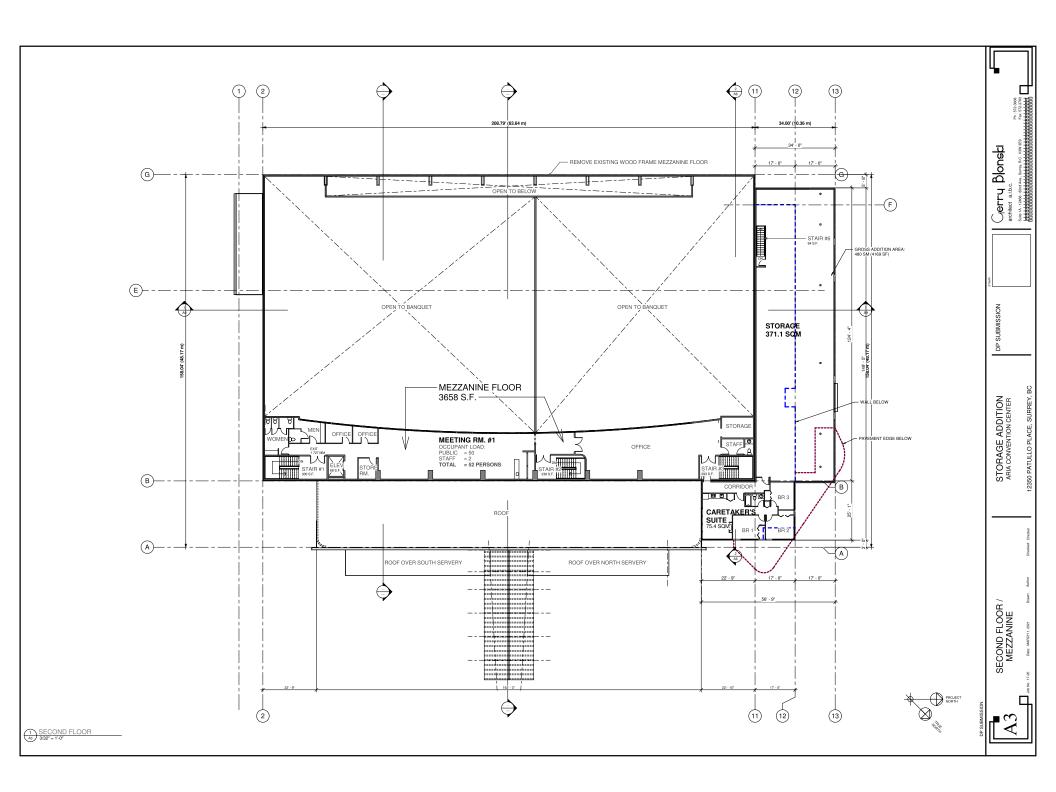
CONTEXT PLAN


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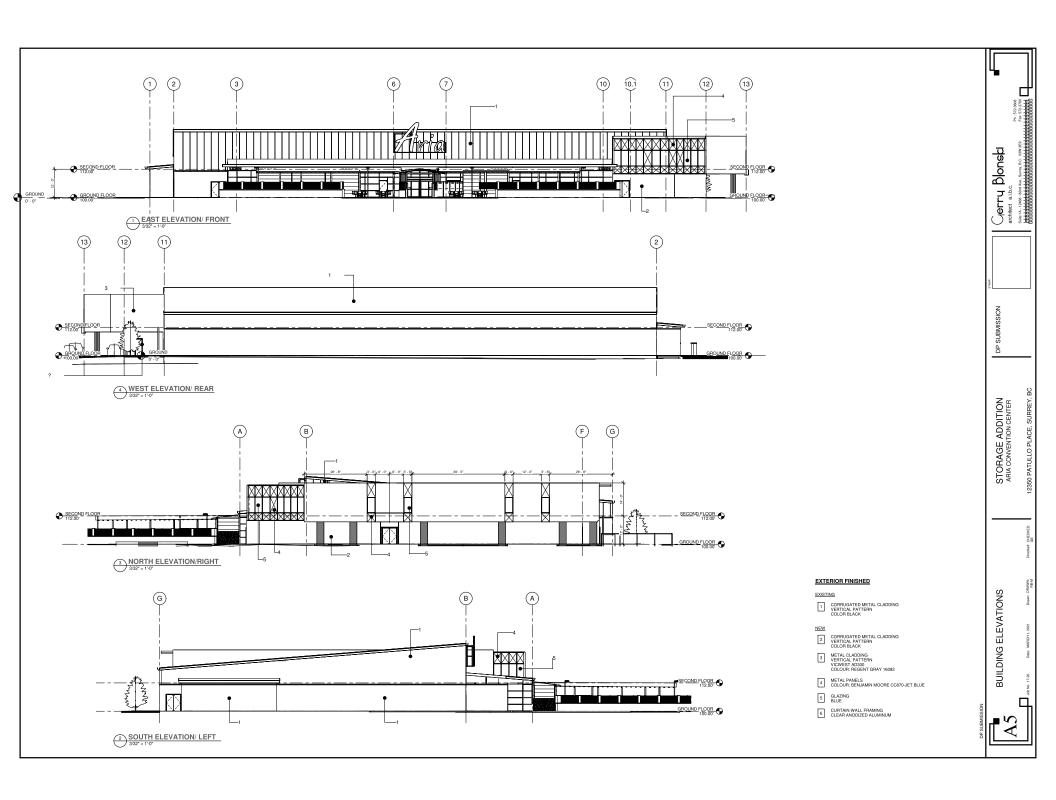







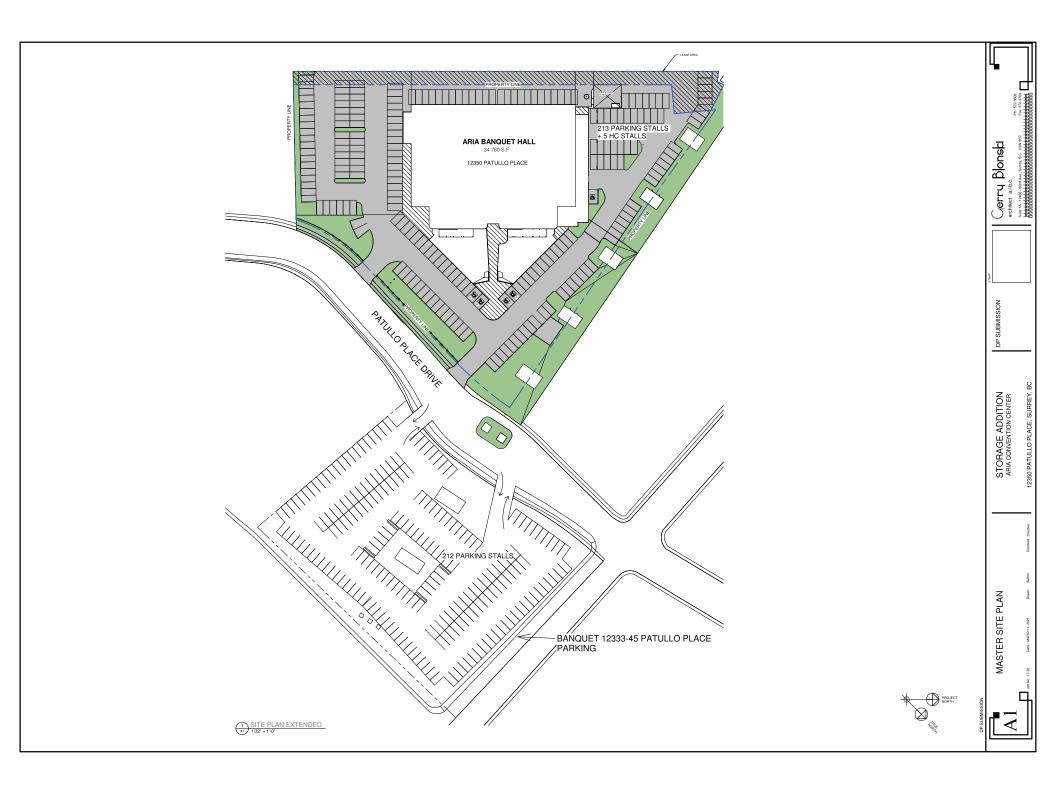

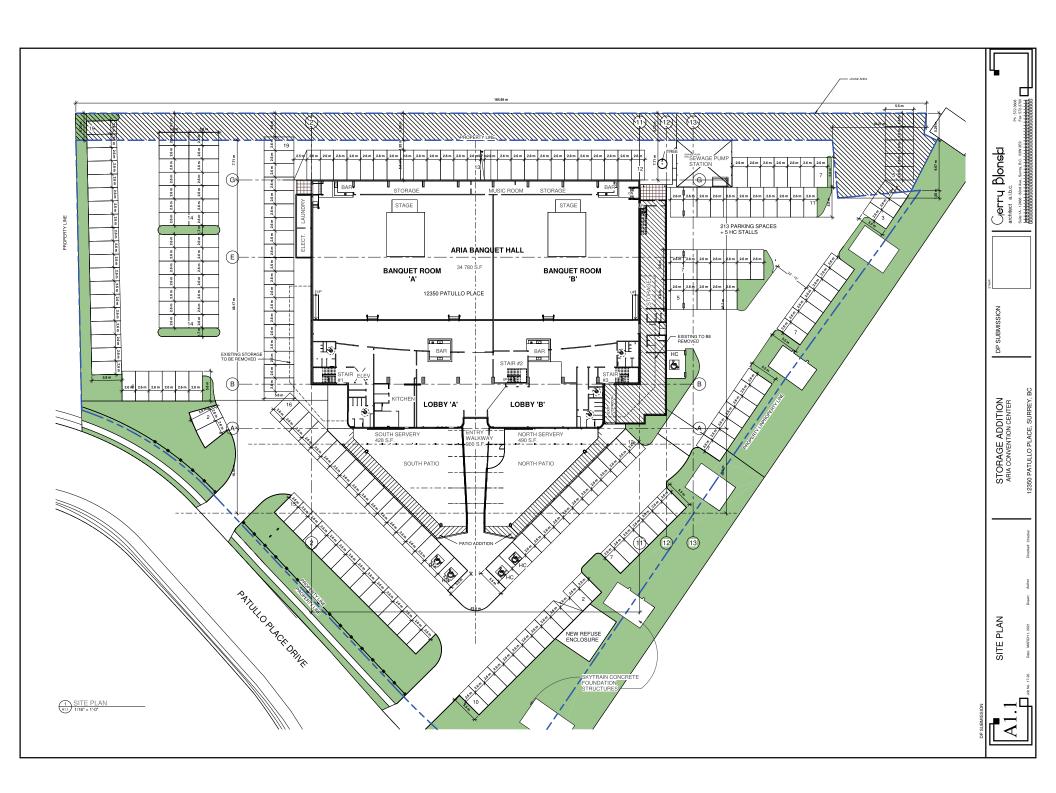

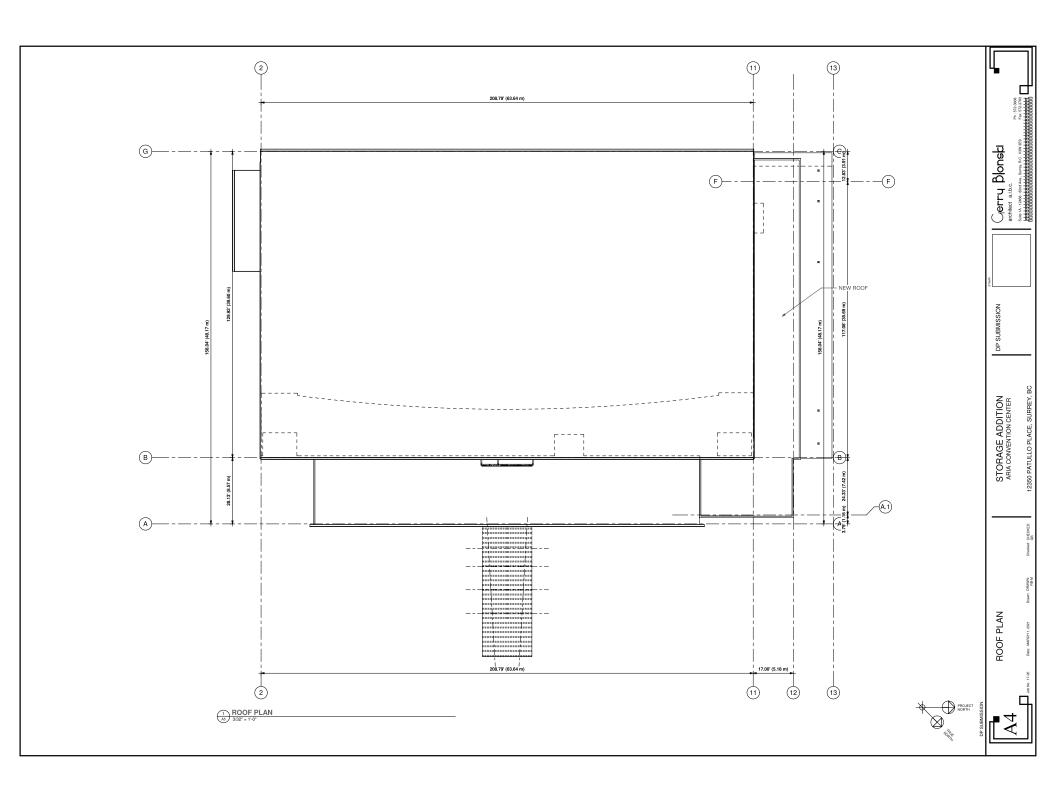

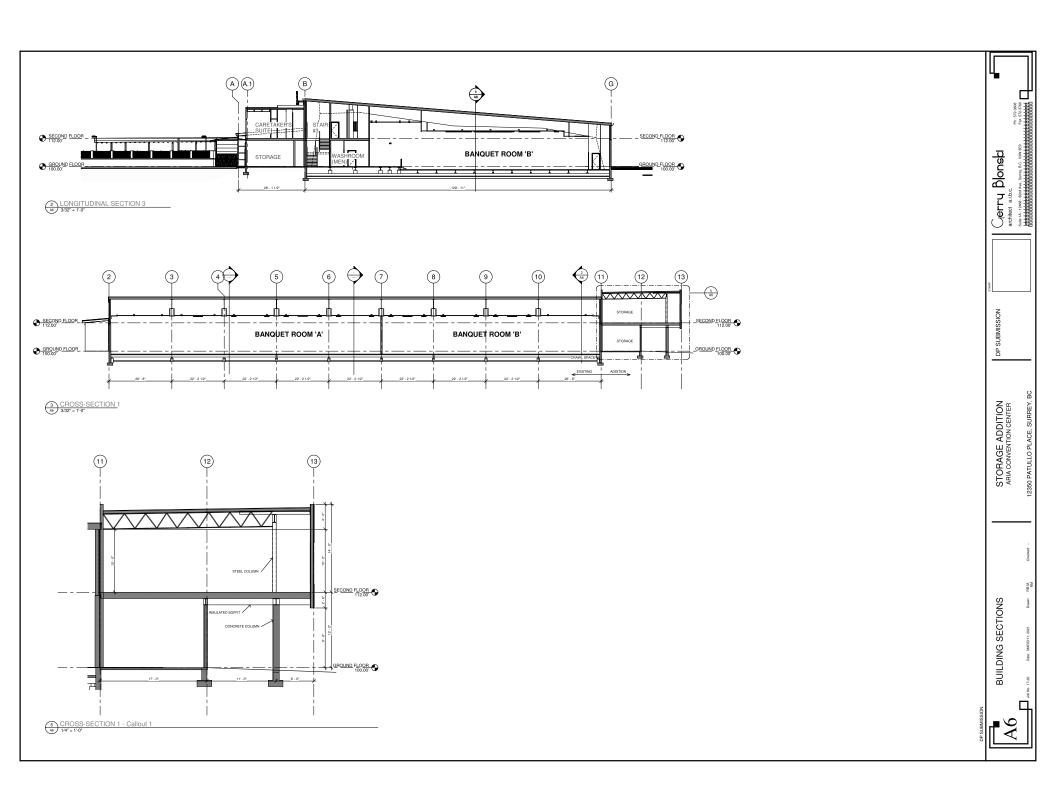

# MIKE FADUM AND ASSOCIATES LTD. VEGETATION CONSULTANTS

# **Tree Preservation Summary**

**Surrey Project No: TBD** 

Address: 12350 Pattullo Place, Surrey, BC Registered Arborist: Corey Plester #PN-8523A


On-Site Trees	Number of Trees
Protected Trees Identified	
(on-site and shared trees, including trees within boulevards and proposed streets	50
and lanes, but excluding trees in proposed open space or riparian areas)	
Protected Trees to be Removed	1
Protected Trees to be Retained	49
(excluding trees within proposed open space or riparian areas)	49
Total Replacement Trees Required:	
Relocated Trees Requiring 1 to 1 Replacement Ratio  0 X one (1) = 0  - All other Trees Requiring 2 to 1 Replacement Ratio  1 X two (2) = 2	2
Replacement Trees Proposed	TBD
Replacement Trees in Deficit	TBD
Protected Trees to be Retained in Proposed [Open Space / Riparian Areas]	NA

Off-Site Trees	Number of Trees
Protected Off-Site Trees to be Removed	0
Total Replacement Trees Required:  - Alder & Cottonwood Trees Requiring 1 to 1 Replacement Ratio	
0 X one (1) = 0  - All other Trees Requiring 2 to 1 Replacement Ratio	0
0 X two (2) = 0	
Replacement Trees Proposed	NA
Replacement Trees in Deficit	NA

Summary report and plan prepared and submitted by:	Mike Fadum and Associates Ltd.
Signature of Arborist:	Date: February 2, 2022





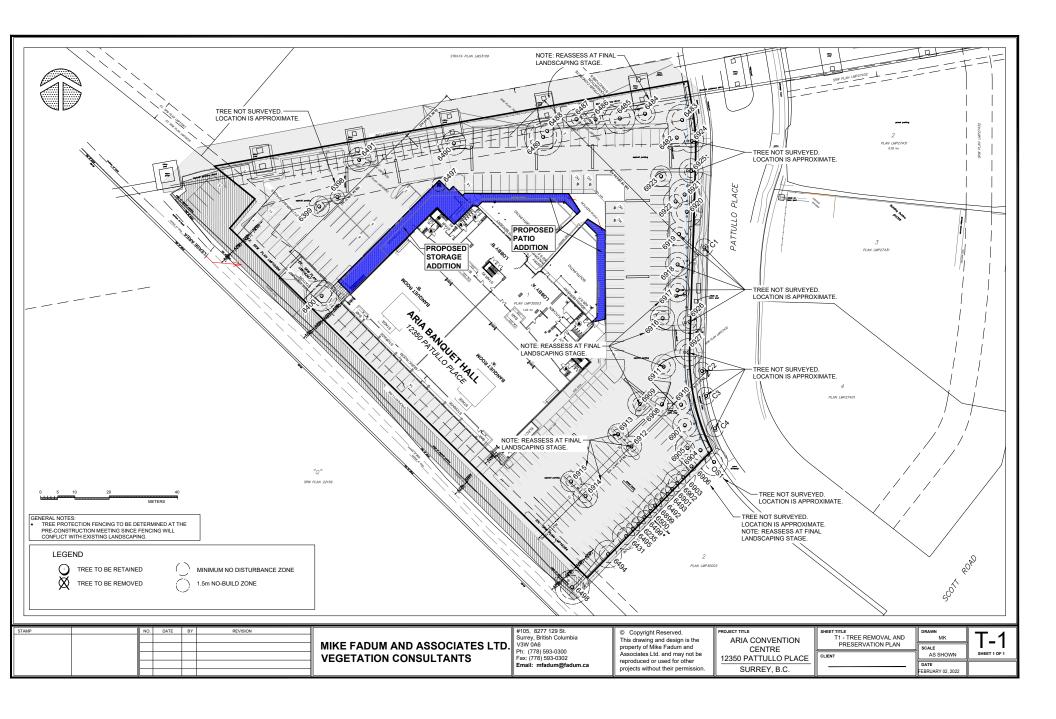

#### **CITY OF SURREY**

(the "City")

#### **DEVELOPMENT VARIANCE PERMIT**

NO.: 7919-0017-00

Issued To:

("the Owners")

Address of Owner:

- 1. This development variance permit is issued subject to compliance by the Owner with all statutes, by-laws, orders, regulations or agreements, except as specifically varied by this development variance permit.
- 2. This development variance permit applies to that real property including land with or without improvements located within the City of Surrey, with the legal description and civic address as follows:

Parcel Identifier: 023-376-813 Lot 1 Section 17 Block 5 North Range 2 West New Westminster District Plan LMP27431 12333 - Pattullo Place

Parcel Identifier: 023-529-687 Lot 1 Section 17 Block 5 North Range 2 West New Westminster District Plan LMP30003 12350 - Pattullo Place


Parcel Identifier: 023-376-821 Lot 2 Section 17 Block 5 North Range 2 West New Westminster District Plan LMP27431 12345 - Pattullo Place

(the "Land")

- 3. Surrey Zoning By-law, 1993, No. 12000, as amended is varied as follows:
  - (a) In Table D.1 of Part 5 Off-Street Parking and Loading/Unloading, the required off-street parking spaces for an eating establishment (banquet hall) with a total floor area of 4,703 square metres (including a 75 square metre caretaker suite) is reduced from 650 parking spaces to 430 parking spaces.
  - (b) Section A.3(a)(b) of Part 5 Off-Street Parking and Loading/Unloading is varied to allow for parking spaces associated with an eating establishment (banquet hall) located at 12350 Patullo Place to be located on non-abutting or contiguous lots located at 12333 and 12345 Pattullo Place.

	(c)	Section A.4(a)ii. of Part 5 Off-Street Parking and Loading/Unloading is varied to allow parking lots located at 12333 and 12345 Pattullo Place to be surfaced with gravel.	
4.	struct this de addition	evelopment variance permit applies to only that portion of the buildings and ures on the Land shown on Schedule A which is attached hereto and forms part of evelopment variance permit. This development variance permit does not apply to ons to, or replacement of, any of the existing buildings shown on attached Schedule ich is attached hereto and forms part of this development variance permit.	
5.		and shall be developed strictly in accordance with the terms and conditions and ions of this development variance permit.	
6.	This development variance permit shall lapse if the Owner does not substantially start any construction with respect to which this development variance permit is issued, within two (2) years after the date this development variance permit is issued.		
7.		erms of this development variance permit or any amendment to it, are binding on all as who acquire an interest in the Land.	
8.	This d	evelopment variance permit is not a building permit.	
	ORIZIN D THIS	NG RESOLUTION PASSED BY THE COUNCIL, THE DAY OF , 20 . DAY OF , 20 .	
		Mayor - Doug McCallum	

City Clerk - Jennifer Ficocelli

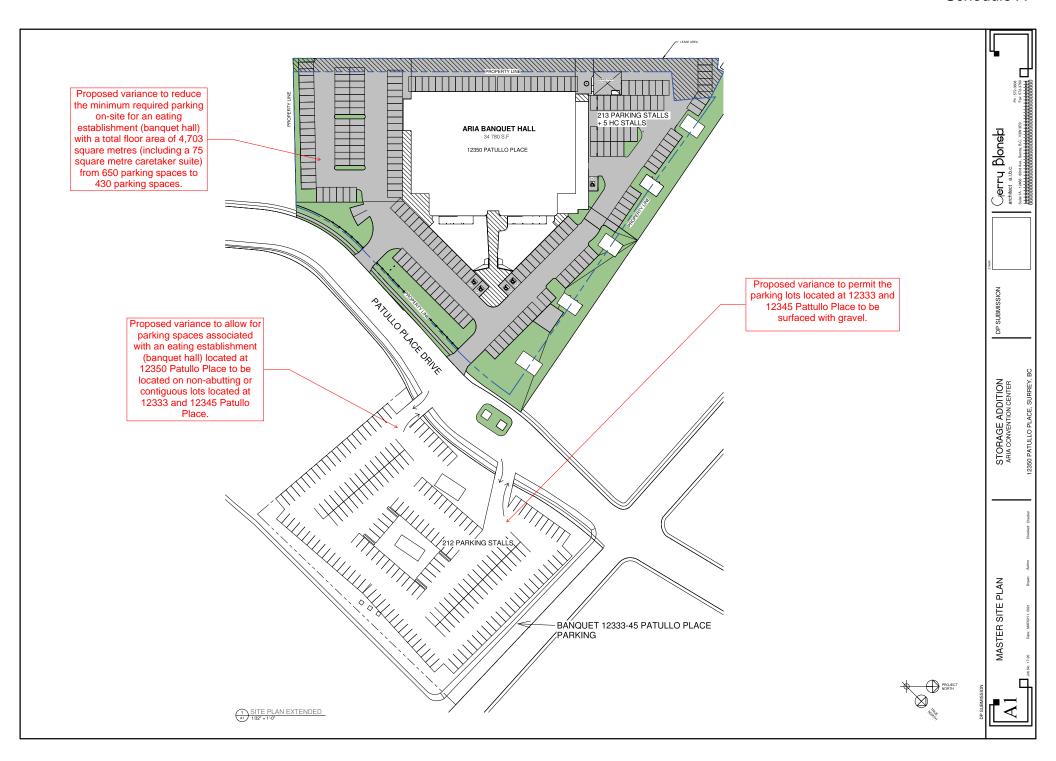



#### R.F. BINNIE & ASSOCIATES LTD.

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## Memorandum

То:	Parm Sanghera, Aria Convention Centre	From:	Ava Li, Binnie Kelly Bullivant, Binnie
Cc:	Genry Blonski, Genry Blonski Architect	Date:	June 28, 2022
Project Title:	Aria Convention Centre	File No.:	19-1125-05
Re:	Parking Study Memorandum - FINAL Rev.4		

#### 1 INTRODUCTION

#### 1.1 Background

R.F. Binnie & Associates Ltd. (Binnie) was retained by Aria Convention Centre (the Client) to prepare a parking study for the existing Aria Banquet Hall and Convention Centre (Aria Convention Centre), located at 12350 Pattullo Place in the City of Surrey (the City).

The objectives of this parking review are to:

- Review the existing building layout and proposed expansion site plan for the Aria Convention Centre:
- Review the existing on-site parking requirement based on the City's bylaw and parking generation rates published by the Institute of Transportation Engineers (ITE);
- Perform field visits to observe parking demands when events are held at Aria Convention Centre; and
- Propose strategies to address the parking shortfall based on field observations.

#### 1.2 Building Layout and Parking Provision

The Aria Convention Centre is located at 12350 Pattullo Place, just south of King George Boulevard and between Highway 17 and 120 Street. The project site is easily accessed via several adjacent arterial roadways, various bus routes that are part of TransLink's Frequent Transit Network (FTN), and the Scott Road SkyTrain Station which is located approximately 500 m east of the convention centre.

Based on information provided by the Client on June 10, 2022, the existing Aria Convention Centre building has a net floor area of 4,036 m² (including patio space) and a maximum capacity of 1,200 guests. The net floor area is comprised of 3,702 m² of indoor space and 334 m² of outdoor patio space.

Based on field visits conducted by Binnie, 231 parking spaces were counted on-site and approximately 156 non-marked parking spaces are available in a gravel parking lot located at 12333-45 Pattullo Place, just east of the convention centre, for a total of 387 parking spaces available for guests. There are also approximately 20 on-street parking spaces available on the west site of Pattullo Place and a



pay parking lot just north of the convention centre at 11125 124 Street that accommodates a further 97 parking spaces.

An expansion is currently being proposed for the convention centre to increase the storage space within the building (net addition of 392 m<sup>2</sup>), to provide an on-site caretaker suite (75 m<sup>2</sup>), and to increase the patio space outside the building (201 m<sup>2</sup>), while maintaining the current assembly area and guest capacity. The proposed expansion will increase the Aria Convention Centre to 4,169 m<sup>2</sup> of indoor space and 534 m<sup>2</sup> of outdoor patio space, for a total net floor area of 4,703 m<sup>2</sup>.

The project location is shown in Figure 1-1.



Figure 1-1: Project Location

#### 2 PARKING SUPPLY AND DEMAND ESTIMATE

The planned expansion of the storage space is not expected to generate new parking demand as it will not increase the current seating capacity of the convention centre; as such, it is expected that the existing building's parking demand will be maintained.

The caretaker suite is expected to generate a nominal amount of parking.

The outdoor patio space is noted to be supplementary to the indoor assembly area by providing additional ambiance and its use is weather dependent. As the patio space is physically separated from the banquet rooms by the lobby and bar areas, it cannot feasibly accommodate additional seating for an event. As such, the planned expansion of the outdoor patio space is not expected to generate new parking demand and the existing building's parking demand will be maintained.



#### 2.1 Bylaw Requirement

Based on the City's current zoning bylaw, 12000 Part 5: Off-Street Parking and Loading/Unloading, banquet halls require 14 parking spaces per 100 m<sup>2</sup> of gross floor area, balconies, terrace, and deck when the total building area is greater than or equal to 950 m<sup>2</sup>. Caretaker units generally require 2 parking spaces to be provided.

Given the proximity of the Aria Convention Centre to the FTN and SkyTrain, a 10% parking relaxation of the City's bylaw requirement is requested.

It is noted that a significant portion of the convention centre's floor area includes a planned expansion of storage space and patio space that is not expected to increase the current building's parking demand. As such, a variance to exclude the proposed increase of storage space and the patio in its entirety is requested.

The required and requested number of parking spaces necessary to satisfy the City's requirements are shown in **Table 2-1**.

Table 2-1: Required and Requested Parking Spaces

	Floor Area (m²)	Required Parking	Requested Parking
Assemby Area	3702	518	518
Storage Space	392	55	-
Patio Space	534	75	-
Caretaker Suite	75	2	2
sub-total	4703	650	520
10% FTN Relaxation	-	-65	-52
Total	4703	585	468

To accommodate the caretaker suite and the remaining floor area of 4,628 m² (including patio space) once the expansion is complete, 650 parking spaces will be necessary to satisfy the City's bylaw requirement. It is noted that this requirement is drastically higher than what is currently observed for events at Aria Convention Centre, which is discussed further in Section 4. Based on site visits conducted by Binnie, the maximum parking demand for the study site is expected to be 371 parking spaces, which is noted to be just slightly more than half of the City's bylaw requirement.

If the variance requests to provide a 10% relaxation to parking requirements due to the convention centre's proximity to the FTN and SkyTrain, and to exclude the storage space and patio space from the parking requirement calculation are granted, then only 468 parking spaces would be necessary to satisfy the City's requirements.

#### 2.2 Parking Generation Rates

The parking demand for the study site was estimated based on the parking generation rates published in ITE's Parking Generation Manual, 5<sup>th</sup> Edition. The Convention Centre (ITE Ref. 595) land use was assumed to be representative of the Aria Convention Centre.

Based on the average parking rate per attendee, it is estimated that the maximum parking demand for the convention centre is 372 parking spaces on weekdays and 480 parking spaces on weekends given its 1,200-guest capacity.

It is noted that the requested number of parking spaces necessary to satisfy the City's requirements are generally in line with the estimated weekend ITE parking generation rates.



#### 2.3 Proposed Parking Supply

Based on the proposed site plan provided by the Client, there will be a total of 430 parking spaces provided for convention centre guests and the caretaker unit after the proposed expansion is complete, with 218 parking spaces on-site and 212 parking spaces at the gravel parking lot located at 12333-45 Pattullo Place. Curb stops will be used at the gravel lot to delineate each parking space.

To supplement the provided parking supply, the Client has entered into an agreement to lease space from BC Hydro on the adjacent railway property to provide additional on-site parking spaces (inclusive of the 218 spaces noted above). The Client has also entered into an agreement with an adjacent property owner to allow vehicles for the convention centre to park in the 26 spaces available at 12355 Pattullo Place after 6:30 PM. There are also 20 on-street parking spaces available on the west site of Pattullo Place and 97 parking spaces available at a pay parking lot just north of the convention centre.

The provided and supplemental parking supply is shown in Table 2-2.

Table 2-2: Provided and Supplemental Parking Supply

	Location	Parking Supply
Provided Parking	On-Site	218
	12333-45 Pattullo Place	212
	sub-total	430
Supplemental Parking	On-street	20
	12355 Pattullo Place	26
	Pay Parking	97
	sub-total	143
	Total	573

As noted in **Section 2.1**, the City's parking bylaw requires 650 parking spaces; therefore, the provided parking supply of 430 parking spaces does not meet the City's parking requirements and there is a shortfall of 155 parking spaces. Taking the supplemental parking supply of 143 parking spaces surrounding the convention center into consideration would reduce this shortfall to 12 parking spaces.

If the variance requests to provide a 10% relaxation to parking requirements and to exclude the storage space and patio space from the parking requirement calculation are granted, then only 468 parking spaces would be necessary to satisfy the City's parking bylaw. While the provided parking supply of 430 parking spaces still does not meet the City's parking requirements, the shortfall is reduced to only 38 parking spaces. With the addition of the surrounding supplemental parking supply, it is expected that the parking requirements for the Aria Convention Centre would be accommodated.

The variance for the required and requested parking spaces are shown in Table 2-3.

Table 2-3: Parking Space Variance

	Required Parking	Requested Parking
Per City's Bylaw	650	468
Provided Parking	430	
Variance	155	38
Supplemental Parking	143	
Variance	12	n/a



#### 3 SITE OBSERVATIONS

Existing parking data was collected at the Aria Convention Centre on three separate occasions: November 29<sup>th</sup>, 2019, December 4<sup>th</sup>, 2019, and January 25<sup>th</sup>, 2020. The site visits were conducted on event days when the facility was expected to be operating at a "typical" capacity or near its maximum capacity to capture both the typical and maximum parking demand.

### 3.1 November 29th, 2019 Site Visit

The first site visit was conducted on Friday, November 29th, 2019, at 7 PM for two concurrent events running from 6 PM to 12 AM with approximately 600 guests total. The two events were a wedding and a social gathering.

Out of the 231 available on-site parking spaces, a total of 153 parked cars were observed on-site. A total of 16 cars were parked at the property located east of the convention centre, and 6 cars were parked on the west side of Pattullo Place adjacent to the convention centre. As the on-site parking was not at its capacity, it is assumed that all guests parked on-site. The parking distribution for this site visit is shown in **Figure 3-1**.

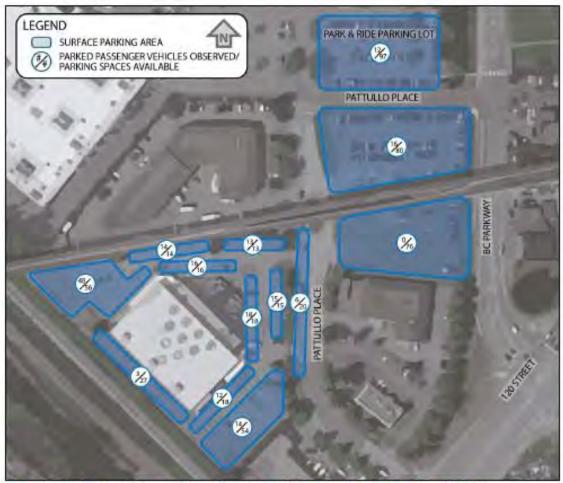


Figure 3-1: Observation on November 29th, 2019, Between 7:00 PM - 8:00 PM



## 3.2 December 4th, 2019 Site Visit

The second site visit was conducted on Wednesday, December 4<sup>th</sup>, 2019, at 10 AM for an event running from 9 AM to 2 PM with approximately 1,000 guests. The event was an education career fair for high school students.

Out of the 231 available on-site parking spaces, a total of 159 parked cars and 7 school buses were observed on-site. A total of 130 cars and 8 trailer trucks were parked at the property located east of the convention centre, and 3 cars were parked on the west side of Pattullo Place adjacent to the convention centre. The Client confirmed that the 8 trailer trucks parked on the separate property are not part of the event-generated traffic. As the on-site parking was not at its capacity, it is assumed that all guests parked on-site.

The parking distribution for this site visit is shown in Figure 3-2.



Figure 3-2: Observation on December 4th, 2019, Between 10:00 AM - 11:00 AM



# 3.3 January 25th, 2020 Site Visit

The third site visit was conducted on Saturday, January 25th, 2020, at 7 PM for two concurrent events running from 6 PM to 12 AM with approximately 900 guests total. The two events were a work party and a wedding.

Out of the 231 available on-site parking spaces, a total of 223 parked cars were observed on-site, which is generally considered to be at capacity. A total of 55 cars were parked at the property located east of the convention centre, and 12 cars were parked on the west side of Pattullo Place adjacent to the convention centre. It is assumed that the cars parked at the property located east of the convention centre are part of the convention centre generated traffic as the on-site parking was at capacity.

The parking distribution for this site visit is shown in Figure 3-3.

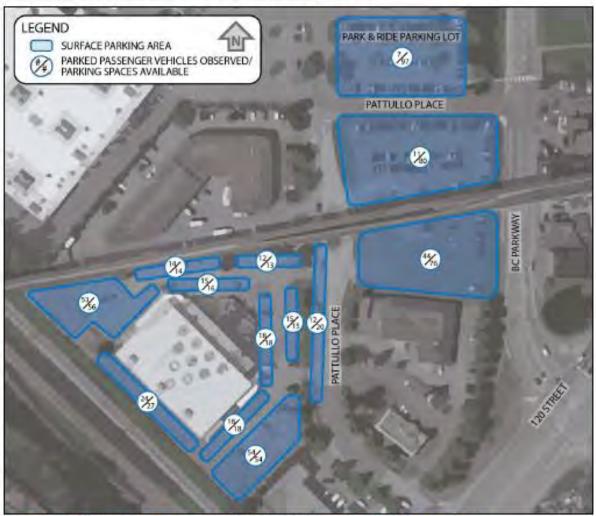


Figure 3-3: Observation on January 25th, 2020, Between 7:15 PM - 8:15 PM



#### 4 FINDINGS

Based on the site visit observations, there is a maximum parking demand rate of 0.31 parking spaces per guest. As the Aria Convention Centre has a maximum capacity of 1,200 guests, it is estimated that the maximum observed parking demand for the study site is 371 parking spaces.

This demand is noted to be significantly lower than the City's bylaw requirement, on-par with ITE's weekday parking generation rate, and moderately lower than ITE's weekend parking generation rate. Given that convention centres generally have many layouts for several different types of events, parking rates that are determined based on the maximum occupancy rate of the facility rather than the gross floor area of the facility are expected to be provide more accurate demand estimates.

The parking demand ratios from the site visits are summarized in Table 4-1.

Table 4-1: Parking Ratio Summary

Event Date	#Guests	#Parked Cars	Parking Ratio (to # Guests)
November 29th, 2019	600	169	0.28
December 4th, 2019	1000	289	0.29
January 25th, 2020	900	278	0.31

Based on the maximum observed parking demand of 371 parking spaces, the proposed parking supply of 430 parking spaces will be able to accommodate any event at the Aria Convention Centre. If there is ever a shortfall in the parking supply, there are additional parking opportunities in the vicinity of the study site, including on-street parking on the west side of Pattullo Place, the paid parking lot at 11125 124 Street to the north of the convention centre, and the evening-only parking agreement at 12355 Pattullo Place.

It is noted that the paid parking lot at 11125 124 Street is generally used as a park-and-ride facility by SkyTrain users and is typically only busy during standard work hours on weekdays. The Client has noted that larger events generally take place outside of standard work hours, i.e., on weekends or at nighttime. The field visits conducted on November 29<sup>th</sup>, 2019 and January 25<sup>th</sup>, 2020 were during large evening events and it is noted that the usage of this parking lot was minimal at that time. Therefore, if it is anticipated that an event will require more than 371 parking spaces, the Client could make advance arrangements for guests to park their cars at the adjacent pay parking lot just north of the convention centre.

As such, the site's variance request to reduce parking requirements by 10% due to FTN and SkyTrain proximity and to exclude the storage and patio spaces from the parking requirement calculation as they will not increase the current seating capacity and subsequent parking demand is considered acceptable from a transportation engineering standpoint based on the existing field conditions.

Memorandum Prepared by:

E 55 (September 15)

Kelly Bullivant, P.Eng.
Senior Transportation Engineer

Memorandum Reviewed by:

Ava Li, P.Eng. Project Manager

Att.: Appendix A: Proposed Site Plan

# **APPENDIX A**

PROPOSED SITE PLAN

