

City of Surrey PLANNING & DEVELOPMENT REPORT Application No.: 7920-0286-00

Planning Report Date: October 3, 2022

PROPOSAL:

 Rezoning from RF & RM-D to CD (based on RM-70)

• Development Permit

to permit the development of a 6-storey apartment building consisting of approximately 152 dwelling units in City Centre.

LOCATION: 9482 - 134 Street


9470 - 134 Street 9492 - 134 Street 13428 - 95 Avenue

ZONING: RF and RM-D

OCP DESIGNATION: Multiple Residential

CITY CENTRE Low to Mid Rise Residential

DESIGNATION:

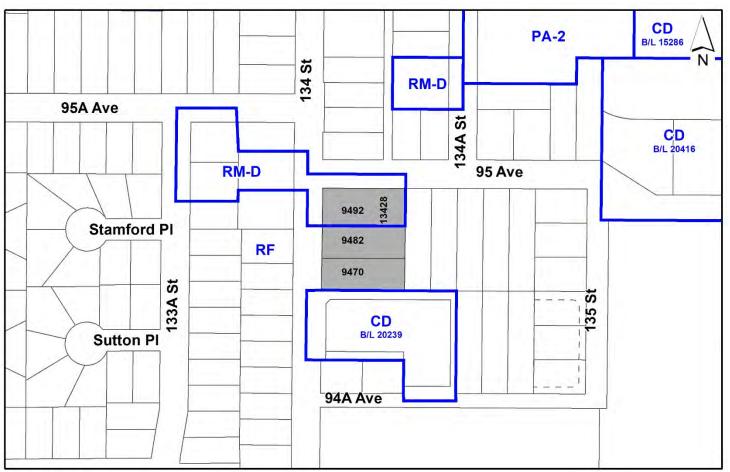

RECOMMENDATION SUMMARY

- By-law Introduction and set date for Public Hearing for Rezoning.
- Approval to draft Development Permit for Form and Character.

DEVIATION FROM PLANS, POLICIES OR REGULATIONS

None.

RATIONALE OF RECOMMENDATION

- The proposal complies with the Multiple Residential designation in the Official Community Plan (OCP).
- The proposal complies with the Low to Mid Rise Residential designation in the Surrey City Centre Plan.
- The proposal complies with the General Urban designation in the Metro Vancouver Regional Growth Strategy (RGS).
- The proposed density and 6-storey building form are appropriate for this part of City Centre.
- The proposal complies with the Development Permit requirements in the OCP for Form and Character.
- The proposed setbacks achieve a more urban, pedestrian streetscape in compliance with the guidelines in the City Centre Plan, and the proposed density and 6-storey building form are appropriate for this area of City Centre.
- The proposed building achieves an attractive architectural built form, which utilizes high quality, natural materials, and contemporary lines. The street interface has been designed to a high quality to achieve a positive urban experience between the proposed building and the public realm.

RECOMMENDATION

The Planning & Development Department recommends that:

- 1. A By-law be introduced to rezone the subject site from "Single Family Residential Zone (RF)" and "Duplex Residential Zone (RM-D)" to "Comprehensive Development Zone (CD)" and a date be set for Public Hearing.
- 2. Council authorize staff to draft Development Permit No. 7920-0286-00 generally in accordance with the attached drawings (Appendix I).
- 3. Council instruct staff to resolve the following issues prior to final adoption:
 - (a) ensure that all engineering requirements and issues including restrictive covenants, dedications, and rights-of-way where necessary, are addressed to the satisfaction of the General Manager, Engineering;
 - (b) submission of a subdivision layout to the satisfaction of the Approving Officer;
 - (c) resolution of all urban design issues to the satisfaction of the Planning and Development Department;
 - (d) submission of a finalized landscaping plan and landscaping cost estimate to the specifications and satisfaction of the Planning and Development Department;
 - (e) submission of a finalized tree survey and a statement regarding tree preservation to the satisfaction of the City Landscape Architect;
 - (f) provision of cash-in-lieu contribution to satisfy the indoor amenity space requirement of the RM-70 Zone, at the rate in effect at the time of Final Adoption;
 - (g) demolition of existing buildings and structures to the satisfaction of the Planning and Development Department; and
 - (h) registration of a Section 219 Restrictive Covenant to adequately address the City's needs with respect to public art, to the satisfaction of the General Manager Parks, Recreation and Culture and with respect to the City's Affordable Housing Strategy and Tier 1 Capital Project CACs, to the satisfaction of the General Manager, Planning & Development Services.

SITE CONTEXT & BACKGROUND

Direction	Existing Use	City Centre Plan Designation	Existing Zone
Subject Site	Single Family and	Low to Mid Rise	RF & RM-D
	Duplex Dwellings	Residential	
North (Across 95 Avenue):	Single Family	Low to Mid Rise	RF
	Dwellings	Residential	

Direction	Existing Use	City Centre Plan	Existing Zone	
		Designation		
East:	Single Family	Low to Mid Rise	RF	
	Dwellings	Residential		
South (Across future lane):	Construction of	Low to Mid Rise	CD Bylaw No.	
	two 6-storey	Residential	20239	
	apartment			
	buildings approved			
	under			
	Development			
	Application No.			
	7919-0370-00			
West (Across 134 Street):	Single Family	OCP: Urban	RF	
	Dwellings			

Context & Background

- The subject site is approximately 4,228 square metres in size and is comprised of three lots at the southeast corner of 134 Street and 95 Avenue. The site is located within the Medical District of City Centre.
- The subject properties are designated Multiple Residential in the Official Community Plan (OCP) and Residential Low to Mid Rise 2.5 FAR in the City Centre Plan. Two of the properties are zoned Single Family Residential Zone (RF), and the third is zoned Duplex Residential Zone (RM-D). Currently, there are single family dwellings located on two (2) lots (9470 and 9482 134 Street) and a duplex dwelling on one (1) lot (9492 134 Street & 13428 95 Avenue).
- The site slopes downward by approximately 2 metres from west to east.
- There are a few other development applications in this block, bounded by 134 and 135 Streets on the west and east, and 95 and 94A Avenues on the north and south:
 - Development Application No. 7919-0370-00 (9442 and 9456 134 Street and 13439 94A Avenue) to the south of the subject site was approved by Council on July 26, 2021, for two 6-storey apartment buildings. The Building Permit is currently in process.
 - Development Application No. 7917-0205-00 (9445/47, 9459/61 135 Street and 13491/93 135 Street) to the southeast of the subject site proposes a 6-storey apartment building and the Rezoning Bylaw was granted Third Reading by Council on May 7, 2018.
 - O Development Application No. 7920-0206-00 (13452/13454, 13460, 13474 95 Avenue) to the east of the subject site proposes a 6-storey apartment building and the Rezoning Bylaw was granted Third Reading by Council on February 14, 2022.
 - Development Application No. 7922-0168-00 (13453, 13461, 13473 94A Avenue) to the southeast of the subject site proposes a 6-storey apartment building and has not yet been brought forward to Council for consideration.

DEVELOPMENT PROPOSAL

Planning Considerations

- In order to permit the development of a 6-storey apartment building with 152 dwelling units, the applicant is proposing the following:
 - o Rezoning the site from RF and RM-D to CD (based on RM-70);
 - o Subdivision (consolidation) of three lots into one lot; and
 - o A Development Permit for Form and Character.

	Proposed			
Lot Area				
Gross Site Area:	4,228 square metres			
Road Dedication:	566 square metres			
Net Site Area:	3,662 square metres			
Number of Lots:	1			
Building Height:	21.8 metres			
Floor Area Ratio (FAR):	2.46 gross FAR; 2.83 net FAR			
Floor Area				
Residential:	10,382 square metres			
Commercial:	N/A			
Total:	10,382 square metres			
Residential Units:				
Studio:	6			
1-Bedroom:	109			
2-Bedroom:	37			
Total:	152			

Referrals

Engineering: The Engineering Department has no objection to the project

subject to the completion of Engineering servicing requirements as

outlined in Appendix II.

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School District: The School District has advised that there will be

approximately 48 school-age children generated by this development, of which the School District has provided the

following expected student enrollment.

17 Elementary students at Cindrich Elementary School 17 Secondary students at Queen Elizabeth Secondary School

(Appendix III)

Note that the number of school-age children is greater than the expected enrollment due to students attending private schools, home school or different school districts.

The applicant has advised that the dwelling units in this project are expected to be constructed and ready for occupancy by mid-2025.

Parks, Recreation & Culture:

No concerns.

The closest active park and closest nature area is Queen Elizabeth

Meadows Park and is 82 metres away.

Surrey Fire Department: No concerns. Comments provided are to be address as part of the

Building Permit application.

Advisory Design Panel: The proposal was considered at the ADP meeting on April 21, 2022

and was conditionally supported. The applicant has resolved most of the outstanding items from the ADP review as outlined in the Development Permit section of this report. Any additional revisions

will be completed prior to Council's consideration of Final

Adoption of the rezoning by-law, to the satisfaction of the Planning

and Development Department.

Transportation Considerations

• The applicant will provide the following road dedication as part of the current rezoning application:

- o 3.44 metres along 134 Street;
- o Minimum 5.60 metres along the green lane for a total ultimate 12.0 metre width; and
- O Corner cuts at 134 Street and 95 Avenue, and 134 Street and the green lane.
- Parking for the development is proposed to be located in a two-level underground parkade, which will be accessed from the green lane along the south property line.
- The subject site is located approximately 300 metres from King George Boulevard, which is an existing Frequent Transit Network (FTN) and future rapid transit corridor, and approximately 1.2 kilometers from the King George Skytrain Station.

Sustainability Considerations

- The applicant has met all of the typical sustainable development criteria, as indicated in the Sustainable Development Checklist.
- The applicant has indicated the project will meet Step 2 of the BC Energy Step Code with connection to the City Centre District Energy System.

POLICY & BY-LAW CONSIDERATIONS

Regional Growth Strategy

• The proposal complies with the General Urban designation in the Metro Vancouver Regional Growth Strategy (RGS).

Official Community Plan

Land Use Designation

• The proposal complies with the Multiple Residential designation in the Official Community Plan (OCP).

Themes/Policies

- The proposed development is consistent with the following guiding policies and objectives in the OCP:
 - Support compact and efficient land development that is consistent with Metro Vancouver Regional Growth Strategy (OCP Policy A1);
 - Accommodate higher density development into Surrey's City Centre and near Frequent Transit Corridors at density sufficient to encourage commercial development and transit service expansions (A2);
 - o Encourage development in urban neighbourhoods to utilize existing infrastructure and amenities and to enhance existing neighborhood character and viability (A₃);
 - Encourage Development that supports increased transit, pedestrian walkability, and bicycle access (B₃);
 - Develop complete, accessible, and walkable green neighbourhoods with sufficient densities to support a high-quality transit system that is accessible to most residents (B4); and
 - Ensure new development responds to the existing architectural character and scale of its surroundings, creating compatibility between adjacent sites and within neighbourhoods (B6).

Secondary Plans

Land Use Designation

• The proposal complies with the Residential Low to Mid Rise 2.5 FAR designation in the Surrey City Centre Plan.

Themes/Objectives

- The proposed development is consistent with the following guiding principles:
 - Encourage Housing Diversity, by providing a variety of housing forms and a range of unit sizes and types;
 - o Break up the Block Size, by contributing to a fine-grained street network that provides a variety of transportation routes and increases mobility choices;
 - o Create Vibrant Urban Spaces, with high quality architectural aesthetics and amenities such as plazas to encourage people to interact with the public realm; and
 - o Promoting identity and a sense of place, by contributing to the emerging neighbour character in this medium-density residential pocket of the Medical District.

CD By-law

- The applicant is proposing a "Comprehensive Development Zone (CD)" to accommodate a proposed 6-storey apartment building on the subject site. The proposed CD By-law for the proposed development site identifies the uses, densities and setbacks proposed. The CD By-law will have provisions based on the "Multiple Residential 70 Zone (RM-70)".
- A comparison of the density, lot coverage, setbacks, building height and permitted uses in the RM-70 Zone and the proposed CD By-law is illustrated in the following table:

Zoning	RM-70 Zone (Part 24)	Proposed CD Zone
Floor Area Ratio:	1.50 FAR (net)	2.83 FAR (net)
Lot Coverage:	33%	50%
Yards and Setbacks		
North (95 Ave):	7.5 m	4.5 m
East:	7.5 m	3.0 m
South (green lane):	7.5 m	4.5 m
West (134 Street):	7.5 m	4.5 m
Principal Building Height:	50.0 m	22.0 m
Permitted Uses:	 Multiple unit residential buildings Ground-oriented multiple unit residential buildings Child care centres 	 Multiple unit residential buildings Ground-oriented multiple unit residential buildings
Indoor Amenity:	3.0 sq. m. per dwelling unit 1.0 sq. m. per lock-off suite 4.0 sq. m. per micro unit 3.0 sq. m. per dwelling unit	The proposed 363 m² + CIL of \$80,000 meets the Zoning Bylaw requirement.
Outdoor Amenity:	1.0 sq. m. per lock-off suite 4.0 sq. m. per micro unit	The proposed 461 m² meets the Zoning By-law requirement.
Parking (Part 5)	Required	Proposed
Number of Stalls	,	
Residential:	137	144

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Residential Visitor: Total:	15 152	17 161
Accessible:	3	4
Bicycle Spaces		
Residential Secure Parking:	182	186
Residential Visitor:	6	6

- The floor area ratio (FAR) has been increased from 1.5 net FAR in the RM-70 Zone to 2.83 net FAR in the CD Zone. The proposed density complies with the City Centre Plan.
- The maximum lot coverage has been increased from 33% in the RM-70 Zone to 50% in the CD Zone to accommodate the built form, which is generally consistent with other similar 6-storey apartment developments in the City Centre Plan area.
- The reduced setbacks along frontages (134 Street, 95 Avenue and the green lane) and the east property line achieve a more urban, pedestrian-oriented streetscape, consistent with the goals and objectives of the City Centre Plan.
- The applicant is proposing to exceed the minimum parking requirements with 144 residential parking spaces (137 required), and 17 visitor parking spaces (15 required), for a total of 161 parking spaces (152 required).
- The proposed bicycle parking complies with the minimum requirement.

Capital Projects Community Amenity Contributions (CACs)

- On December 16, 2019, Council approved the City's Community Amenity Contribution and Density Bonus Program Update (Corporate Report No. R224; 2019). The intent of that report was to introduce a new City-wide Community Amenity Contribution (CAC) and updated Density Bonus Policy to offset the impacts of growth from development and to provide additional funding for community capital projects identified in the City's Annual Five-Year Capital Financial Plan.
- The proposed development will be subject to the Tier 1 Capital Plan Project CACs. The contribution will be payable at the rate applicable at the time of Building Permit Issuance. The current rate is \$2,000 per new unit.
- The proposed development will not be subject to the Tier 2 Capital Plan Project CACs as the proposal complies with the densities in the Secondary Plan designation.

Affordable Housing Strategy

- On April 9, 2018, Council approved the City's Affordable Housing Strategy (Corporate Report No. Ro66; 2018) requiring that all new rezoning applications for residential development contribute \$1,000 per new unit to support the development of new affordable housing. The funds collected through the Affordable Housing Contribution will be used to purchase land for new affordable rental housing projects.
- The applicant will be required to register a Section 219 Restrictive Covenant to address the City's needs with respect to the City's Affordable Housing Strategy.

Public Art Policy

• The applicant will be required to provide public art or register a Restrictive Covenant agreeing to provide cash-in-lieu, at a rate of 0.5% of construction value, to adequately address the City's needs with respect to public art, in accordance with the City's Public Art Policy requirements. The applicant will be required to resolve this requirement prior to consideration of Final Adoption.

PUBLIC ENGAGEMENT

• Pre-notification letters were sent on September 29, 2021, and the Development Proposal Signs were installed on October 1, 2021. Staff received two responses from neighbouring residents requesting clarification on the proposal.

DEVELOPMENT PERMITS

Form and Character Development Permit Requirement

- The proposed development is subject to a Development Permit for Form and Character and is also subject to the urban design guidelines in the Surrey City Centre Plan.
- The proposed development generally complies with the Form and Character Development Permit guidelines in the OCP and the design guidelines in the Surrey City Centre Plan.
- The applicant is proposing a 6-storey apartment building containing 152 units, consisting of 6 studio units, 189 one-bedroom units and 89 two-bedroom units. The units range in size from 39 square metres to 91 square metres.
- The proposed 6-storey apartment development incorporates a design and building massing that is generally in accordance with the vision for this part of City Centre. This area is envisioned as a medium density residential neighbourhood of apartments, connected to neighbourhood parks and schools with a finer grained street network with green lanes and pedestrian pathway systems.
- The proposed apartment building is U-shaped to frame three frontages: 134 Street to the west, 95 Avenue to the north, and the green lane to the south. A central courtyard is located at the southeast corner of the site, where the indoor and outdoor amenity spaces are located.
- The applicant proposes an urban contemporary design and extensive use of brown brick on the lower two levels on the façade fronting 134 Street.
- All ground-oriented units will have their own usable, semi-private outdoor patio space with direct access to the street or lane.
- Building materials include cement panels, aluminum cladding, horizontal woodgrain siding, and brick. The brick contributes to a high-quality pedestrian-scale character.

- The proposed indoor and outdoor amenity spaces have been integrated for site functionality and efficiency. For more details, see the Indoor and Outdoor Amenity Space sections in this report.
- The applicant has worked with staff to address ADP and staff comments favorably. In particular the applicant has worked to:
 - Establish appropriate setbacks;
 - o Create strong public realm interfaces along the streets on this sloping site, with comfortable main floor to grade relationships;
 - o Develop an accessible relationship between the indoor and outdoor amenity spaces at grade in the courtyard; and
 - Design appropriate architectural expression, scale, and top floor step back within the context of being situated across from the long-term single family residential area at 134 Street.

Landscaping

- The proposed landscaping for the site includes a mix of trees, shrubs, groundcover, along with hardscaping, site lighting, fencing, and site furnishings.
- The landscaping concept centres around three areas, an entrance amenity area adjacent to the building entrance along 134 Street, the ground-oriented unit entrances along street frontages, and the outdoor courtyard areas to the southeast of the building.
- Pathways provide for pedestrian circulation around the site and provide access to the outdoor amenity courtyard at the southeast corner of the site from the green lane.
- At grade units have patio spaces with feature paving, trees, shrubs, and fencing with gates to create semi-private outdoor spaces for residents.

Indoor Amenity

- The required indoor amenity is 456 square metres, while the applicant is proposing to provide 363 square metres of indoor amenity space on site, requiring cash-in-lieu for the shortfall in accordance with City policy.
- The indoor amenity space is located on the first level of the north side of the building, facing the outdoor amenity courtyard.
- The indoor amenity space consists of a gym, meeting room, lounge area, kitchen, and accessible washrooms.
- The kitchen and lounge area opens up onto the outdoor amenity courtyard.

Outdoor Amenity

- The required outdoor amenity is 456 square metres. The applicant is proposing 461 square metres of outdoor amenity, exceeding the minimum requirement.
- The proposed outdoor amenity is organized into five areas.
- The outdoor amenity courtyard to the south of the building consists of an outdoor barbeque
 and seating area adjacent to the indoor amenity area, a dining area with tables and chairs, a
 lounge area with artificial turf, community garden plots, a children's play area, benches for
 seating, and a dog park.

Outstanding Items

- The project was considered at the Advisory Design Panel (ADP) meeting on April 21, 2022 and received conditional support. The Panel provided comments to guide the refinement of the proposed apartment building and associated landscaping.
- The applicant is required to resolve all outstanding urban design and landscaping issues and Advisory Design Panel comments, including:
 - Coordinate and further develop the public realm interface, including grading, servicing integration, and minimizing retaining walls; and
 - o Further refine details of the architectural elevations, material application, elements.

TREES

 Xudong Bao, ISA Certified Arborist of M2 Landscape Architecture prepared an Arborist Assessment for the subject property. The table below provides a summary of the tree retention and removal by tree species:

Table 1: Summary of Tree Preservation by Tree Species:

Tree Species	Existing	Remove	Retain			
Deciduous Trees (excluding Alder and Cottonwood Trees)						
`	g Alder and Cottonwo	ood Trees)				
English Walnut	1	1	0			
Norway Maple	1	1	0			
European Hornbeam	4	4	0			
Coniferous Trees						
Sawara Cypress	2	2	0			
Western Red Cedar	3	3	0			
Douglas Fir	3	3	0			
Leyland Cypress	1	1	0			
Lawson Cypress	1	1	0			
White Spruce	1	1	0			
Norway Spruce	1	1	0			
Oriental Spruce	1	1	0			

Tree Species	Ex	isting	Remove	Retain
Total (excluding Alder and Cottonwood Trees)	19		9 19	
Total Replacement Trees Proposed (excluding Boulevard Street Trees)		38		
Total Retained and Replacement Trees		38		
Contribution to the Green City Program		NA		

- The Arborist Assessment states that there are a total of 19 mature trees on the site, with no Alder and Cottonwood trees. It was determined that no trees can be retained as part of this development proposal. The proposed tree retention was assessed taking into consideration the location of services, building footprints, road dedication and proposed lot grading.
- For those trees that cannot be retained, the applicant will be required to plant trees on a 2 to 1 replacement ratio for all other trees. This will require a total of 38 replacement trees on the site. The applicant is proposing 38 replacement trees, meeting City requirements.
- In addition to the replacement trees, boulevard street trees will be planted on 134 Street and 95 Avenue. This will be determined by the Engineering Department during the servicing design review process.
- The new trees on the site will consist of a variety of trees including Japanese Maple, White Wonder Dogwood, and Flowering Ash.
- In summary, a total of 38 trees are proposed to be retained or replaced on the site with no contribution to the Green City Program.

CITY ENERGY

- The subject site is located within Service Area A, as defined in the "City Centre District Energy System By-law" (see Appendix VI for location). The District Energy System consists of three primary components:
 - o community energy centres, City-operated facilities that generate thermal energy for distribution through a piped hot water network;
 - distribution piping that links the community energy centres with buildings connected to the system; and
 - City-owned energy transfer stations (ETS) located within the building connected to the system. The ETS transfers heat energy from the distribution system to the building's mechanical system and is used to meter the amount of energy used.

- All new developments within Service Area A with a build-out density equal to or greater than a floor area ratio (FAR) of 1.0 will be required to provide hydronic thermal energy systems in support of the City's District Energy (DE) system including domestic hot water, make-up air units and in-suite hydronic space heating. The City is committed to having the DE system operational within the timeframe of this project. Therefore, the subject application will be required to connect to the City's DE system prior to occupancy.
- In order to avoid conflicts between the District Energy System and other utilities, the location of the ETS and related service connections are confirmed by Engineering and the applicant at the servicing agreement stage. The Engineering Department also requires the applicant to register a statutory right-of-way and Section 219 Restrictive Covenant over the subject site for the following purposes:
 - o City access to, and maintenance and operation of, the ETS within the building and any infrastructure between the building and the property line; and
 - o to prevent conflicts with other utilities.
- Prior to the issuance of a building permit, the Engineering Department will confirm that the applicant has met the requirements of the "City Centre District Energy System By-law".

INFORMATION ATTACHED TO THIS REPORT

The following information is attached to this Report:

Appendix I. Site Plan, Building Elevations, Landscape Plans and Perspective

Appendix II. Engineering Summary
Appendix III. School District Comments

Appendix IV. Summary of Tree Survey and Tree Preservation

Appendix V. ADP Comments and Response

Appendix VI. District Energy Map

approved by Ron Gill

Jeff Arason Acting General Manager Planning and Development

SR/cm

Appendix I

SYNC 134 QE APARTMENTS



sheet schedule

PROJECT DATA SD1.01 PROJECT DATA SD1.02 CONTEXT PLANS SD1.04 CONTEXT PLAN - EXISTING CONDITIONS SD1.05 CONTEXT PLAN - INTERIM PROPOSED SD1.06 CONTEXT PLAN - ULTIMATE PROPOSED SD1.07 PRECEDENT IMAGES SD1.08 DESIGN RATIONALE SD1.09 SD1.11 STREETSCAPES MASSING DIAGRAMS SD1.12 SITE PLAN SD1.20 SD1.21 DETAILED BASE PLAN FIRE DEPARTMENT SITE PLAN SD1.22 SITE SECTIONS SD1.23 SITE SECTIONS SD1.24 SITE SECTIONS SD1.25 SD1.26 SITE SECTIONS ENLARGED SECTIONS SD1.27 ENLARGED SECTIONS SD1.28 ENLARGED SECTIONS SD1.29 ENLARGED SECTIONS SD1.30 ENLARGED SECTIONS SD1.31 ENLARGED SECTIONS SD1 32 ENLARGED SECTIONS SD1.33 ENLARGED ELEVATIONS SD1.34 SD1.35 SHADOW STUDY 3D MASSING PERSPECTIVES 3D MASSING PERSPECTIVES SD1.36 SD1.37 3D RENDERING SD1.38 MATERIAL BOARD SD1.39 MATERIAL BOARD
ENLARGED PLAN - AMENITY SPACE
PARKADE LEVEL PLANS
1ST - 2ND LEVEL PLAN SD2.07 SD3.01 SD3.02 SD3.03 3RD - 6TH LEVEL PLAN ROOF LEVEL PLAN SD3.04 BUILDING ELEVATIONS SD4.01 BUILDING ELEVATIONS BUILDING ELEVATIONS SD4.02 SD4.03

sync properties

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DEVELOPMENT PERMIT RESUBMISSION

2022-09-13 REVISION #:

PROJECT NUMBER: 20-119



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PROJECT SYNC 134 OF APARTMENTS

PROPOSED ZONING: CD (COMPREHENSIVE DEVELOPMENT ZONE)(BASED ON RM-70)

CIVIC ADDRESS: 12661, 110 AVENUE, SURREY, B.C.

LEGAL DESCRIPTION: LOTS 1 & 2 PLAN NWS2481 AND LOTS 2 & 3 PLAN 14014 SECTION 32 TOWNSHIP 2 NEW WESTMINSTER DISTRICT

VARIANCES APPLIED FOR: BYLAW EXEMPTIONS:

BUILDING AREA DEFINITION (BCBC 2018):

THE GREATEST HORIZONTAL AREA OF A BUILDING ABOVE GRADE WITHIN THE OUTSIDE SURFACE OF EXTERIOR WALLS OR WITHIN THE OUTSIDE SURFACE OF EXTERIOR WALLS

FSR DEFINITION (ZONING): THE FIGURE OBTAINED WHEN THE AREA OF ALL THE FLOORS OF THE BUILDINGS CONSTRUCTED OR PROPOSED TO BE CONSTRUCTED ON A LOT IS DIVIDED BY THE AREA OF THE LOT, SUBJECT TO THE FOLLOWING:

(A) THE FLOOR AREA OF THE BUILDING SHALL BE MEASURED TO THE LESSER OF THE OUTSIDE EDGE OF THE EXTERIOR WALLS OR SHEATHING, EXCLUDING BASEMENTS, CRAWL

SPACES LESS THAN OR FOLIAL TO 1.5 METRES IS ET LICIEAR HEIGHT. BALCONIES, CANODIES, TERRACES AND DECKS-(B) WHEN CALCULATING THE FLOOR AREA RATIO, UNDEVELOPABLE AREAS ARE EXCLUDED FROM THE LOT AREA IN ALL ZONES OTHER THAN IN THE SINGLE FAMILY RESIDENTIAL

ZONES EXCEPT IN RAI RAIG RHIAND RHG ZONES WHERE THE EXCLUSION OF THE LINDEVELOPABLE AREAS IN THE RAIR AS GONES RESULTS IN A LOT SIZE THAT IS LESS THAN THE MINIMUM LOT SIZE PERMITTED IN SECTION K OF THE ZONE, THE FLOOR AREA RATIO SHALL BE CALCULATED USING THE MINIMUM LOT SIZE PERMITTED IN THA

(C) THOSE AREAS LISED AS AN ACCESSORY LISE FOR PARKING WITHIN THE RUIL DING ENVELOPE OR LINDERGROUND PARKING ARE EXCLUDED. AND (D) WHERE PARKING IS A PRINCIPAL USE OF THE LOT, THOSE AREAS WHICH ARE USED FOR PARKING WITHIN THE OUTERMOST WALLS OF A BUILDING OR UNDERGROUND SHALL

BE COUNTED IN THE CALCULATION.

GROSS FLOOR AREA DEFINITION (ZONING):

ALL THE AREA OF THE FLOOR ENCLOSED BY THE OUTSIDE EDGE OF THE EXTERIOR WALLS OF A BUILDING, INCLUDING WITHOUT LIMITATION STAIRWAYS, ELEVATOR SHAFTS,

EXISTING GRADE DEFINITION (ZONING): MEANS THE LOWEST GROUND FLEVATION EXISTING PRIOR TO CONSTRUCTION, AS ESTABLISHED ON A LEGAL SURVEY PLAN BY A REGISTERED BRITISH COLUMBIA LAND. SURVEYOR, SUCH GROUND ELEVATION TO INCLUDE FILL MATERIALS PLACED ON THE LOT TO RAISE THE GROUND ELEVATION UP TO, BUT NOT ABOVE, THE AVERAGE ELEVATION

OF ADJACENT LOTS AT THE ADJOINING LOT LINES.

FINISHED GRADE DEFINITION (ZONING):

(A) THE ROUGH GRADING ELEVATION AS IDENTIFIED ON A LOT GRADING PLAN, WHERE SUCH A PLAN HAS BEEN APPROVED BY THE CITY AT THE TIME OF SUBDIVISION WHEN THE

LOT WAS CREATED; OR

(B) WHERE THERE IS NO LOT GRADING PLAN THAT WAS APPROVED BY THE CITY AT THE TIME OF SUBDIVISION WHEN THE LOT WAS CREATED, THE LOWEST GROUND ELEVATION EXISTING PRIOR TO CONSTRUCTION, AS ESTABLISHED ON A LEGAL SURVEY BY A REGISTERED BRITISH COLUMBIA LAND SURVEYOR, SUCH GROUND ELEVATION TO INCLUDE FILL

MATERIALS PLACED ON THE LOT TO RAISE THE GROUND ELEVATION UP TO, BUT NOT ABOVE, THE AVERAGE ELEVATION OF ADJACENT LOTS AT THE ADJOINING LOT LINES.

BUILDING HEIGHT DEFINITION (ZONING):

THE VERTICAL DISTANCE MEASURED FROM THE AVERAGE EXISTING GRADE LEVEL, DETERMINED BY AVERAGING THE EXISTING GRADES AT ALL BUILDING FACES SURROUNDING THE PERIMETER OF A BUILDING, TO:

(A) THE HIGHEST POINT ON A FLAT ROOF: OR

(B) THE AVERAGE LEVEL BETWEEN THE EAVES AND RIDGE OF A GABLE, HIP OR GAMBREL ROOFED BUILDING; OR

(C) THE GREATER OF THE TWO MEASUREMENTS REFERRED TO IN (A) AND (B) ABOVE IN THE CASE OF A BUILDING WITH MORE THAN ONE TYPE OF ROOF; OR

(D) THE HIGHEST POINT OF A FLAT ROOF WITH A WIDTH GREATER THAN 1 METRE [3 FT.] AND LOCATED OVER A GABLE, HIP, OR GAMBREL ROOF, ELEVATOR SERVICE ROOMS, AIR CONDITIONERS AND SIMILAR EQUIPMENT, AND DORMERS AND OTHER SIMILAR ROOF ELEMENTS SHALL NOT BE INCLUDED IN THE

MEASUREMENT OF BUILDING HEIGHT PROVIDED THAT, IN AGGREGATE, THEY DO NOT EXCEED 25% OF THE PLAN VIEW AREA OF THE ROOF ON WHICH THEY ARE LOCATED.

MAXIMUM BUILDING HEIGHT (ZONING & BCBC 2018): 6 STOREYS (BASED ON RM-135) / 6 STOREYS (BCBC 3.2.2.50)

AVERAGE GRADE (ZONING): WEST ELEVATION - 70.92m; NORTH ELEVATION - 69.67m; EAST ELEVATION - 68.08m; SOUTH ELEVATION - 69.73m

LOWEST AVERAGE GRADE (BCBC 2018): 68.08m

PROPOSED BUILDING HEIGHT (BCBC 2018): 6 STOREY - 21.75m

1ST STOREY TO UPPERMOST FLOOR LEVEL: MAXIMUM - 18m [BCBC 2018, GROUP C 3.2.2.50 (1)(c)] PROPOSED - 15.83m

1ST STOREY TO UPPERMOST ROOF MAXIMUM - 25m [BCBC 2018, GROUP C 3.2.2.50 (2)(c), NON-COMBUSTIBLE ROOF CONSTRUCTION IF > 25m] PROPOSED - 21.75m

FIRE ACCESS ROUTE TO UPPERMOST FLOOR LEVEL: MAXIMUM - 20m (BCBC 2018 3.2.5.6(2)) PROPOSED - 18.77m

BUILDING HEIGHT NUMBERS/REFERENCES ABOVE APPLY TO GROUP C UP TO 6 STOREY/COMBUSTIBLE/SPRINKLERED BLDG'S. NOT APPLICABLE FOR OTHER BUILDINGS NOTES (FOR REFERENCE, DELETE):

SITE AREA-45 515 S.F. (4 228 S.M.)

LOT COVERAGE: 19,582 S.F. / 45,515 S.F. = 43.0% (BEFORE DEDUCTIONS) 19,582 S.F. / 39,423 S.F. = 49.5% (AFTER DEDUCTIONS) NORTH BUILDING = 5,518 S.F. (512.64 S.M.) SOUTH BUILDING = 14,129 S.F. (1,312.63 S.M.) = 19,649 S.F. (1,825.45 S.M.) BUILDING AREA:

94.344 S.F. (RESIDENTIAL) + 19.757 S.F. (AMENITY SPACE, CIRCULATION, STORAGE) = 114.101 S.F. (10.600.33 S.M.) GROSS FLOOR AREA (NOT INCLUDING PARKADE):

GROSS FLOOR AREA (PARKADE ONLY):

= 114,101 S.F. (GROSS FLOOR AREA) - 2,355 S.F. (AMENITY SPACE) / 45,515.00 S.F. (SITE AREA) = 2.46 SETBACKS: FRONT (134 STREET) = 4.50m, REAR = 3.00m, SIDE (95 AVENUE) = 4.50m, SIDE (SOUTH) = 9.00m,

LEVEL / AREA TYPE	AREA SF	AREA m²	AREA %	COMMENTS
P2 LEVEL				
CIRCULATION	1160 SF	107.72 m ²	0.6%	
PARKADE	30599 SF	2842.70 m ²	16.8%	
SERVICES	26 SF	2.37 m ²	0.0%	
STORAGE	2928 SF	272.00 m ²	1.6%	
STORAGE	34711 SF	3224.79 m²	19.0%	
	34/113	3224.79 III	19.0%	
P1 LEVEL				
CIRCULATION	1158 SF	107.61 m ²	0.6%	
INDOOR AMENITY	1551 SF	144.05 m²	0.9%	
PARKADE	27430 SF	2548.35 m ²	15.1%	
SERVICES	1462 SF	135.86 m²	0.8%	
STORAGE	1815 SF	168.60 m²	1.0%	
	33416 SF	3104.47 m²	18.3%	
1ST LEVEL- WEST				
CIRCULATION	3679 SF	341.75 m²	2.0%	
COMMON AREA	171 SF	15.87 m ²	0.1%	
INDOOR AMENITY	2355 SF	218.74 m ²	1.3%	
RESIDENTIAL	13097 SF	1216.78 m²	7.2%	
SERVICES	281 SF	26.11 m²	0.2%	
ocitioes .	19582 SF	1819.25 m²	10.7%	
2ND LEVEL				
CIRCULATION	2687 SF	249.64 m ²	1.5%	
RESIDENTIAL	15862 SF	1473.60 m²	8.7%	
SERVICES	105 SF	9.71 m ²	0.1%	
	18653 SF	1732.95 m ²	10.2%	
3RD LEVEL				
CIRCULATION	2517 SF	233.81 m ²	1.4%	
RESIDENTIAL	16702 SF	1551.70 m ²	9.2%	
SERVICES	104 SF	9.67 m ²	0.1%	
	19323 SF	1795.17 m ²	10.6%	
4TH LEVEL				
CIRCULATION	2535 SF	235.55 m ²	1.4%	
RESIDENTIAL	16683 SF	1549.94 m²	9.2%	
SERVICES	103 SF	9.58 m ²	0.1%	
	19322 SF	1795.06 m ²	10.6%	
STH LEVEL				
CIRCULATION	2512 SF	233.33 m ²	1.4%	
RESIDENTIAL	16708 SF	1552.24 m²	9.2%	
SERVICES	104 SF	9.67 m²	0.1%	
021111020	19324 SF	1795.24 m²	10.6%	
6TH LEVEL				
CIRCULATION	2502 SF	232.43 m ²	1.4%	
RESIDENTIAL	15305 SF	1421.90 m²	8.4%	
SERVICES	104 SF	9.69 m²	0.1%	
	17911 SF	1664.02 m ²	9.8%	
AREA GRAND TOTAL	182243 SF	16930.96 m ²	100.0%	



0.2.0 gross floor area summary (level)

0.3.0 unit count summary

UNIT TYPE	UNIT COUNT	UNIT TYPE %	COMMENTS
1 BED	104	68.4%	
1 BED & DEN	5	3.3%	
2 BED	24	15.8%	
2 BED & DEN	13	8.6%	
STUDIO	6	3.9%	
TOTAL UNITS: 152		100.0%	

0.4.0 unit floor area summary note

ALL UNIT AREAS ARE MEASURED TO THE FOLLOWING: A) EXTERIOR WALL: EXTERIOR SIDE OF SHEATHING. B) PARTY WALL: CENTER OF WALL. C) CORRIDOR/STAIR/ELEVATOR WALL: FULL THICKNESS OF WALL

AREAS GIVEN ON DRAWINGS AND IN SCHEDULES ARE NOT TO BE CONSIDERED LEGAL STRATA AREAS. CONFIRM STRATA AREAS BY SURVEY ON SITE

0.4.1 unit floor area summary

UNIT	UNIT TYPE	COUNT	UNIT AREA SF (1SF)	UNIT AREA m² (1m²)	TOTAL UNIT AREA SF	TOTAL UNIT AREA m ²
UNIT A1	STUDIO	5	483 SF	45 m²	2416 SF	224.48 m ²
UNIT A2	STUDIO	1	415 SF	39 m²	415 SF	38.57 m ²
UNIT B1	1 BED	4	537 SF	50 m ²	2149 SF	199.63 m ²
UNIT B2	1 BED	6	531 SF	49 m²	3186 SF	296.03 m ²
UNIT B3	1 BED	6	511 SF	48 m ²	3069 SF	285.08 m ²
UNIT B3.1	1 BED	1	473 SF	44 m²	473 SF	43.97 m ²
UNIT B3.2	1 BED	5	473 SF	44 m²	2366 SF	219.82 m ²
UNIT B4	1 BED	6	584 SF	54 m²	3503 SF	325.43 m ²
UNIT B4.1	1 BED	9	569 SF	53 m²	5118 SF	475.44 m ²
UNIT B5	1 BED	1	517 SF	48 m²	517 SF	48.00 m ²
UNIT B5.1	1 BED	1	571 SF	53 m²	571 SF	53.04 m²
UNIT B6	1 BED	5	618 SF	57 m ²	3091 SF	287.20 m ²
UNIT B7	1 BED	5	518 SF	48 m²	2589 SF	240.55 m ²
UNIT B8	1 BED	27	573 SF	53 m ²	15469 SF	1437.12 m ²
UNIT B8.1	1 BED	3	557 SF	52 m ²	1672 SF	155.29 m ²
UNIT B8.2	1 BED	2	572 SF	53 m²	1144 SF	106.28 m ²
UNIT B9	1 BED	2	609 SF	57 m²	1217 SF	113.08 m²
UNIT B9.1	1 BED	3	580 SF	54 m ²	1740 SF	161.66 m ²
UNIT B10	1 BED	5	502 SF	47 m²	2510 SF	233.21 m ²
UNIT B11	1 BED	5	571 SF	53 m²	2856 SF	265.30 m ²
UNIT B12	1 BED	1	670 SF	62 m²	670 SF	62.20 m ²
UNIT B13	1 BED	1	521 SF	48 m²	521 SF	48.37 m ²
UNIT B13.1	1 BED	5	521 SF	48 m²	2604 SF	241.92 m ²
UNIT B14	1 BED	1	457 SF	42 m²	457 SF	42.50 m ²
UNIT C	1 BED & DEN	5	697 SF	65 m²	3485 SF	323.73 m ²
UNIT D1	2 BED	2	834 SF	77 m²	1667 SF	154.89 m ²
UNIT D1.1	2 BED	3	807 SF	75 m²	2420 SF	224.79 m ²
UNIT D2	2 BED	3	694 SF	64 m²	2081 SF	193.38 m²
UNIT D2.1	2 BED	1	690 SF	64 m²	690 SF	64.13 m²
UNIT D3	2 BED	1	980 SF	91 m²	980 SF	91.07 m²
UNIT D4	2 BED	1	903 SF	84 m²	903 SF	83.85 m ²
UNIT D4.1	2 BED	5	902 SF	84 m²	4512 SF	419.18 m ²
UNIT D5	2 BED	1	927 SF	86 m²	927 SF	86.10 m²
UNIT D6	2 BED	1	781 SF	73 m²	781 SF	72.58 m²
UNIT D7	2 BED	6	836 SF	78 m²	5016 SF	465.97 m ²
UNIT E1	2 BED & DEN	5	926 SF	86 m²	4631 SF	430.23 m²
UNIT E2	2 BED & DEN	2	933 SF	87 m²	1866 SF	173.35 m²
UNIT E2.1	2 BED & DEN	3	901 SF	84 m²	2704 SF	251.24 m²
UNIT E3.1	2 BED & DEN	3	874 SF	81 m²	2622 SF	243.58 m²
UNIT TOTALS	: 152				95608 SF	8882.29 m ²

0.5.0 parking requirements

VEHICLE PARKING STALLS REQUIRED (BYLAW REQUIREMENT)			
	UNITS / S.F.	FACTOR	TOTAL
TENANT (UNIT)	152	.9	137
VISITOR ACCESSIBLE LOADING	152 N/A	.1 .02 N/A	15 3 N/A
TOTAL STALLS			157 (3 ACCESSIBLE INCL.)
BIKE PARKING STALLS REQUIRED (BYLAW REQUIREMENT) TENANT (UNIT) VISITOR (BLDG) TOTAL STALLS	UNITS/BLDG/S.F. 152	FACTOR *1.2	TOTAL 183 6 189

NOTE: SITE IS LOCATED WITHIN CITY CENTRE, MINIMUM SPACES REQUIRED PER DWELLING UNIT = .9, MAXIMUM SPACES REQUIRED PER DWELLING UNIT = 1.1

0.5.1 vehicle parking stall summary

PARKING STALL USER/TYPE	PARKING STALL COUNT	PARKING STALL %	LEVEL	COMMENTS
RESIDENT				
ACCESSIBLE	1	0.6%	P2 LEVEL	
ACCESSIBLE	2	1.2%	P1 LEVEL	
STANDARD	94	58.4%	P2 LEVEL	
STANDARD	47	29.2%	P1 LEVEL	
RESIDENT: 144		89.4%		
VISITOR				
ACCESSIBLE	1	0.6%	P1 LEVEL	
STANDARD	16	9.9%	P1 LEVEL	
VISITOR: 17		10.6%		
TOTAL PARKING STALLS: 161		100.0%		

0.5.2 bike parking stall summary

ololl and partir		/		
PARKING STALL USER/TYPE	PARKING STALL COUNT	PARKING STALL %	LEVEL	COMMENTS
RESIDENT				
BIKE	186	100.0%	P1 LEVEL	
RESIDENT: 186		100.0%		
TOTAL PARKING STALLS: 186		100.0%		

0,6,0 amenity summary

· ·		
FACTOR	REQUIRED	PROPOSED
3.0 m ² /DU	456.0 m ²	362.88 m² (80% OF REQUIRED)
3.0 m ² /DU		460.89 m ² (101% OF REQUIRED)
	912.0 m ²	823.77 m ² (90% OF REQUIRED)
	3.0 m ² /DU 3.0 m ² /DU	3.0 m²/DU 456.0 m² 3.0 m²/DU 456.0 m²



aerial view looking s/w



95 avenue looking s/w



134 street looking s/e

INE PROPOSED DEVELOPMENT IS
LOCATED ON THE EDGE OF SURREY CITY
CENTER ON 134 STREET AND 95 AVENUE.
THE IMMEDIATE AREA SURROUNDING THE
SITE IS OCCUPIED BY SINGLE FAMILY
RESIDENTIAL LOTS. ONE BLOCK EAST OF
THE SITE IS SURREY MEMORIAL MOSPITAL,
LOCATED ON KING GEORGE BOULEVARD.

sync apartments residential development location

sync apartments residential development location



location map




134 street looking n/e



aerial view looking n/e





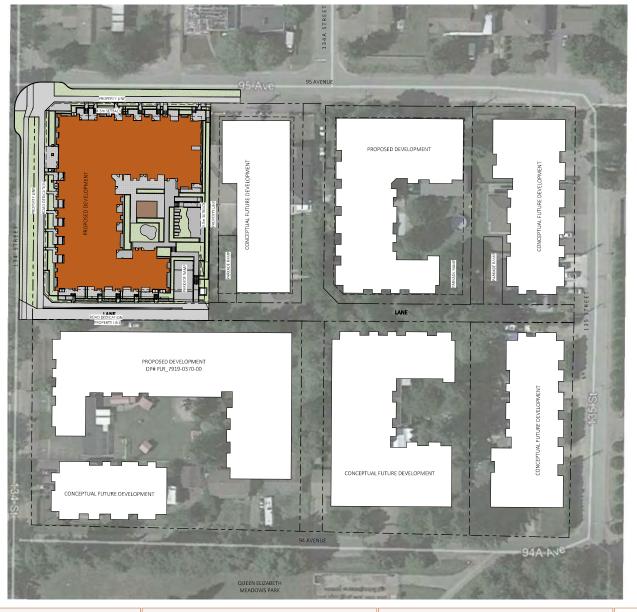









PROPOSED

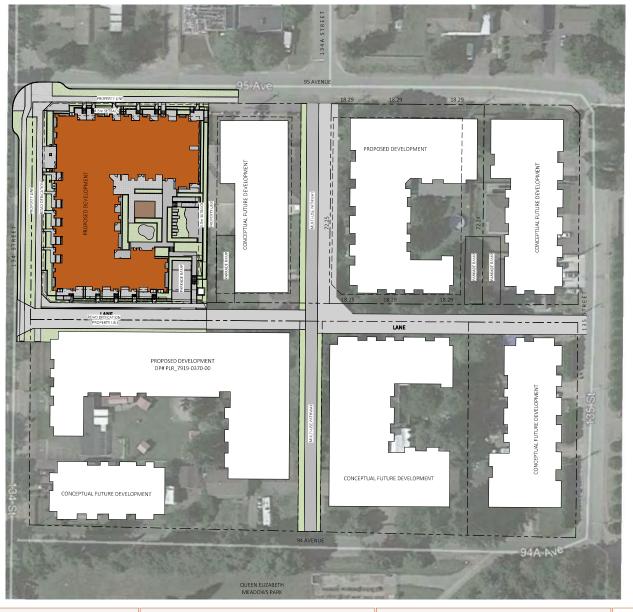

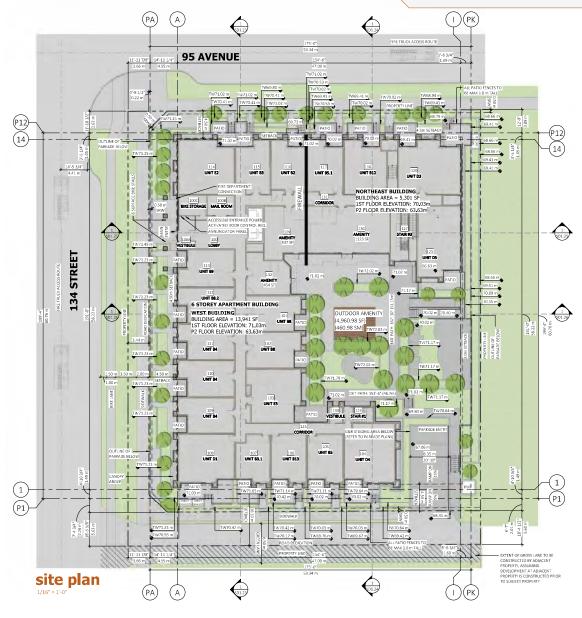








PROJECT NUMBER: 20-119

LEGAL ADDRESS: LOT 2 & LOT 3, SEC 32, TOWNSHIP 2, PLAN NWP14014 LOT 1, SEC 32, TOWNSHIP 2, PLAN NWS2481

CIVIC ADDRESS: 9470, 9482 & 9492 134, SURREY, BC P.I.D. # 002-416-042, 000-513-172, 005-437-504

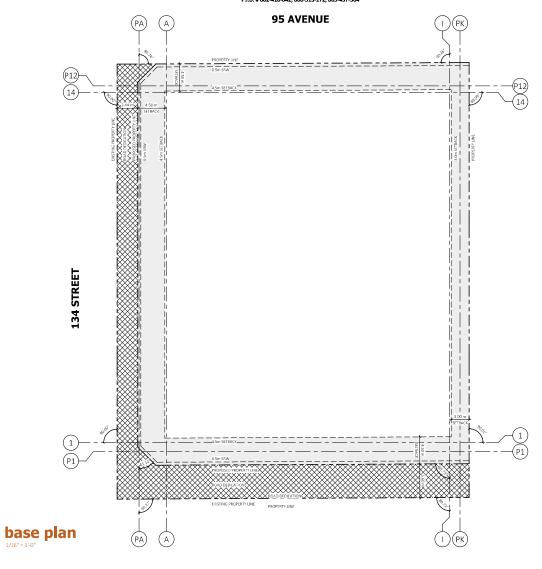









DETAILED BASE PLAN

SCALE: 1/16" = 1'-0"

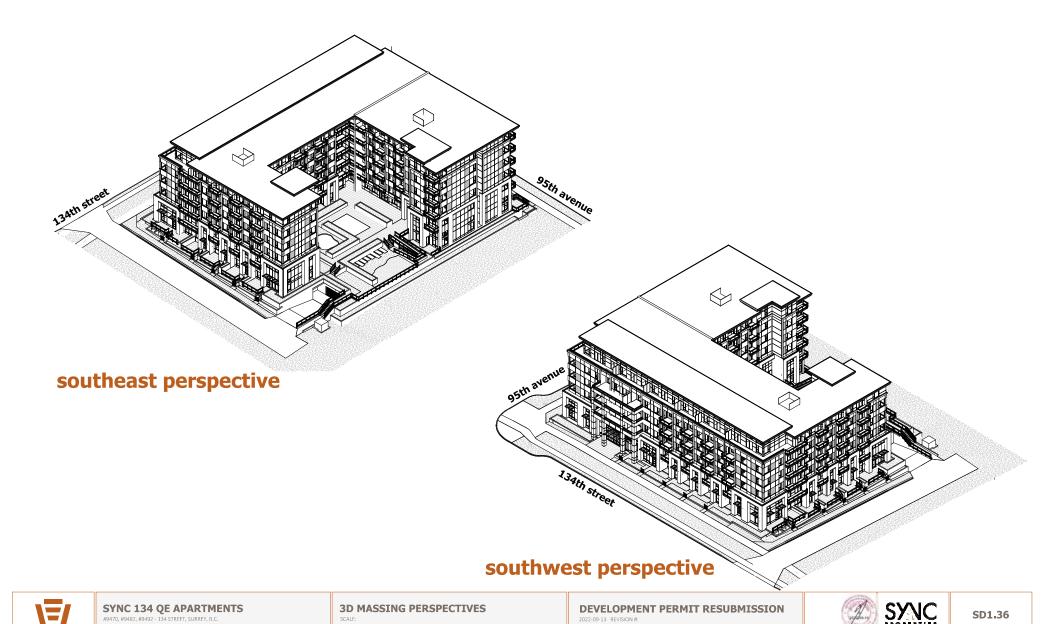

PROJECT NUMBER: 20-119

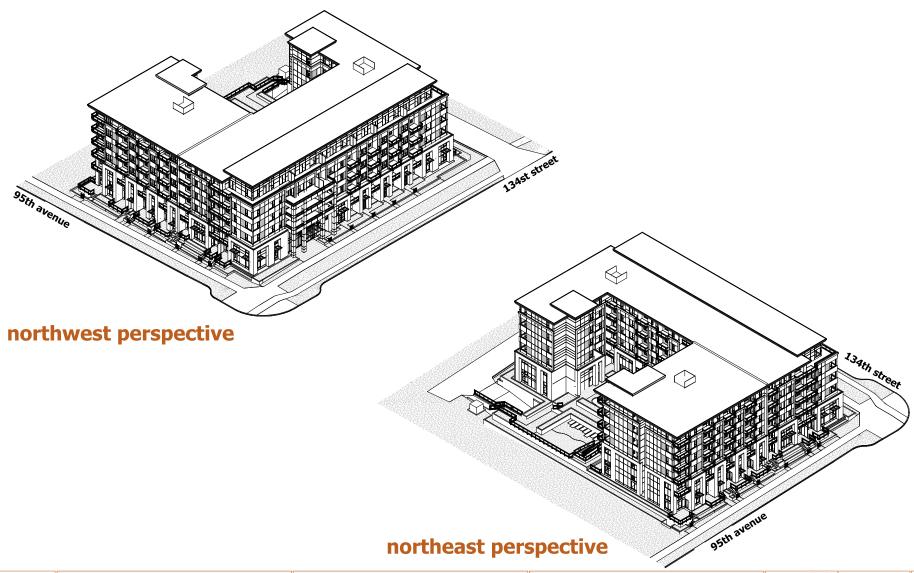



PROJECT NUMBER: 20-119



northwest corner looking down 134th



north elevation



west elevation



northeast corner





SYNC 134 QE APARTMENTS

















| 20| BALCONY SOFFIT:
- "WOODTONE", COLOUR: "TEXAS HONEY BROWN"
| 21| HARDIE FASCIA BOARD (SMOOTH):
- "JAMES HARDIE", COLOUR: "MIDNIGHT BLACK"

19 ROOF SOFFIT:
- PERFORATED VINYL
COLOUR: WHITE

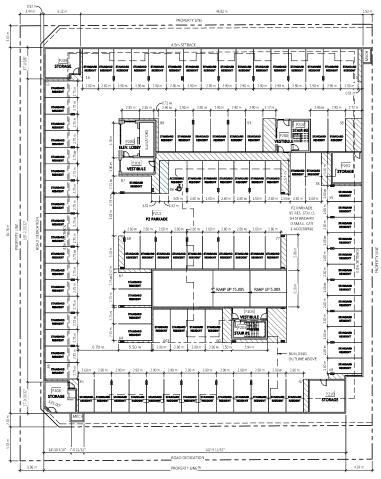

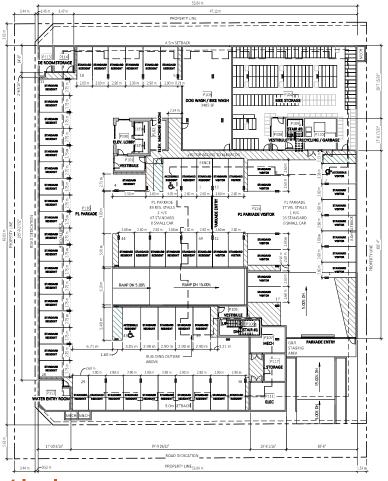

DEVELOPMENT PERMIT RESUBMISSION

p2 level

p1 level


2022-09-13 REVISION #: PROJECT NUMBER: 20-119









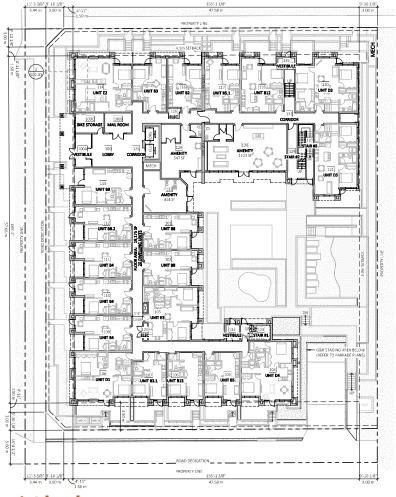



1st level















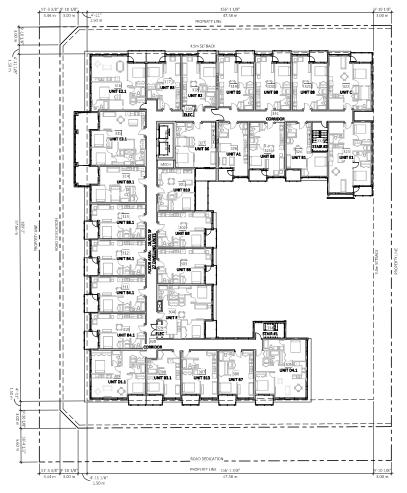

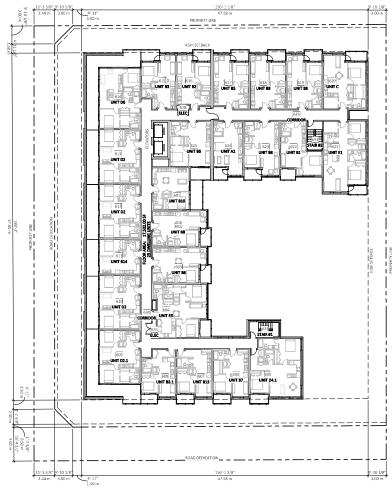

3rd - 5th level

6th level


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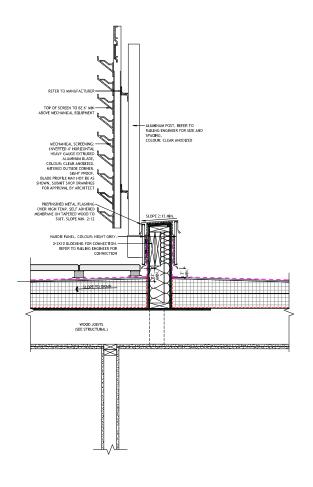










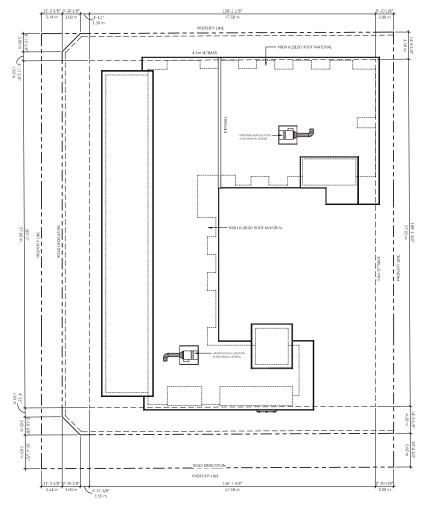

roof level

typical roof screen detail









CEMENT BOARD SMOOTH PANEL SIDING (W/EASY TRIM ALUM, REVEALS):
- 'JAMES HARDIE': COLOUR: 'PEARL GRAY'

CEMENT BOARD SMOOTH PANEL SIDING (W/EASY TRIM ALUM, REVEALS):
 - YAMES HARDIE: COLOUR: YIRON GRAY*
 CEMENT BOARD SMOOTH PANEL SIDING (W/EASY TRIM ALUM, REVEALS):
 - YAMES HARDIE: COLOUR: NIGHT GRAY!

4 CEMENT BOARD CEDARMILL HORIZONTAL LAP SIDING (6° EXPOSURE):
- "JAMES HARDIE", COLOUR: "NIGHT GRAY"

PREFINITION JALLAMINUS APUEL:
 OUDE PAREI, COLOUR "ANODE CLEAR"

 HORDONAL SUBING 15" GROOD CLEAR"

 HORDONAL SUBING 15" GROOD CLEAR (INC.)
 AUGIETI, COLOUR: PRIE ZERMADOD

 CONCRET ESCHOOM (INC.)
 TRESTAT, COLOUR: DAKE GRACOAL GRAY, TETURE: SMOOTH MORTAN COLOUR LIBERT SUM.

8 WINDOW VINYL:
- COLOUR: 'BLACK EXT. / WHITE INT.'

SLIDING PATIO DOOR VINYU:
 - COLOUR: 'BLACK EXT. / WHITE INT.'

 ALUMINUM/GLASS DECK RAILING:
 - COLOUR: 'BLACK ANDDIZED'

11 HARDIE FASCIA BOARD (SMOOTH):
- 'JAMES HARDIE', COLOUR: 'IRON GRAY'

15 CONCRETE WALL:
- COLOUR: 'CLEAR SEALER'

19 ROOF SOFFIT:
- PERFORATED VINYL
COLOUR: WHITE

[18] CURTAIN WALL:
- 'KAWNEER', 1600 UT SYSTEM 1
COLOUR: 'BLACK ANODIZED', C/W GRAY SPANDREL PANEL

BALCONY SOFFIT:

"WOODTONE", COLOUR: "TEXAS HONEY BROWN"

HARDIE FASCIA BOARD (SMOOTH):

"JAMES HARDIE", COLOUR: "MIDNIGHT BLACK"

STEEL/GLASS COMMERCIAL ENTRANCE CANOPY
 COLOUR STEEL; PAINTED TO MATCH AMMES HARDIE 'IRON GRAY'
 EXTERIOR ALUMINIUM GUARD/RAILING:
 COLOUR: 'BLACK'

material legend



west elevation

3/32" = 1'-0"



north elevation

3/32" = 1'-0"





CEMENT BOARD SMOOTH PANEL SIDING (W/EASY TRIM ALUM. REVEALS):
 "JAMES HARDIE": COLOUR: "PEARL GRAY"

CEMENT BOARD SMOOTH PANEL SIDING (W/EASY TRIM ALUM, REVEALS):
 - JAMES -HARDER; COLOUB- 'HON SHAP'
 CEMENT BOARD SMOOTH PANEL SIDING (W/EASY TRIM ALUM, REVEALS):
 - JAMES -HARDER; COLOUB- 'HIGHT GRAP'

4 CEMENT BOARD CEDARMILL HORIZONTAL LAP SIDING (6" EXPOSURE):
- 'JAMES HARDIE', COLOUR: 'NIGHT GRAY'

S PREFINISHED ALUMINUM PANEL:
- 'QUICK PANEL', COLOUR: 'ANODIC CLEAR

WINDOW VINYL:
 COLOUR: "BLACK EXT. / WHITE INT.

IO ALUMINUM/GLASS DECK RAILING: - COLOUR: 'BLACK ANDDIZED'

12 METAL FLASHING: - 'GENTER', COLOUR: 'SLATE 523'

15 CONCRETE WALL: - COLOUR: 'CLEAR SEALER'

ROOF SOFFIT:
- PERFORATED VINYL
COLOUR: WHITE

11 HARDIE FASCIA BOARD (SMOOTH):
- 'JAMES HARDIE', COLOUR: 'IRON GRAY

14 EXTERIOR ALUMINUM GUARD/RAILING: - COLOUR: "BLACK"

| T6 | REVEAU:
- "EASYTHIM", COLOUR: "CLEAR ANODIZED"
| T7 | STERIOR METAL DOOR:
- "BENLAMIN WOORE; COLOUR: "WITCHING HOUR! 2120-30
COLOUR: BLACK @ COMMERCIAL (SEE BLEVATIONS)

18 CURTAIN WALL:
- 'KAWNEER', 1600 UT SYSTEM 1
COLOUR: 'BLACK ANODIZED', C/W GRAY SPANDREL PANEL

20 BALCONY SOFFIT:
-'WOODTONE', COLOUR: 'TEXAS HONEY BROWN'

21 HARDIE FASCIA BOARD (SMOOTH):
-'JAMES HARDIE', COLOUR: 'MIDNIGHT BLACK'

13 STEEL/GLASS COMMERCIAL ENTRANCE CANOPY
-COLOUR (STEEL): PAINTED TO MATCH JAMES HARDIE ' IRON GRAY

HORIZONTAL SIDING (6" V. GROOVE, (V)ODDGRAIN):
 SAGPER', COLGUR: PINE ZEBRAVIOO?
 COUCRETE BRICK(90mm\$46-mmx1,90mm):
 - 1953-88, COLGUR: PINE CAHACOAL, GRAY, TEXTURE: 'SMOOTH-MORTAR COLGUR: LIGHT GRAY.

material legend



east elevation



south elevation
3/32" = 1'.0"



SYNC 134 QE APARTMENTS #9470, #9482, #9492 - 134 STREET, SURREY, B.C.

BUILDING ELEVATIONS
SCALE: As indicated

DEVELOPMENT PERMIT RESUBMISSION

2022-09-13 REVISION #: PROJECT NUMBER: 20-119



CEMENT BOARD SMOOTH PANEL SIDING (W/EASY TRIM ALUM, REVEALS):
- 'JAMES HARDIE'; COLDUR: 'PEARL GRAY'

3 CEMENT BOARD SMOOTH PANEL SIDING (W/EASY TRIM ALUM, REVEALS):
- 'JAMES HARDIE': COLDUR: 'NIGHT GRAY' CEMENT BOARD CEDARMILL HORIZONTAL LAP SIDING (6" EXPOSURE):
- 'JAMES HARDIE'. COLOUR: 'NIGHT GRAY'

- 'JAMES HARDIE'. COLOUR: 'NIGHT GRAY'.

- 'JAMES HARDIE'. COLOUR: 'NIGHT GRAY'.

- 'JAMES HARDIE'. COLOUR: 'NIGHT GRAY'.

CONCRETE BRICK(90mmX64mmX190mm):
 'TRISTAR', COLOUR: 'DARK CHARCOAL GRAY', TEXTURE: 'SMOOTH'
 MORTAR COLOUR: LIGHT GRAY

3 STEEL/GLASS COMMERCIAL ENTRANCE CANOPY
-COLOUR (STEEL): PAINTED TO MATCH JAMES HARDIE ' IRON GRAY

material legend

5 PREFINISHED ALUMINUM PANEL:
- 'QUICK PANEL', COLOUR: 'ANODIC CLEAR'

8 WINDOW VINYL: - COLDUR: 'BLACK EXT. / WHITE INT. SLIDING PATIO DOOR VINYL:
- COLOUR: 'BLACK EXT. / WHITE INT. 10 ALUMINUM/GLASS DECK RAILING: - COLOUR: 'BLACK ANODIZED'

11 HARDIE FASCIA BOARD (SMOOTH):
- 'JAMES HARDIE', COLOUR: 'IRON GRAY'

14 EXTERIOR ALUMINUM GUARD/RAILING: - COLOUR: 'BLACK' 15 CONCRETE WALL: - COLOUR: 'CLEAR SEALER'

16 REVEAL:
- 'EASYTRIM', COLOUR: 'CLEAR ANODIZED' EXTERIOR METAL DOOR:
 - 'BENIAMIN MOORE', COLOUR: 'WITCHING HOUR' 2120-30 COLOUR: 'BLACK' & COMMERCIAL (SEE ELEVATIONS) [18] CURTAIN WALL:
- 'KAWNEER', 1600 UT SYSTEM 1
COLOUR: 'BLACK ANODIZED', C/W GRAY SPANDREL PANEL

20 BALCONY SOFFIT:
-'WOODTONE', COLOUR: 'TEXAS HONEY BROWN'

21 HARDIE FASCIA BOARD (SMOOTH):
-'JAMES HARDIE', COLOUR: 'MIDNIGHT BLACK'

19 ROOF SOFFIT:
- PERFORATED VINYL
COLOUR: WHITE

12 METAL FLASHING: - 'GENTEK', COLOUR: 'SLATE 523'



interior north elevation



interior south elevation

#9470, #9482, #9492 - 134 STREET, SURREY, B.C.


BUILDING ELEVATIONS SCALE: As indicated

DEVELOPMENT PERMIT RESUBMISSION

2022-09-13 REVISION #: PROJECT NUMBER: 20-119





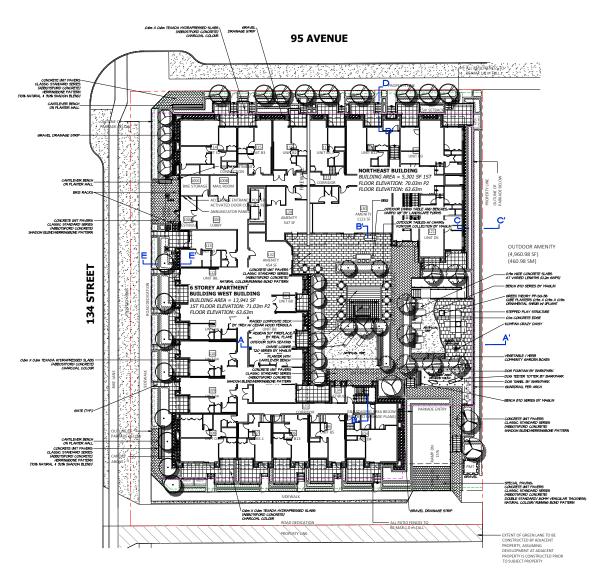

DRAWING INDEX: L1 LANDSCAPE PLAN L2 SHRUB PLAN L3 SOIL VOLUME PLAN L4 LANDSCAPE SECTIONS L5 LANDSCAPE DETAILS (1) L6 LANDSCAPE DETAILS (2) L7 LANDSCAPE DETAILS (3)

L8 TREE RETENTION PLAN

L9 LANDSCAPE SPECIFICATIONS



LANDSCAPE ARCHITECTURE

#220 - 26 Lorne Mews New Westminster, British Columbia

Tel: 604.553.0044 Fax: 604.553.0045 Email: office@m2la.com





п	SEPT J2.2022	D.P. RESUBMISSION	PHT
ю	SEPT.02.2022	D.P. RESUBMISSION	PMT
4	AUG.22.2022	D.P. RESUBMISSION	PHT
8	JAN 28-2022	REVISED PER ADP COMMENTS	PHT
7	HARJ0.22	REVISED PER NEW ARCH SITE PLAN	PHT
6	FEB.02.2022	D.P. RESUBMISSION	PHT
5	OCT18.2021	REV. AS PER PARKS COMMENTS	PHT
4	MAY.12.2021	REV. AS PER DRS COMMENTS	68
3	OCT.26.2020	DEVELOPMENT PERMIT	×
2	OCT.NL2020	PRELIMINARY DESIGN	×
1	OCT.4.2020	PRELIMINARY DESIGN	PHT
10.	DATE	REVISION DESCRIPTION	DR.

PROJECT:


SYNC 134 QE **APARTMENTS**

#9470, #9482, #9492 134 STREET SURREY, B.C.

LANDSCAPE PLAN

ATE:	JJLY 21.20	DRAWING NUMBE
CALE:	V16" = 1'-0"	
RAWN:	PMT 4 JC	l <i>I</i> 1
ESIGN:	PMT 4 JC	
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20-032

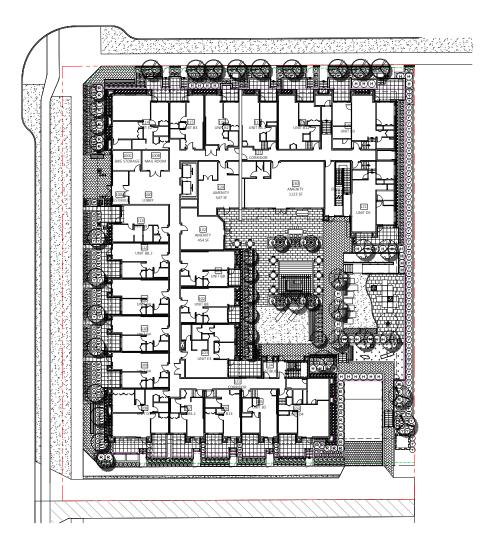

ALK	NT	SCHEDULE		M2 JOB NUMBER 20-032
KEY		BOTANICAL NAME	COMMON NAME	PLANTED BIZE / REMARKS
REE	_	ACER PALMATUM 'BLOODGOOD'	JAPANESE HAPLE	ACM CAL LOSTO, B4B
m	. 9			
C		CERCIS CANADENSIS	EASTERN REDBUD	6CM CAL; LØ STD; BIB
7.	10	CORNUS EDDIE'S WHITE WONDER'	HHITE HONDER DOSHOOD	6CM CAL; STD FORM; B&B
			DHARF JAPANESE MAPLE	5CM CAL; L5M HT; B4B
20	7	FRAXINUS OMUS	FLOWERING ASH	6CM CAL; LØM STD; BMB
W	2	MAGNOLIA x 'LEOBNERI MERRILL'	HAGNOLIA	6CM CAL; LOM STD; SINGLE STEM; B48
,-	ô	SYRINGA RETICULATA	NORY SILK TREE	6CM GAL; LBM STD; B4B
HRUB				
∞	45	ABELIA X GRANDIFLORA KALEIDOSCOPE'	KALEIDOSCOPE ABELIA	#3 POT; 50CM
(H)	44	HYDRANGEA PANICILATA BOMBSHELL'	HHITE LACECAP HYDRANGEA	#8 POT; BOCH
⊕	36	PIERIS JAPONICA MOUNTAIN FIRE!	JAPANESE ANDROMEDA	42 POT; SOCM
(P)	54	PRUNUS LUSITANICA	PORTUGESE LAUREL	45 POT; 50CM
€9	67	RHODODENDRON 'CREST'	RHODODENDRON, YELLOH MAY	*2 POT
(R)	24	ROSA RUSOSA	SHRUB ROSE	*2 POT
◒	113	SARCOCOCCA HOOKERANA VAR. HUMILIS	HMALAYAN SMEET BOX	#2 POT
ക്	67	SPIRAEA SHIROBANA "LITTLE PRINCESS"	LITTLE PRINCESS SPIREA	#2 POT
্ব	42	TAXUS BACCATA	ENGLISH YEW	#3 POT AOCH
00 0000000 0000	2	VIBURNUM X BODNANTENSE	PINK DAWN VIBURNUM	LOM HT, UPRIGHT TREE FORM
RĂ55				
0	7	GALAMAGROSTIS ACUTIFLORA KARL FOERSTER!		#2 POT
Ø.	85	HAKONECHOLA MACRA 'ALL GOLD'	JAPANESE FOREST 6RASS	#I POT
₩	41	PENNISETUM ALOPECUROIDES HAMELIN'	DWARF FOUNTAIN GRASS	●2 P0T
ଭ	35	STIPA TENJISSIMA	MEXICAN FEATHER GRASS	#I POT
SOCOO	IIAL			
(A)	14	LAVANDILA ANGUSTIFOLIA	ENGLISH LAVENDER	#I POT
ര	30	NEPETA X VERANICA 'DROPHORE'	CATHINT	BICH POT
8	5	OPHOPOSON JAPONICUS	HONDO GRASS	5CM POT
ROW	XOVER			
RA	13	EJOHYMUS JAPONICA TEMERALD 'N GOLD'	BIONYMUS: GOLD VARIEGATED	#2 POT: 400H
300G	34	LONICERA PILEATA	BOX LEAF HONEYSUGLE	4 POT:
ര്	233	PACHYSANDRA TERMINALIS GREEN SHEEN	JAPANESE SPURSE	4 POT
×	28	HESTERN SHORD FERN	POLYSTICHIM MINITUM	#I POT 200M

ALL PLANT MATERIAL MUST BE PROVIDED FROM CERTIFIED DISEASE FREE NURSERY. PROVIDE CERTIFICATION UPON REQUEST.

NOTE: DWARF AGER PALMATUM NOT COUNTED AS REPLACEMENT TREES



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ю	SEPT.02.2022	D.P. RESUBMISSION	
9	AUG.22.2022	D.P. RESUBMISSION	-
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3	OCT.26.2020	DEVELOPMENT PERMIT	Г
2	OCT/R2020	PRELIMINARY DESIGN	Г
1	OCT.9.2020	PRELIMINARY DESIGN	
NO.	DATE	REVISION DESCRIPTION	0

PROJECT:

SYNC 134 OE **APARTMENTS**

#9470, #9482, #9492 134 STREET SURREY, B.C.


DRAWING TITLE:

SHRUB PLAN

DATE: JALY 21.20 DRAWING NUMBER: SCALE: 1/16" = 1'-0" DRAWN: PMT 4 JC DESIGN: PMT 4 JC

CHK'D: MTLM

20-032

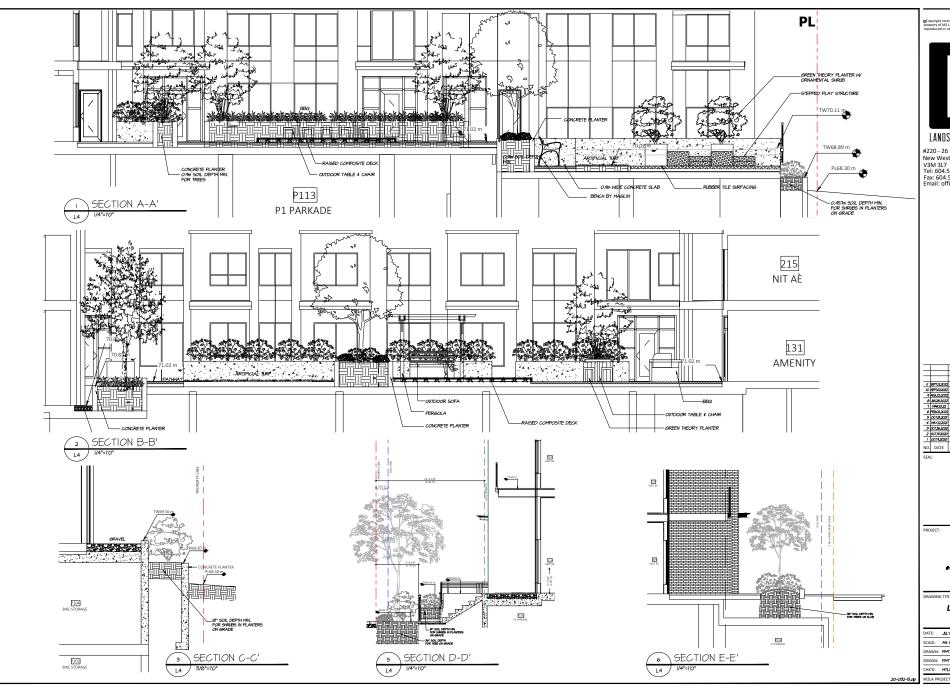

LANDSCAPE ARCHITECTURE

#220 - 26 Lorne Mews New Westminster, British Columbia

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3	OCT.26.2020	DEVELOPMENT PERMIT	x
2	OCT/N.2020	PRELIMINARY DESIGN	x
1	OCT.4.2020	PRELIMINARY DESIGN	PMT
10.	DATE	REVISION DESCRIPTION	DR.

SYNC 134 QE **APARTMENTS**


#9470, #9482, #9492 134 STREET SURREY, B.C.

LANDSCAPE SECTIONS


DATE:	JJLY 21.20	DRAWING NUMBER
SCALE:	AS SHOWN	
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DESIGN:	PMT 4 JC	
CHK'D:	MTLM	

M2LA PROJECT NUMBER:


20-032

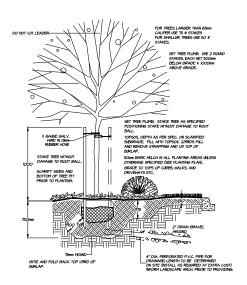


TREE PLANTING DETAIL ON GRADE; TYP.

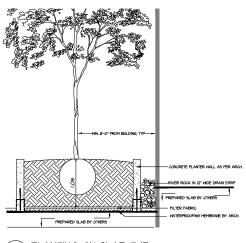

PLANTING ON SLAB TYP.

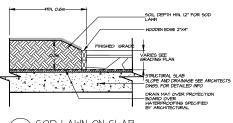


SOD LAWN ON SLAB

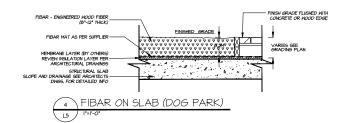


TOP OF PAVERS TO MIN I BEDDING SAND DRAINAGE LAYER-MIRADRI GUICKDRAIN OR APPROVED EQUAL

NOTE: PAVERS TO BE INSTALLED TO MANUFACTURERS SPECIFICATIONS


PAVERS ON SLAB TYP.

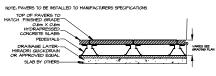

HYDRAPRESSED PAVERS ON SLAB L5

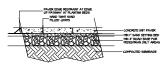

PAVERS ON GRADE TYP. L5

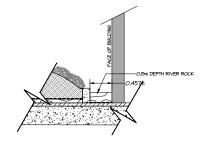

DRIP STRIP ON SLAB



LANDSCAPE ARCHITECTURE

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п	SEPTJ2,2022	D.P. RESUBMISSION	PHO
ю	SEPT.02.2022	D.P. RESUBMISSION	PMI
9	AUG.22.2022	D.P. RESUBMISSION	PMI
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3	OCT.26.2020	DEVELOPMENT PERMIT	x
-2	OCT/R2020	PRELIMINARY DESIGN	×
$\overline{}$	OCT.4.2020	PRELIMINARY DESIGN	PMI
NO.	DATE	REVISION DESCRIPTION	DR.

PROJECT:

SYNC 134 QE **APARTMENTS**


#9470, #9482, #9492 134 STREET SURREY, B.C.


LANDSCAPE DETAILS (1)

DATE:	JJLY21.20	DRAWING NUMBER:
SCALE:	AS SHOWN	
DRAWN:	PMT 4 JC	15
DESIGN:	PMT 4 JC	7 - V
CHK'D:	MTLM	


M2LA PROJECT NUMBER:


20-032

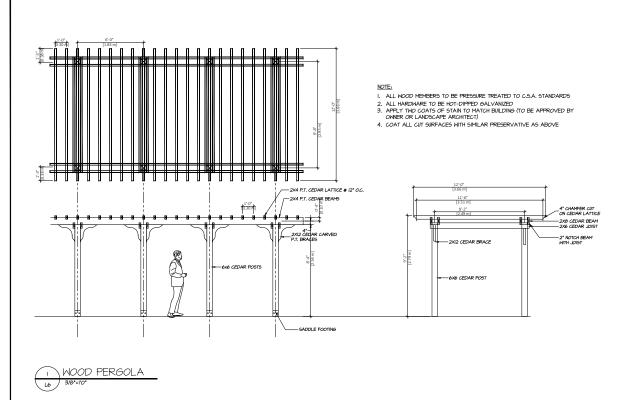

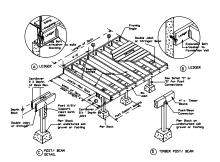


RAISED WOOD DECK

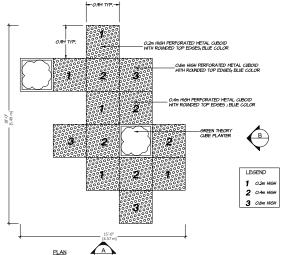

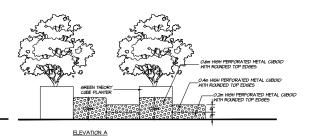

CONCRETE PLANTER AS PER ARCH. I" SQUARE METAL 2" SQUARE METAL GATE WITH HINGE

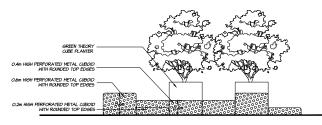

ELEVATION B

STEPPED PLAY STRUCTURE



LANDSCAPE ARCHITECTURE

#220 - 26 Lorne Mews New Westminster, British Columbia V3M 3L7

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PROJECT:

SYNC 134 QE **APARTMENTS**

#9470, #9482, #9492 134 STREET SURREY, B.C.

DRAWING TITLE:

LANDSCAPE DETAILS (2)

ATE:	JJLY 21.20	DRAWING NUMBER:
ALE:	AS SHOWN	
AWN:	PMT 4 JC	16
SIGN:	PMT 4 JC	
IK'D:	мпрм	OF
2LA PR	DJECT NUMBER:	20-0

METAL GATE



120 SERIES BACKLESS CANTILEVER BENCH BY MAGLIN HTTPS://WWW.MAGLIN.COM/PRODUCTS/BENCH/MLBT20BCLSERIES.HTML?FILE=I







CANTILEVER BENCH



ICONIC COLLECTION BY MAGLIN HTTPS://WWW.MAGLIN.COM/PRODUCTS/ICONIC/MBR-2300-00001.HTML

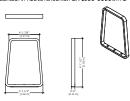


BIKE RACK ICONIC COLLECTION BY MAGLIN

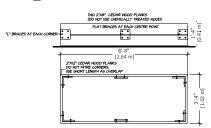

VEGETABLE GARDEN BOX



HARPO TABLE AND BENCHES HTTPS://WWW.REALFLAME.COM/PRODUCTS/

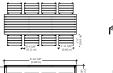

OUTDOOR TABLE AND BENCHES



KONTOUR COLLECTION BY MAGLIN HTTPS://WWW.MAGLIN.COM/PRODUCTS/KONTUR/INDEX.HTML

PBark-405

DOG FOUNTAIN PRARCK-405 BY BARK PARK

DOG FOUNTAIN


PBARK-405 BY BARK PARK

HTTPS://WWW.DOGPARKPRODUCT.COM/AMENITIES/ACCESSIBLE-FIDO-ME-FOUNTAIN/





870 SERIES BENCH BY MAGLIN HTTPS://WWW.MAGLIN.COM/PRODUCTS/BENCH/MLB&TOSERIES.HTML

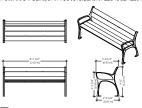




GREEN THEORY CIVILIAN SQUARE PLANTER (0.9m x 0.9m x 0.9m)

DOG TUNNEL PBARCK-441-RED BY BARK PARK HTTPS://WWW.DOGPARKPRODUCT.COM/ACTIVITIES/RECYCLED-CRAWL-TUNNEL

DOG TEETER-TOTTER PBARCK-440-P BY BARK PARK

DOG FEATURES


HTTPS://WWW.DOGPARKPRODUCT.COM/ACTIVITIES/TEETER_TOTTER.HTML

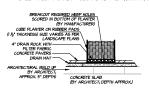





T20 CHAISE LOUNGE SERIES BY MAGLIN
HTTPS://MWAMAGLIN.COM/PRODUCTS/BENCH/MCLT20SERIES.HTML

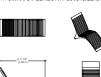






PLAY STRUCTURE CRAZY DAISY BY KOMPAN



SOFA, CLUB CHAIR AND COFFEE TABLE SET AIBBI4 BLACK BY VANCOUVER SOFA COMPANY

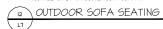



AEGEAN 50" OUTDOOR FIREPLACE





OUTDOOR FIREPLACE AEGEAN 50" BY REAL FLAME

PROJECT:

SYNC 134 QE **APARTMENTS**

LANDSCAPE ARCHITECTURE #220 - 26 Lorne Mews New Westminster, British Columbia

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#9470, #9482, #9492 134 STREET SURREY, B.C.

LANDSCAPE DETAILS (3)

DATE: JULY 21.20 DRAWING NUMBER: SCALE: AS SHOWN DRAWN: PMT 4 JC DESIGN: PMT 4 JC CHK'D: MTLM

M2LA PROJECT NUMBER:

20-032



INTER-OFFICE MEMO

TO: Manager, Area Planning & Development

- North Surrey Division

Planning and Development Department

FROM: Development Services Manager, Engineering Department

DATE: September 01, 2022 PROJECT FILE: 7820-0286-00

RE: Engineering Requirements

Location: 9470-134 Street, 9482-134 Street & 9492 134 Street (13428-95 Avenue)

REZONE/SUBDIVISION

Property and Right-of-Way Requirements

- Dedicate 3.442m along 134 Street.
- Dedicate minimum 5.6m for Green Lane for a total ultimate 12.0m width.
- Dedicate required corner cuts.
- Provide o.5m wide statutory right-of-way along 134 Street, 95 Avenue and the Lane.

Works and Services

- Construct east side of 134 Street, south side of 95 Avenue, and Green Lane.
- Implement recommendations of geo-technical report.
- Construct storm main along the Green Lane.
- Construct minimum 250mm sanitary main along 134 Street, and 95 Avenue.
- Complete drainage catchment analysis to determine existing capacities. Resolve downstream constraints, as identified.
- Construct 300mm water main along 134 Street and 250mm water main along 95 Avenue. Submit fire flow analysis and determine the extent of upsizing works required.
- Provide water, storm and sanitary service connections to support the development.
- Register applicable legal documents as determined through detailed design.
- Secure off-site working easements and tree cutting permits, if applicable.
- Pay amenity charge for undergrounding the existing overhead electrical and telecommunication infrastructure.
- Pay water latecomer charges, as applicable.

A Servicing Agreement is required prior to Rezone/Subdivision.

DEVELOPMENT PERMIT

There are no engineering requirements relative to issuance of the Development Permit.

Jeff Pang, P.Eng.

Jeffy lang

Development Services Manager

HB₄



September 6, 2022

Planning

THE IMPACT ON SCHOOLS

APPLICATION #: 20 0286 00 (updated September 2022)

SUMMARY

The proposed 152 lowrise units are estimated to have the following impact on the following schools:

Projected enrolment at Surrey School District for this development:

Elementary Students:	17	
Secondary Students:	17	

September 2021 Enrolment/School Capacity

Cindrich Elementary	
Enrolment (K/1-7):	44 K + 370
Operating Capacity (K/1-7)	38 K + 443
Ougan Elizabath Casandan	
Queen Elizabeth Secondary	4.474
Enrolment (8-12): Capacity (8-12):	1474 1600

Projected population of school-age children for this development:	48
---	----

Population: The projected population of children aged 0-19 Impacted by the development. **Enrolment**: The number of students projected to attend the Surrey School District ONLY.

Appendix III


School Enrolment Projections and Planning Update:

The following tables illustrate the enrolment projections (with current/approved ministry capacity) for the elementary and secondary schools serving the proposed development.


Cindrich Elementary serves established neighbourhoods. The 10-year projection shows that the school continues to maintain existing enrolment levels. This projection is conservative and will likely change as higher density projects are approved and constructed at the intersection of 96th Ave and King George. There are no current plans to expand this existing school; and based on this projection, any future growth can be accommodated with 4 portables or less.

Queen Elizabeth Secondary operates below existing school capacity. Over the next 10 years, the enrolment growth trend will take on a stronger upwards trend line post 2023. Like the elementary school, the proposed new higher density development anticipated around King George Boulevard and 96th Avenue will also fuel secondary growth in the catchment. There are no current plans to expand the existing secondary school, but enrolment will be monitored over the next several years.

Cindrich Elementary

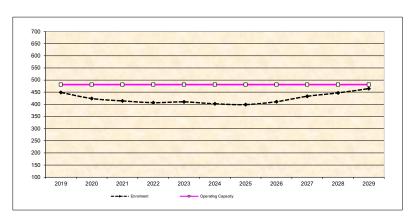

Queen Elizabeth Secondary

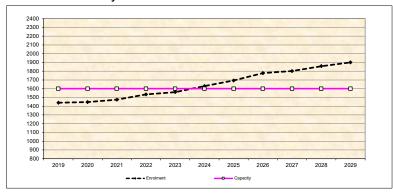

^{*} Nominal Capacity is estimated by multiplying the number of enrolling spaces by 25 students.

Maximum operating capacity is estimated by multipying the number of enrolling spaces by 27 students.

Tree Preservation Summary

Surrey Project No: 20-0286


Address: 9470/9482/9492 134 Street & 13428 95 Avenue, Surrey, BC

Registered Arborist: Xudong Bao PN 8671A TRAQ

On-Site Trees	Number of Trees
Protected Trees Identified	19
(on-site and shared trees, including trees within boulevards and proposed streets	
and lanes, but excluding trees in proposed open space or riparian areas)	
Protected Trees to be Removed	19
Protected Trees to be Retained	
(excluding trees within proposed open space or riparian areas)	0
Total Replacement Trees Required: - Alder & Cottonwood Trees Requiring 1 to 1 Replacement Ratio X one (1) = 0 - All other Trees Requiring 2 to 1 Replacement Ratio X two (2) = 38	38
Replacement Trees Proposed	38
Replacement Trees in Deficit	0
Protected Trees to be Retained in Proposed [Open Space / Riparian Areas]	

Off-Site Trees	Number of Trees	
Protected Off-Site Trees to be Removed	0	
Total Replacement Trees Required:		
- Alder & Cottonwood Trees Requiring 1 to 1 Replacement Ratio X one (1) = 0 - All other Trees Requiring 2 to 1 Replacement Ratio X two (2) = 0	0	
Replacement Trees Proposed	N/A	
Replacement Trees in Deficit	N/A	

Summary, report and plan prepared and submitted by:				
趋力。	September 13, 2022			
(Signature of Arborist)	Date			

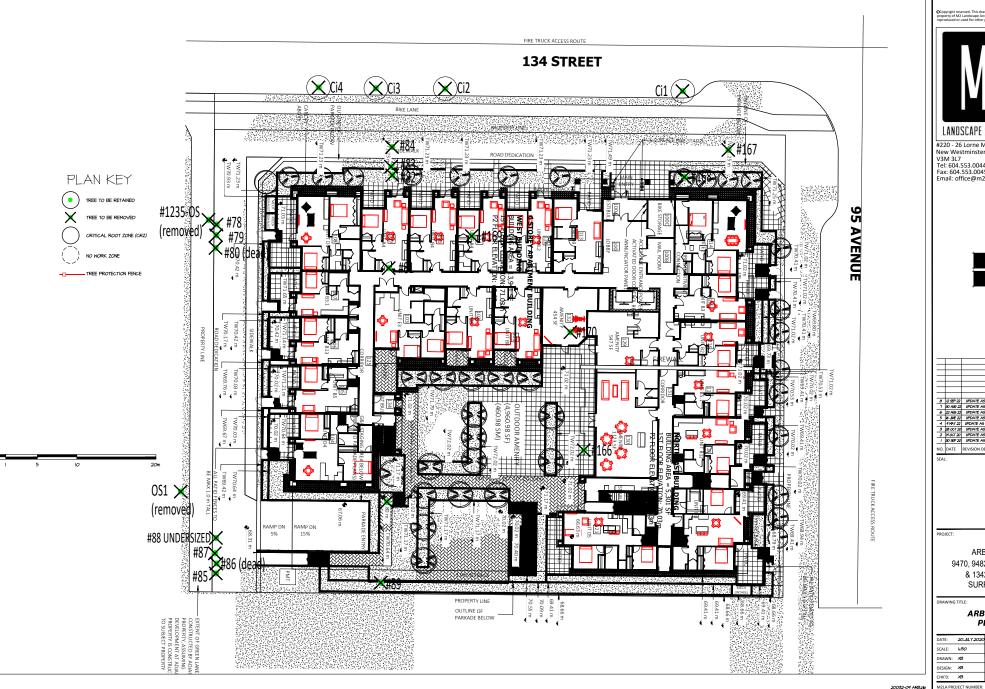



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			_
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_			
8	12 SEP 22	UPDATE AS PER NEW SITE PLAN	X
7	30 AUG 22	UPDATE AS PER NEW SITE PLAN	- 2
6	22 AUG 22	UPDATE AS PER NEW SITE PLAN	- >
5	16 JNE 22	UPDATE AS PER NEW SITE PLAN	_
4	4 HAY 22	UPDATE AS PER CITY COMMENTS	- >
3	28 OCT 20	UPDATE AS PER NEW SITE PLAN	- 2
2	M OCT 20	UPDATE AS PER NEW SITE PLAN	- >
7	30 SEP 20	UPDATE AS PER NEW SITE PLAN	^
NO.	DATE	REVISION DESCRIPTION	DR

ARBORIST

9470, 9482, 9492 134 ST & 13428 95 AVE SURREY, BC

DRAWING TITLE:

ARBORIST PLAN

ATE:	20.JJLY.2020	DRAWING NUMBER:
CALE:	1-150	
RAWN:	XВ	L2arb
ESIGN:	₽X	
HK,D-	χB	OF 4

20-032



August 29, 2022 File: 20-0286

Sarah Robertson Planner City of Surrey 13450 104 Ave, Surrey, BC, V2T 1V8

Dear Sarah,

RE: ADP Agenda for April 21, 2022 for 20-0286 (9470/9482/9492 - 134 St & 13428 - 95 Ave)

Thank you for your comments! Please find our itemized responses (in gray) to the April 21, 2022 ADP Review comments.

Key Points

• Suggest creating a better and stronger green buffer between the outdoor amenity area and Units 102 and 103 for more privacy.

We have revised the planting arrangement at Units 102 and 104 to provide a stronger green buffer to provide more privacy.

References: SD1.20 / SD3.02 / L1 / L2 / L3 / L8

 Recommend flipping the living room in Unit 103 (D4) with the north bedroom to provide more daylight.

We have reviewed this comment and we would prefer to leave the unit orientation as proposed. The current layout provides a larger patio at the main floor. In addition to this, if Unit 103 is flipped, L2-L6 patios will be shared with the adjacent unit which is preferred to be avoided unless absolutely necessary. There are only (4) units per floor that currently share patios and it is preferred to limit that condition wherever possible.

• Consider enlarging ground floor units to allow for front entry doors to enliven the building perimeter.

We have revised the exterior wall to increase the front entrance to the ground floor units.

References: SD1.20 / SD3.02 / SD3.0.3



 Consider exploring ways to further break down the massing, such as stepping back the upper level, particularly on the 134 Street side elevation facing the long-term singlefamily area.

We have revised the exterior design and the 6^{th} Floor will now step back +/-2.25m to scale the building to the West. This massing matches the project to the South with their top floor setback. This approach allows the outdoor amenity area to remain as currently proposed without any reduction needed. We're already providing a 0.7m step back at the 3^{rd} floor and now the 6^{th} floor steps back.

References: SD0.01 thru SD1.03 / SD1.09 / SD1.11 / SD1.24 / SD1.25 / SD1.35 / SD1.36 / SD1.37 / SD1.38 / SD3.02 / SD4.01 thru SD4.04 SD1.20 / SD3.02 / L1 / L2 / L3 / L8

 Encourage consolidating the bicycle rooms and facilities into one location, ideally on the P1 level.

We have combined the bicycle rooms and facilities to the P1 level.

References: SD3.01

 Recommend increasing planter size around the outdoor amenity area to provide more soil volume for healthy trees.

We have increased the planter size around the outdoor amenity area to provide more soil volume as requested.

References: SD1.20 / SD3.02 / L1 / L2 / L3 / L8

 Suggest planting small trees along the 134 Street site edge to help humanize the street frontage.

Understood and provided.

References: SD1.20 / SD3.02 / L1 / L2 / L3 / L8

 Consider reviewing the trellis element to provide more weather protection and more connection to the indoor amenity area.

Understood and provided. We have revised the Outdoor Amenity to provide weather protection at the Indoor to Outdoor Amenity connection by extending the 2nd floor of the building to provide cover.

References: SD1.20 / SD3.02 / L1 / L2 / L3 / L8

KEYSTONE ARCHITECTURE & PLANNING LTD



Consider gas-alternative energy sources for the outdoor fireplace.

Understood. This will be reviewed with the Mechanical Consultant during BP design development.

 Consider larger HRV/EVR units and find locations as close to an outside wall as possible.

Understood. This will be reviewed with the Mechanical Consultant during BP design development.

• Ensure the mailroom on level one is designed for backloading, as per Canada Post requirements.

Understood. This will be reviewed with the during BP design development. The Mailroom design will provide the required rear access design that Canada Post requires for buildings with more than 100 residences.

Site

 The site design addresses the grade quite well and the edge conditions are well considered.

Understood.

Form and Character

 Recommend that the Applicant provide a firm commitment to the use of black window frames, as they are an important design element of the building. In addition, alternative elevations showing white or beige window frames should be provided so the actual design can be properly assessed.

Understood. The black windows will be a requirement for the exterior design. The Design Team will ensure that this is reviewed and carried through the Construction process for the project.

Consider implementing a stronger main entry design.

With the 6th Floor setback incorporated, the main entry design does have a strong presence and provides unique point of entry for the building.



 Consider redesigning the ground floor units so that they have meaningful front door entrances. This may require enlarging the units (either two storey or wider). Consider eliminating some of the columns.

We have revised the exterior wall to increase the front entrance to the ground floor units and provided front door entrances.

References: SD1.20 / SD3.02 / SD3.0.3

 Recommend allocating the south elevator for firefighter access and moving as the north elevator is at a pinch-point.

Understood. This has been noted on the Fire Department Site Plan.

References: SD1.21

Review the corner elevator location for furniture maneuvering in the lobby.

The pinch point is the same width as the hallway proper. It is expected that the elevator center on the entrance would be the elevator that is used for furniture to be moved to the upper floors.

 Consider shifting the feature wall towards the bedroom in Units B5 to provide a more spacious feeling.

We have revised the exterior wall to increase living room spaces in the B5 Units.

References: SD1.20 / SD3.02 / SD3.0.3

Landscape

 Consider implementing additional covered outdoor or rooftop amenity space to make up for the lack of indoor amenity space.

Understood and provided. We have revised the Outdoor Amenity to provide weather protection at the Indoor to Outdoor Amenity connection by extending the 2nd floor of the building to provide cover.

References: SD1.20 / SD3.02 / L1 / L2 / L3 / L8



CPTED

Consider glazing for the parkade, elevator, lobby, vestibules, and exit stairs.

Understood. Glazing will be provided in the parkade as noted. This will be finalized during BP design development.

Sustainability


- Consider thermally modified ash for exterior furniture. Avoid lpe or tropical woods.
- Use energy modeling to inform design rather than just a compliance tool.
- Consider future weather files to test the performance and resiliency of the project.
- As noted under Key Points, larger HRV/ERV units provide benefits such as better energy performance, better filtration, and summer bypass that do not add heat during the summer.
- Consider providing E-Bike charging.

Understood. This will be reviewed with the Mechanical, Electrical, and Energy Model Consultants during BP design development.

Kind regards,

Kyle Nagtegaal Project Manager Architectural Technologist AIBC

Keystone Architecture & Planning Ltd.

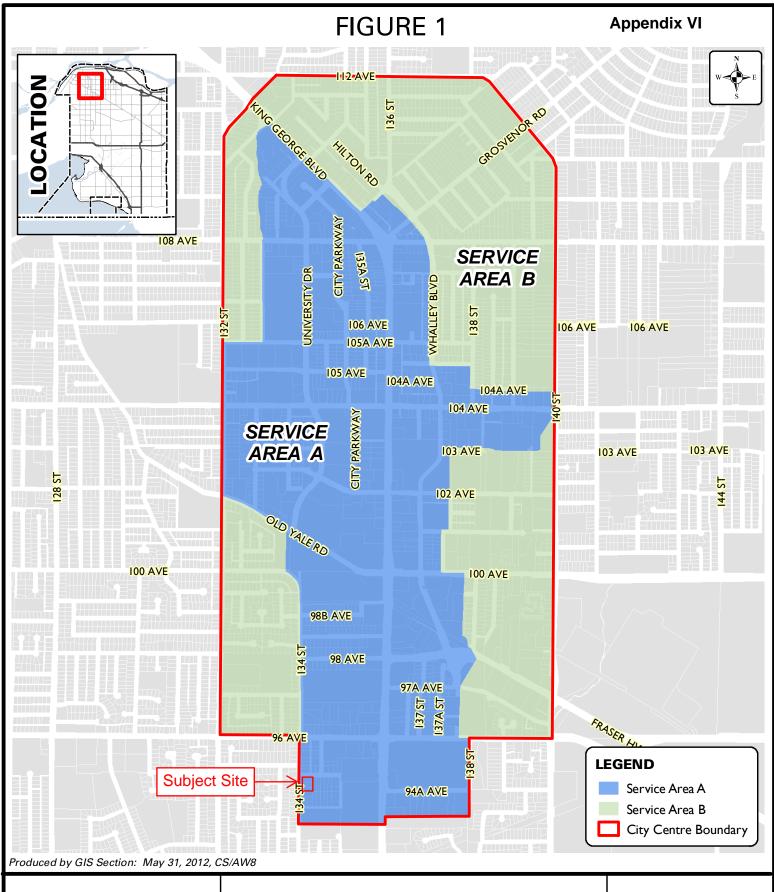



DISTRICT ENERGY SERVICE AREA (SERVICE AREA A & SERVICE AREA B)

ENGINEERING DEPARTMENT

The data provided is compiled from various sources and IS NOT warranted as to its accuracy or sufficiency by the City of Surrey. This information is provided for information and convenience purposes only.

Lot sizes, Legal descriptions and encumbrances must be confirmed at the Land Title Office.

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