

City of Surrey PLANNING & DEVELOPMENT REPORT Application No.: 7922-0085-00

Planning Report Date: April 22, 2024

PROPOSAL:

- OCP Amendment to Figures 3 and 16 from Multiple Residential to Downtown 3.5 FAR
- **City Centre Plan Amendment** from Low to Mid Rise Residential to Mid to High Rise Residential
- Rezoning from RF to CD
- Development Permit
- Housing Agreement

to permit the phased development of two residential buildings including a 22-storey tower and a 6-storey low-rise building with a total of 318 residential dwelling units including 58 rental units secured with a Housing Agreement.

LOCATION: 13760 101A Avenue, 13770 101A Ave,

13780 101A Ave, 13790 101A Ave,

13806 101A Ave


ZONING: RF

OCP DESIGNATION: Multiple Residential

CITY CENTRE PLAN

Low to Mid Rise Residential

DESIGNATION:

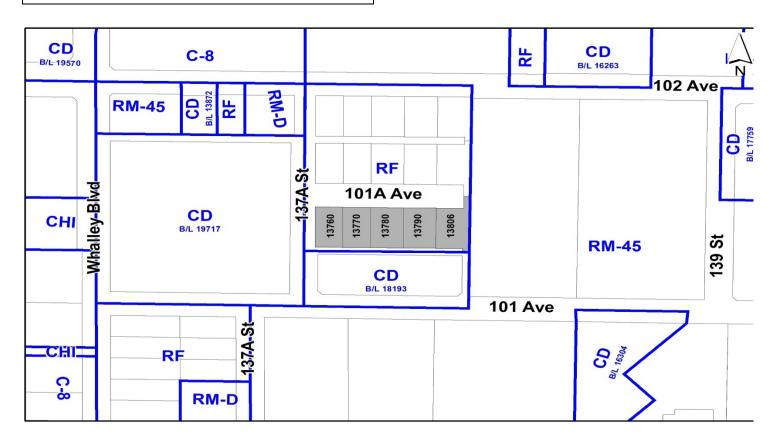

RECOMMENDATION SUMMARY

- By-law Introduction and set date for Public Hearing for:
 - OCP Amendment; and
 - Rezoning.
- Approval to draft Development Permit for Form and Character.
- By-law Introduction, First, Second and Third Reading for a Housing Agreement.

DEVIATION FROM PLANS, POLICIES OR REGULATIONS

- The proposal does not comply with the Multiple Residential designation in the Official Community Plan (OCP). Proposing an amendment to the Official Community Plan (OCP) from Multiple Residential to Downtown
- The proposal does not comply with the Low to Mid Rise Residential designation in the Surrey City Centre Plan. Proposing an amendment to the Surrey City Centre Plan from Low to Mid Rise Residential to Mid to High Rise Residential.

RATIONALE OF RECOMMENDATION

- The proposal complies with the Development Permit requirements in the OCP for Form and Character.
- The proposed density and building form are appropriate for this part of Surrey City Centre, and forms part of an emerging medium to high-density hub that will be complementary to the Green Timbers Neighbourhood.
- The provincial legislation introduced in December 2023, designates the site within a Skytrain Station Transit Oriented Area (TOA), Tier 3, which allows for a minimum FAR of 3.0 and a minimum height of 8-storeys.
- The proposed development conforms to the goal of achieving higher-density development nodes around SkyTrain Stations. The proposed residential tower with 5-storey podium and 6-storey purpose-built rental apartment building are located approximately 550 metres (approximately 7 minutes) from both the Surrey Central and King George Skytrain Stations.
- The proposed setbacks achieve a more urban, pedestrian streetscape in compliance with the Surrey City Centre Plan and in accordance with the Development Permit (Form and Character) design guidelines in the OCP.
- The street interface has been designed to a high quality to achieve a positive urban experience between the proposed building and the public realm, including the future park north across 101A Avenue, with a publicly accessible plaza space.

- The proposed buildings achieve an attractive architectural built form, which utilizes high quality materials and contemporary lines. The street interface has been designed to a high quality to achieve a positive urban experience between the proposed building and the public realm.
- The proposal includes 58 purpose-built rental units, which will be secured through a Housing Agreement for a minimum 40-year duration.

RECOMMENDATION

The Planning & Development Department recommends that:

- 1. A By-law be introduced to amend the OCP Figure 3: General Land Use Designations for the subject site from Multiple Residential to Downtown 3.5 FAR and to Figure 16: Downtown Densities to include the site and a date be set for Public Hearing.
- 2. Council determine the opportunities for consultation with persons, organizations and authorities that are considered to be affected by the proposed amendment to the Official Community Plan, as described in the Report, to be appropriate to meet the requirement of Section 475 of the Local Government Act.
- 3. A Bylaw be introduced to rezone the subject site from "Single Family Residential Zone (RF)" to "Comprehensive Development Zone (CD)" and a date be set for Public Hearing.
- 4. A Bylaw be introduced to enter into a Housing Agreement and be given First, Second and Third Reading (Appendix VI).
- 5. Council authorize staff to draft Development Permit No. 7922-0085-00 generally in accordance with the attached drawings (Appendix I).
- 6. Council instruct staff to resolve the following issues prior to final adoption:
 - (a) ensure that all engineering requirements and issues including restrictive covenants, dedications, and rights-of-way where necessary, are addressed to the satisfaction of the General Manager, Engineering;
 - (b) submission of a subdivision plan to the satisfaction of the Approving Officer;
 - (c) resolution of all urban design issues to the satisfaction of the Planning and Development Department;
 - (d) submission of a finalized landscaping plan and landscaping cost estimate to the specifications and satisfaction of the Planning and Development Department;
 - (e) submission of a finalized tree survey and a statement regarding tree preservation to the satisfaction of the City Landscape Architect;
 - (f) the applicant enter into a Housing Agreement with the City to restrict a total of 58 dwelling units on the subject site to rental housing for a period of forty (40) years;
 - (g) provision of cash-in-lieu contribution to satisfy the indoor amenity space requirement at the rate in effect at the time of Final Adoption;
 - (h) demolition of existing buildings and structures to the satisfaction of the Planning and Development Department;
 - (i) registration of a Section 219 Restrictive Covenant for the residential tower to adequately address the City's needs with respect to public art, to the satisfaction of

- the General Manager Parks, Recreation and Culture and with respect to the City's Affordable Housing Strategy and Tier 1 Capital Project CACs, to the satisfaction of the General Manager, Planning & Development Services;
- (j) registration of a Section 219 Restrictive Covenant to reflect the 58 rental units and ensure the proposal will adequately address the City's needs with respect to Public Art, Affordable Housing and Capital Project CACs (Tier 1 and Tier 2) if the market rental tenure of the proposed development changes, at any point in the future;
- (k) registration of a volumetric statutory right-of-way for public rights-of-passage for the proposed plaza spaces;
- (l) registration of easement agreements for shared amenity spaces, vehicular access and underground space;
- (m) review of the project by the Advisory Design Panel and resolution of design comments to the satisfaction of the General Manager, Planning & Development Department; and
- (n) the applicant provide a density bonus amenity contribution consistent with the Tier 2 Capital Projects CACs in support of the requested increased density, to the satisfaction of the General Manager, Planning and Development Department.
- 7. Council pass a resolution to amend the Surrey City Centre Plan to redesignate the land from "Low to Mid-Rise Residential" to "Mid to High Rise Residential" when the project is considered for final adoption.

SITE CONTEXT & BACKGROUND

Direction	Existing Use	City Centre	Existing Zone
		Designation	
Subject Site	Single family	Low to Mid-Rise	RF
	homes	Residential	
North (Across 101A Avenue):	Single family	Park	RF
	homes		

Direction	Existing Use	City Centre	Existing Zone
		Designation	
East (Across future long-term	Two-storey	Low to Mid-Rise	RM-45
road):	townhouses	Residential	
South (Across the lane):	6-storey apartment	Low to Mid-Rise	CD (Bylaw No.
	buildings	Residential	18193)
West (Across 137A Street):	3-storey rental	High-Rise Mixed	CD (Bylaw No.
	apartment	Use Type I	19717)
	buildings with an		
	approved mixed-		
	use development		
	(Application No.		
	18-0289-00)		
	consisting of		
	multiple high-rise,		
	mid-rise and low		
	rise buildings.		

Context & Background

- The subject site is located at 13760 to 13806 101A Avenue in the City Centre Plan. The subject site is approximately 3,817 square metres in area with existing single-family homes.
- The subject site is zoned "Single Family Residential Zone (RF)" and is designated "Low to Mid Rise Residential" in the City Centre Plan and "Multiple Residential" in the Official Community Plan (OCP).
- The applicant has applied for an OCP Amendment, a rezoning from RF to "Comprehensive Development Zone (CD)", a Housing Agreement and a Development Permit (Form and Character), to permit the phased development of two residential buildings including a 22-storey tower with 5-storey podium and a 6-storey low-rise building, with a total of 318 residential dwelling units including 58 rental units secured with a Housing Agreement.

DEVELOPMENT PROPOSAL

Planning Considerations

- The applicant is proposing the following:
 - o Rezoning from RF to CD Zone based on the RM-70 and RM-135 Zones;
 - o OCP Amendment to Figures 3 and 16 from Multiple Residential to Downtown;
 - o Detailed Development Permit for Form and Character; and
 - o Housing Agreement to secure 58 market rental units for a period of 40 years.

to permit the phased development of two residential buildings including a 22-storey tower with 5-storey podium and a 6-storey low-rise with a total of 318 residential dwelling units including 58 rental units secured with a Housing Agreement.

• Development data is provided in the following table:

	Proposed						
Lot Area							
Gross Site Area:	3,817 square metres						
Road Dedication:	323 square metres						
Road Dedication.	323 square metres						
Net Site Area:	3,492 square metres						
Number of	5 existing/1 proposed						
Existing/Proposed Lots:							
Building Height:	8o metres						
Gross Floor Area Ratio	5.3 FAR						
(FAR):							
Floor Area							
Residential:	20,279 square metres						
	-						
Total:	20,279 square metres						
Residential Units:							
Building 1 (Rental)							
Studio:	9						
1-Bedroom:	6						
1-Bedroom + Den	26						
2-Bedroom:	11						
3-Bedroom:	<u>6</u>						
Total:	58						
<u>Building 2 (Strata)</u>							
Studio:	37						
ı-Bedroom:	97						
1-Bedroom + Den	43						
2-Bedroom:	70						
2-Bedroom:	1						
3-Bedroom:	<u>12</u>						
Total:	260						

Referrals

Engineering: The Engineering Department has no objection to the project as

outlined in Appendix II.

School District:

The School District has advised that there will be approximately 31 school-age children generated by this development, of which the School District has provided the following expected student enrollment.

18 Elementary students at Lena Shaw School 8 Secondary students at Guildford Park School

(Appendix III)

Note that the number of school-age children is greater than the expected enrollment due to students attending private schools, home school or different school districts.

Parks, Recreation & Culture:

Parks has no concerns for the proposed development and recommends the retention of City tree C7.

Green Timbers is the closest park with natural area and is 675 metres walking distance from the site. Future active parkland is proposed within 20 metres walking distance of the development as part of the Surrey City Centre Plan.

Surrey Fire Department:

The Fire Department has no concerns with the proposed development application. There are items required to be addressed as part of the final Development Permit and Building Permit application.

Advisory Design Panel:

At the Regular Council – Land Use meeting on December 18, 2023, Council endorsed Corporate Report No. R214 (2023) which amended the Terms of Reference of the City's Advisory Design Panel (ADP) and enabled multi-family proposals that are greater than 6-storeys or commercial proposals that are greater than 3-storeys, to proceed to Council for By-law introduction, prior to review and/or comment from the ADP, provided that the proposal is generally supported by City staff.

The subject development proposal is generally supported by City staff and the applicant has agreed to resolve the outstanding items identified by staff in this report and the forthcoming ADP, to the satisfaction of the Planning and Development Department, prior to consideration of Final Adoption of the Rezoning By-law as well as issuance of the Development Permit.

Transportation Considerations

- The applicant will be providing the following road improvements to service the subject proposal:
 - Construction of the south side of 101A Avenue to the City's local road standard;
 - O Dedication and construction of 137A Street to the City's local road standard;

- Dedication towards the future 138 Street and construction of the west side sidewalk; and
- o Construction of the lane along the south side of the subject site.
- The subject proposal is anticipated to generate approximately one vehicle per minute in the peak hour, based on industry standard rates. A site-specific transportation impact assessment ("TIA") was not required as the number of trips anticipated to be generated is below the City's requirement for a TIA. In addition, an area-wide TIA was conducted as part of the City Centre Plan to inform the required infrastructure improvements for the Plan area based on a comprehensive analysis of ultimate redevelopment.
- Access to the subject site is proposed via the lane.

Sustainability Considerations

- The applicant has met all of the typical sustainable development criteria, as indicated in the Sustainable Development Checklist.
- In addition, the applicant has highlighted the following additional sustainable features:
 - Proximity to the Skytrain and multiple bus stops will reduce the number of vehicular trips to and from the building.
 - The proposed development is also located within close proximity to King George Hub, grocery stores, shopping, playgrounds and parks, schools and community services and amenities that are easily accessible via walking and cycling as healthy transportation options.
 - o The building will be connected to the City's District Energy system.
 - Maximizing indoor and outdoor amenity areas, development density and community connectivity.
 - o Reduction of waste to landfill through access to recycling and organic waste on-site.

POLICY & BY-LAW CONSIDERATIONS

Regional Growth Strategy

• The subject site is located within, and complies with, the Urban Centres (Surrey Metro Centre) Land Use Designation of Metro Vancouver's Regional Growth Strategy.

Official Community Plan

<u>Land Use Designation</u>

- The subject site is designated Multiple Residential in the Official Community Plan, with a permitted maximum density of 2.5 FAR, as noted in Figure 3 of the OCP.
- The applicant is proposing to amend Figures 3 and 16 from Multiple Residential to Downtown 3.5 FAR.

Amendment Rationale

- The proposed density and building form are appropriate for this part of Surrey City Centre, and forms part of an emerging mid to high-density neighbourhood within the Green Timbers District in City Centre.
- The proposed development conforms to the goal of achieving high density development around the three SkyTrain Stations. The King George and Surrey Central Skytrain Stations are located less than 600 metres and 800 metres walking distance, respectively, from the subject site.
- The proposed tower forms are appropriate within the context of the approved mixed-use development inclusive of high, mid and low-rise buildings to the west (Application No. 18-0289-00) and the with the existing 6-storey buildings south across the lane.
- The application will be subject to the Community Amenity Contribution (Capital Projects) and Density Bonus Program, which was endorsed by Council at the December 16, 2019, Regular Council Land Use Meeting.

Public Consultation for Proposed OCP Amendment

• Pursuant to Section 475 of the <u>Local Government Act</u>, it was determined that it was not necessary to consult with any persons, organizations, or authorities with respect to the proposed OCP amendment, other than those contacted as part of the pre-notification process.

Themes/Policies

- The proposed development is consistent with the following OCP Themes and Policies:
 - Growth Management
 - Accommodating Higher Density: Direct higher-density development into Surrey's City Centre.
 - o Centres, Corridors and Neighbourhoods:
 - Dynamic City Centre: Strengthen Surrey's City Centre as a dynamic, attractive, and complete Metropolitan Core.
 - Transit Corridors: Support Transit Oriented Development along major corridors linking urban centres and employment areas.
 - Healthy Neighbourhood: Build complete, walkable, and green neighbourhoods.
 - Urban Design: Encourage beautiful and sustainable urban design.
 - Ecosystems
 - Energy, Emissions and Climate Resiliency: Design a community that is energy-efficient, reduces carbon emissions and adapts to a changing environment.
 - Economy
 - Employment, Investment and Innovation: Ensure high-quality, business innovation and diversified employment and investment opportunities.

Secondary Plans

Land Use Designation

- The subject site is designated Low to Mid Rise Residential in the City Centre Plan.
- The application proposes to amend the City Centre Plan from Low to Mid Rise Residential to Mid to High Rise Residential.

Amendment Rationale

- The proposed density and building form are appropriate for this part of Surrey City Centre and will complement higher density developments nearby to the south and west.
- The applicant will be subject to the Community Amenity Contribution (Capital Projects) and Density Bonus Program, which received final adoption from Council at the December 16, 2019, Regular Council – Land Use Meeting.

Themes/Objectives

- The proposed development is consistent with the following guiding principles of the City Centre Plan:
 - Build Density and Mixed Use, by providing a mix of commercial, office and residential space.
 - Encourage Housing Diversity, with a mix of rental and condominium units and a variety of unit types and sizes.
 - Promote Identity and Sense of Place, with a unique blend of interconnected, amenity and residential spaces.

Housing Agreement

- Section 483 of the Local Government Act authorizes local governments to enter into Housing Agreements, for terms and conditions agreed to by the owner and the local government, that pertain to the occupancy of the housing units.
- The applicant has proposed to enter into a Housing Agreement with the City of Surrey that will allocate all 58 dwelling units within the low-rise building (Building 1) created under this development proposal as market rental units for a period of 40 years.
- The applicant will be required to enter into a Housing Agreement, as part of the subject development application (Appendix VI).

CD By-law

- The applicant is proposing to rezone the subject site from "Single Family Residential Zone (RF)" to "Comprehensive Development Zone (CD).
- The applicant is proposing a new "Comprehensive Development Zone (CD)" to accommodate:
 - o one 22-storey residential tower with a 5-storey podium and 260 dwelling units; and
 - one, 6-storey purpose-built rental apartment building consisting of 58 rental dwelling units.

- The proposed CD Bylaw for the proposed development site identifies the uses, densities and setbacks proposed. The CD Bylaw will have provisions based on the "Multiple Residential 135 Zone (RM-135)".
- A comparison of the density, lot coverage, setbacks, building height and permitted uses in the RM-135 Zone and the proposed CD Bylaw is illustrated in the following table.

Zoning	RM-135 Zone (Part 25)	Proposed CD Zone
Floor Area Ratio:	2.5 FAR	5.8 FAR
Lot Coverage:	33%	63%
Yards and Setbacks	7.5 metres or	North: 5.0 metres
	50% the height of	East: 4.5 metres
	the building	South: 4.5 metres
D: : 1D:11	27/4	West: 4.5 metres
Principal Building Height:	N/A	80 metres/22-storeys
Permitted Uses:	The RM-135 Zone	The proposed uses are consistent with
	permits multiple	the RM-135 Zone.
	unit residential	
	buildings and	
	ground-oriented	
	multiple	
	residential	
	buildings.	
Indoor Amenity:	Building 1:	
	185 square metres	The proposed 150 m2[+ CIL of
	Building 2:	\$32,000] meets the Zoning By-law requirement.
	740 square metres	requirement.
	Building 1: 185	The proposed 500 m ² [+ CIL of
Outdoor Amenity:	square metres	\$240,000] meets the Zoning By-law requirement.
	Building 2:	
	816 square metres	The proposed 190 square metres exceeds the requirement.
		1
		The proposed 820 square metres exceeds the requirement
Parking (Pa	rt 5)	Proposed
Building 1		
Residential: 38		Building 1
Residential Visitor: 6		Residential: 38
Building 2		

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Residential: 234	Residential Visitor: 6
	Building 2
Residential Visitor: 26	Residential: 268
Total: 304	Residential Visitor: 26
	Total: 338
Residential Secure Bike Parking: 394	418

- The proposed CD Bylaw will incorporate similar uses as the RM-135 Zone.
- The proposed floor area ratio (FAR) of the development is 5.8 net FAR (5.3 gross FAR), and the lot coverage is proposed to be 63%, which will exceed the maximum 2.5 FAR and 33% lot coverage permitted under the RM-135 Zone.
- Given the site's location in City Centre and proximity to Skytrain stations and public transit options, the proposed density is supportable, and the proposed lot coverage is consistent with other similar high-rise developments in City Centre.
- The RM-135 Zone requires the setbacks to be 7.5 metres or a minimum of 50% of the building height, whichever is greater. The applicant is proposing reductions for all setbacks in the CD Bylaw. The reduction in building setbacks is supportable as they allow for a more urban and active engagement of the streets, which is desirable for the City Centre area, and the setbacks are consistent with the City Centre Plan design guidelines as well as the Development Permit (Form and Character) design guidelines in the Official Community Plan.
- The proposed building height is consistent with other existing and proposed high-rises and 6-storey apartments in the area.

Capital Projects Community Amenity Contributions (CACs)

- On December 16, 2019, Council approved the City's Community Amenity Contribution and Density Bonus Program Update (Corporate Report No. R224; 2019). The intent of that report was to introduce a new City-wide Community Amenity Contribution (CAC) and updated Density Bonus Policy to offset the impacts of growth from development and to provide additional funding for community capital projects identified in the City's Annual Five-Year Capital Financial Plan. A fee update has been approved in April 2024, under Corporate Report No.R046;2024.
- The proposed development includes 58 market rental units that will be secured through a Housing Agreement. As such, these units within the development proposal will not be subject to the Tier 1 or Tier 2 Capital Plan Project CACs.
- The applicant will be required to register a Section 219 Restrictive Covenant on title specifying that, if there is a future change in residential tenure, the applicable Tier 1 and Tier 2 CACs will be paid to the City at the rate in effect at the time of final approval.
- The proposed market strata residential use will be subject to the Tier 1 Capital Plan Project CACs. The contribution will be payable at the rate applicable at the time of Building Permit issuance. The current rate is \$2,227.85 per new unit.

- The proposed development is seeking an overall gross density of 5.3 FAR. Purpose-built market rental units (when secured through a Housing Agreement) are exempt from the density bonus amenity provisions of the policy.
- The market strata building represents a gross density of 4.2 FAR, which exceeds the allowable 2.5 FAR by 1.7 FAR.
- Therefore, the proposed development will be subject to the Tier 2 Capital Plan Project CACs as the proposal does not comply with the densities in the Secondary Plan designation for the portion of the site developed as market, non-rental, strata residential.

Affordable Housing Strategy

- On April 9, 2018, Council approved the City's Affordable Housing Strategy (Corporate Report No. Ro66; 2018) requiring that all new rezoning applications for residential development contribute \$1113.92 per new unit to support the development of new affordable housing. The funds collected through the Affordable Housing Contribution will be used to purchase land for new affordable rental housing projects.
- The applicant will be required to register a Section 219 Restrictive Covenant to address the City's needs with respect to the City's Affordable Housing Strategy for the proposed 22-storey tower.
- As secured rental, the proposed 6-storey building is exempt from the provisions in this policy. The applicant will be required to register a Section 219 Restrictive Covenant, making the fees payable if there is a future change in tenure from the market rental, to address the City's needs with respect to the City's Affordable Housing Strategy.

Public Art Policy

- The applicant will be required to provide public art, or register a Restrictive Covenant agreeing to provide cash-in-lieu, at a rate of 0.5% of construction value, to adequately address the City's needs with respect to public art, in accordance with the City's Public Art Policy requirements. The applicant will be required to resolve this requirement prior to consideration of Final Adoption.
- The Public Art contribution will not be required for the proposed 58 purpose-built market rental units. A Section 219 Restrictive Covenant will be required to be registered on title that states the Public Art contribution will be applicable and payable to the City if there is a future change in tenure from market rental residential units.

PUBLIC ENGAGEMENT

• Pre-notification letters were sent on April 5, 2024, and the Development Proposal Signs were installed on April 5, 2024. Staff received two responses from a neighbouring owner with concerns regarding the additional traffic within the existing lane adjacent to the south. The owner also expressed concern regarding the additional vehicle access within the lane to the future buildings.

(As per the City's Engineering Design Criteria Manual, access is to be taken from the lowest classified road, which in this case is the lane, with the primary function of a lane being to provide direct access to properties. The additional traffic generated from the subject site is anticipated at approximately one vehicle per minute in the afternoon peak hour, based on industry standard rates, and less during other times of the day).

DEVELOPMENT PERMIT

Form and Character Development Permit Requirement

- The proposed development is subject to a Development Permit for Form and Character and is also subject to the urban design guidelines in the Surrey City Centre Plan.
- The proposed development generally complies with the Form and Character Development Permit guidelines in the OCP and the design guidelines in the Surrey City Centre Plan in terms of form, however changes to the character of the building are anticipated.
- The applicant has worked with staff towards developing a design that incorporates City Centre urban design guidelines and principles through tower and podium refinement, public realm, and street interface, and grading considerations, however further design development is required.
- This application is required to proceed to Advisory Design Panel (ADP) for review. However, as noted earlier in this report, this application is being brought forward to Council for consideration and bylaw introductions in advance of ADP. The application is required to proceed to ADP for review and comment and to respond to ADP comments in advance of final adoption.
- The applicant is aware that if changes to the proposed CD Bylaw are required to address ADP comments, the application will need to be reconsidered by Council.
- The applicant and staff will continue to work on the following items prior to final adoption of the development:
 - o General design refinements to address ADP and staff comments;
 - o Provision of additional drawing details to illustrate intent;
 - o Coordination of all drawings to accurately describe the design intent;
 - Refinement of the tower material and fenestration arrangements in particular to improve the relationship to the podium and sloping ground plane;
 - Designing interface improvements between the public realm, landscape design and ground floor activities and programs;
 - Reviewing and refining the balcony expressions considering their significance as features of the tower appearance;
 - Further tapering the tower's uppermost storeys to create interest, integrating mechanical structures and reducing shadowing of the future park;
 - Continuing to refine the low-rise building's main lobby's sense of identity, reflecting the scale of the development.

- Provision of design development of the publicly accessible open spaces and coordination of services at the ground plane that do not negatively impact the public realm.
- The proposed tower is located on the mid-west portion of the site towards the westerly neighbour's approved tower development. The tower maintains a 50-metre separation from that future westerly tower for adequate privacy, light, air circulation and distribution of massing in the neighbourhood. It is also sited to avoid the courtyard opening on the south neighbour's development.
- The tower rises both from the ground and the lower storeys of the podium. This arrangement of two origins simultaneously plants the tower to the ground while also connecting its massing to the podium, which staggers along the sloped site, giving balance to the massing.
- The tower is composed of glass curtain wall and long vertical bands of solid cladding to sculpt the form differently on its different sides.
- The purpose-built 6-storey rental building is located on the east portion of the site and has recessed 5th and 6th floors along the east portion of the building to respond to the existing 2-storey townhouses to the east.
- There are separate lobbies for each building, both located along 101A Avenue. The tower has a through-lobby design with the primary lobby located along 101A Avenue and the secondary lobby from the lane. This lobby design adds functionality, light, and increased opportunities for social interaction.
- The massing responds to the neighbouring easterly townhouses as it creates a strong line with its 4-storey expression which steps back from 138 street at the 5th and 6th storey.
- The buildings have a separation above the lowest level of 6 meters which increases to 10 m in width above the 4th level. This permits a view cone and sunlight through these storeys which benefits the subject development and the south neighbour.
- Both buildings on the site anchor the development at the base by having 2-storey townhouses along the streets and lane to present a stronger pedestrian oriented relationship. It also helps the building respond to the steep grade by stepping each unit along its own frontage. These units are expressed in a light-coloured grey brick cladding for durability and visual weight and are organized with individual front doors with weather protection canopy that bolsters the focus of the townhouse appearance and enlivens the streetscape.
- On the lane side, building separations of 16 m to 20 m are provided, depending on the unit orientations, to allow adequate privacy separation from each other.

Landscaping

The landscape concept has been designed to respond to the urban nature of City Centre as an
active, pedestrian-friendly space. The overall design considers the relationship between the
buildings and their location, and incorporates an inclusive interface between the public and
private realm.

- Each individual ground-oriented unit will have a small private patio enclosed by an individual gate with layered planting and a tree.
- Edge landscaping, seating, low retaining walls and specialty paving are proposed along the periphery at the base of the site.
- Additional landscaping is proposed in all the outdoor amenity spaces, both podium and roof levels.

Indoor Amenity Space

High-Rise Tower

- Per the Indoor Amenity Space requirements of the Zoning Bylaw No. 12000, high-rise towers must provide 3 square metres of indoor amenity space per unit up to 557 square metres per tower, which equates to 186 units, plus 1 square metre per unit above 557 square metres.
- Based upon the City's Zoning Bylaw requirement, the proposed high-rise tower must provide a total of 740 square metres of indoor amenity space for the proposed 260 residential units.
- The applicant is proposing 500 square metres of indoor amenity space located throughout the building, which is a shortfall of 240 square metres as required under the Zone.
- The proposed indoor amenity space exceeds the minimum requirement of 330 square metres before cash-in-lieu can be provided, as outlined under general provisions of the Zoning Bylaw.

- The applicant will be required to address the cash-in-lieu contribution in advance of final adoption.
- Indoor amenity spaces are proposed on level 7 and on the roof (level 23). The indoor spaces are intended to provide for a wide range of activities and include a meeting room, coworking/study room, lounge and a fitness area. Some of the indoor spaces are connected and open onto outdoor amenity spaces with their own programs/functions.
- Indoor amenity spaces are proposed to be shared between the high-rise and low-rise buildings with appropriate easement agreements secured as a condition of final adoption. 6-storey Rental Apartment
- Per the Indoor Amenity Space requirements of the Zoning Bylaw No. 12000, low rise residential buildings must provide 3 square metres of indoor amenity space per unit and 4 square metres for each micro unit.
- Based upon the City's Zoning Bylaw requirement, the proposed 6-storey apartment building must provide a total of 185 square metres of indoor amenity space for the proposed 58 residential units.
- The applicant is proposing 150 square metres of indoor amenity space located throughout the development, which is below the total indoor amenity space required under the Zone but exceeds the minimum requirement of 118 square metres before cash-in-lieu can be provided, as outlined under general provisions of the Zoning Bylaw.
- The applicant will be required to pay cash-in-lieu for the shortfall of square metres of indoor amenity space prior to final adoption in accordance with City policy.
- The indoor amenity space proposed on the main floor, level 1, faces the lane and will include a lounge room with a kitchen and a fitness room. The indoor space is connected to an outdoor amenity deck spaces with its own programing. There is additional amenity space on level 5 connected to an outdoor area.

Outdoor Amenity Space

High-Rise Tower

- Based upon the City's Zoning Bylaw requirement of 3 square metres per dwelling unit and 4 square metres per micro unit of outdoor amenity space, a total of 816 square metres of outdoor amenity space is required for the proposed residential high-rise tower.
- The applicant is proposing 820 square metres of outdoor amenity space, which exceeds the total outdoor amenity space required under the Zone.
- Outdoor amenity spaces are proposed on level 7 and on the roof (Level 23). The Level 7 outdoor amenity area consists of a turf and paving surfaces, lounge seating, dining tables and covered areas.

• The outdoor amenity space proposed on the rooftop (Level 23) includes turf and paving surfaces, seating area with table and chairs as well as bench seating area and community garden space.

6-storey Rental Apartment

- Based upon the City's Zoning Bylaw requirement of 3 square metres per dwelling unit and 4 square metres for each micro unit of outdoor amenity space, a total of 185 square metres of outdoor amenity space is required for the proposed 6-storey apartment building.
- The applicant is proposing 190 square metres of outdoor amenity space, which exceeds the total outdoor amenity space required under the Zone.
- The outdoor amenity space proposed on the main floor (Level 1) is adjacent to the lane and the indoor amenity area. The outdoor patio is proposed for lounge and table and chair seating.
- The outdoor space on level 5 includes a children's play area, lounge seating and workstations and open and shaded spaces.
- Outdoor amenity spaces are proposed to be shared between the high-rise and low-rise buildings with appropriate easement agreements secured as a condition of final adoption.

TREES

• Corey Plester, ISA Certified Arborist of Mike Fadum and Associates Ltd. prepared an Arborist Assessment for the subject property. The table below provides a summary of the proposed tree retention and removal by tree species:

Table 1: Summary of Proposed Tree Preservation by Tree Species:

Table 1: Summary of Proposed Tree Preservation by Tree Species:											
Tree Species Existing Remove Retain											
Deciduous Trees (excluding Alder and Cottonwood Trees)											
Birch, Paper 1 1 0											
Maple, Japanese	1	1	0								
Cherry	4	4	0								
Lilac, Common	1	1	0								
	Coniferous Trees										
Spruce, Dwarf	1	1	0								
Pine, Shore	1	1	0								
Sawara, False Cypress Plumosa	1	1	0								
Sawara, False Cypress	1	1	0								
Lawson, False Cypress	1	1	0								
Douglas-Fir	7	7	0								
Cedar, Western Redcedar 6 6											
Hemlock, Western	1	1	0								
Spruce, White	1	1	0								

Total (excluding Alder and Cottonwood Trees)	27	27 27 0						
Total Replacement Trees Proposed (excluding Boulevard Street Trees)	I	44						
Total Retained and Replacement T Proposed	rees	44						
Estimated Contribution to the Gre Program	en City		\$5,500					

- The Arborist Assessment states that there are a total of 27 mature trees on the site, excluding Alder and Cottonwood trees. Of the 27 existing trees, none (0 %) of the total trees on the site are Alder and Cottonwood trees. The applicant proposes to retain no trees as part of this development proposal.
- For those trees that cannot be retained, the applicant will be required to plant trees on a 2 to 1 replacement. This will require a total of 54 replacement trees on the site. Forty-four (44) replacement trees can be accommodated and will require an estimated cash-in-lieu payment of \$5,500 representing \$550 per tree to the Green City Program, in accordance with the City's Tree Protection By-law.
- In addition to the replacement trees, boulevard street trees will be planted on 101A Avenue and 137A Street. This will be determined by the Engineering Department during the servicing design review process.
- The new trees on the site will consist of a variety of trees including Paperbark Maple and Japanese Stewartia.
- In summary, a total of 44 trees are proposed to be replaced on the site with an estimated contribution of \$5,500 to the Green City Program.

CITY ENERGY

- The subject site is located within Service Area B, as defined in the "City Centre District Energy System By-law" (see Appendix VII for location). The District Energy System consists of three primary components:
 - o community energy centres, City-operated facilities that generate thermal energy for distribution through a piped hot water network;
 - distribution piping that links the community energy centres with buildings connected to the system; and
 - City-owned energy transfer stations (ETS) located within the building connected to the system. The ETS transfers heat energy from the distribution system to the building's mechanical system, and is used to meter the amount of energy used.

- These Aervice Area B buildings will not be connected to District Energy system at the time of building completion. However, this building is considered as a future DE connection and the building would require:
 - Dedicated district energy room (ideally fronting 137A Street);
 - Site servicing plan to reflect District Energy alignment; and
 - 6 metre District Energy statutory-right-of-way and Section 219 covenant.

INFORMATION ATTACHED TO THIS REPORT

The following information is attached to this Report:

Appendix I.	Site Plan, Building Elevations, Landscape Plans and Perspective
Appendix II.	Engineering Summary
Appendix III.	School District Comments
Appendix IV.	Summary of Tree Survey, Tree Preservation and Tree Plans
Appendix V.	OCP Redesignation Map
Appendix VI.	Proposed Housing Agreement By-law and Housing Agreement
Appendix VII.	District Energy Location

approved by Ron Gill

Don Luymes General Manager Planning and Development

IM/ar





PROPOSED RESIDENTIAL TOWER DEVELOPMENT AT 13760,70,80,90,13806 101A AVENUE



DP APPLICATION FOR TWO BUILDINGS : 29-01-2024

	CITE	CTATICTICS	· · · · · · · · · · · · · · · · · · ·	
	SITE	STATISTICS		
CIVIC ADDRESS:		13760,70,80,90 13806 101 Ave Surrey BC	1	
LEGAL DISCRIPTION		13760,70,80,90 13806 101 AVE SUFFEY BC		
ZONING		RF TO CD BASED ON RF 135		
ZONING		NI TO CD BASED ON NI 135		
GROSS SITE AREA:	41096 ft2	3817 m2	.943 Acre	
ROAD DEDICATIONS:	3477 ft2	323 m2	J-13 ACI C	
NET AREA	37618 ft2	3494 m2	.88 Acre	
INCT AREA	37010102	04041112	.00 Acre	
ZONING	CD BASED OB RM 135			
20111110	BUILDING HEIGHT	ALLOWED	PROVIDED	
	DOILDING HEIGHT	ACCOVED	80m	
	L		OOTT	
	SETBACKS			
	NORTH - 101 a st		5.0 m	
	SOUTH - LANE		4.5 m	
	EAST:		4.5 m	
	WEST WEST			
LOT COVERAGE	I C J AA E D I		4.5 m	
LOT COVERAGE			1	
	PROPOSED	620	v l	
	FROPUSED	629	70	
DENICTY				
DENISTY			T 1	
	DRODGOED FCD	E 20 on gross		
	PROPSOED FSR	5.30 on gross	+ -	
DILLI DING FLOOD ADEA		5.80 on net		
BUILDING FLOOR AREA		(EXCLUDING PARKING)		
MIX USE BUILDING	D. F. A. D. A. F. T. L.	P. P. A. D. A. L. P. W. L. L.	RESIDNETIAL	
	RESIDNETIAL	RESIDNETIAL		
LEVELS	BUILDING 2 WITH TOWER	UNITS	BUILDING 1	UNITS
LEVEL 1	981 m2	16 UNITS	604 m2	6 UNITS
LEVEL 2 A	569 m2	3 UNITS		
LEVEL 2	1240 m2	17 UNITS	750 m2	6 UNTIS
LEVEL 3	1157 m2	18 UNITS	767m2	12 UNTIS
LEVEL 4	1157 m2	18 UNITS	767 m2	12 UNTIS
LEVEL 5	181.31 m2	3 UNITS	620m2	11 UNTIS
			620m2	11 UNTIS
LEVEL 6-18 (tower)	8450 m2	143 UNITS		
LEVEL 19- 22 (tower)	2416 m2	42 UNITS		
	16151.31 m2	260 UNITS	4128 m2	58 UNITS
TOTAL AREA	16151.31 m2	260 UNITS 20279.31 m2	4128 m2	58 UNITS
TOTAL AREA TOWER PLATE	16151.31 m2 650 m2		4128 m2	58 UNITS
TOWER PLATE		20279.31 m2 620 m2	4128 m2	58 UNITS
TOWER PLATE		20279.31 m2	4128 m2 PROVIDED	58 UNITS
TOWER PLATE	650 m2	20279.31 m2 620 m2	PROVIDED	58 UNITS
TOWER PLATE	650 m2 INDOOR AMENITY 58 x 3sq. m + 4 sq. m per micro unit x 11 = (185 sq.mt.)	20279.31 m2 620 m2 REQUIRED 185 Sq.mt.		58 UNITS
TOWER PLATE AMENITY SPACE	650 m2 INDOOR AMENITY 58 x 3sq. m + 4 sq. m per micro unit x	20279.31 m2 620 m2 REQUIRED 185 Sq.mt.	PROVIDED	
TOWER PLATE AMENITY SPACE	650 m2 INDOOR AMENITY 58 x 3sq. m + 4 sq. m per micro unit x 11 = (185 sq.mt.) 186 x 3sq. m + 4 sq. m per micro unit: 36 + 38 x 1sq. mt.= 740 sq.mt.	20279.31 m2 620 m2 REQUIRED 185 Sq.mt. 740 Sq.mt.	PROVIDED	
TOWER PLATE AMENITY SPACE BUILDING 1 BUILDING 2	650 m2 INDOOR AMENITY 58 x 3sq, m + 4 sq, m per micro unit x 11 = (185 sq,mt.) 186 x 3sq, m + 4 sq, m per micro unit:	20279.31 m2 620 m2 REQUIRED 185 Sq.mt. x 740 Sq.mt. 741 Sq.mt.	PROVIDED 150 Sq.mt. 500 Sq.mt	variance required
TOWER PLATE AMENITY SPACE BUILDING 1 BUILDING 2 BUILDING 1	650 m2 INDOOR AMENITY 58 x 3sq. m + 4 sq. m per micro unit x 11 = (185 sq.mt.) 186 x 3sq. m + 4 sq. m per micro unit: 36 + 38 x 1sq. mt.= 740 sq.mt.	20279.31 m2 620 m2 REQUIRED 185 Sq.mt. 740 Sq.mt.	PROVIDED 150 Sq.mt.	variance required
TOWER PLATE AMENITY SPACE BUILDING 1 BUILDING 1 BUILDING 1 BUILDING 2	650 m2 INDOOR AMENITY 58 x 3sq. m + 4 sq. m per micro unit x 11 = (185 sq.mt.) 186 x 3sq. m + 4 sq. m per micro unit: 36 + 38 x 1sq. mt.= 740 sq.mt.	20279.31 m2 620 m2 REQUIRED 185 Sq.mt. x 740 Sq.mt. 741 Sq.mt.	PROVIDED 150 Sq.mt. 500 Sq.mt	variance required
TOWER PLATE AMENITY SPACE BUILDING 1 BUILDING 1 BUILDING 1 BUILDING 2	650 m2 INDOOR AMENITY 58 x 3sq. m + 4 sq. m per micro unit x 11 = (185 sq.mt.) 186 x 3sq. m + 4 sq. m per micro unit: 36 + 38 x 1sq. mt.= 740 sq.mt.	20279.31 m2 620 m2 REQUIRED 185 Sq.mt. × 740 Sq.mt. 741 Sq.mt. 185 Sq.mt.	PROVIDED 150 Sq.mt. 500 Sq.mt 190 Sq.Mt. 820 Sq.Mt.	variance required
TOWER PLATE AMENITY SPACE BUILDING 1 BUILDING 1 BUILDING 1 BUILDING 2	INDOOR AMENITY 58 x 3sq, m + 4 sq, m per micro unit x 11 = (185 sq,mt.) 186 x 3sq, m + 4 sq, m per micro unit: 36 + 38 x 1sq, mt.= 740 sq,mt. OUTDOOR AMENITY BUILDING 1 (RENTAL)	20279.31 m2 620 m2 REQUIRED 185 Sq.mt. X 740 Sq.mt. 741 Sq.mt. 185 Sq.mt. 185 Sq.mt.	PROVIDED 150 Sq.mt. 500 Sq.mt 190 Sq.Mt. 820 Sq.Mt.	variance required
TOWER PLATE AMENITY SPACE BUILDING 1 BUILDING 1 BUILDING 1 BUILDING 2	INDOOR AMENITY 58 x 3sq. m + 4 sq. m per micro unit x 11 = (185 sq.mt.) 186 x 3sq. m + 4 sq. m per micro unit: 36 + 38 x 1sq. mt. = 740 sq.mt. OUTDOOR AMENITY	20279.31 m2 620 m2 REQUIRED 185 Sq.mt. 740 Sq.mt. 741 Sq.mt. 185 Sq.mt. 185 Sq.mt.	PROVIDED 150 Sq.mt. 500 Sq.mt 190 Sq.Mt. 820 Sq.Mt.	variance required
TOWER PLATE AMENITY SPACE BUILDING 1 BUILDING 1 BUILDING 1 BUILDING 2	INDOOR AMENITY 58 x 3sq, m + 4 sq, m per micro unit x 11 = (185 sq,mt.) 186 x 3sq, m + 4 sq, m per micro unit: 36 + 38 x 1sq, mt.= 740 sq.mt. OUTDOOR AMENITY BUILDING 1 (RENTAL) TOTAL UNITS 58	20279.31 m2 620 m2 REQUIRED 185 Sq.mt. X 740 Sq.mt. 741 Sq.mt. 185 Sq.mt. 185 Sq.mt.	PROVIDED 150 Sq.mt. 500 Sq.mt 190 Sq.Mt. 820 Sq.Mt.	variance required
TOWER PLATE AMENITY SPACE BUILDING 1 BUILDING 1 BUILDING 1 BUILDING 2	INDOOR AMENITY 58 x 3sq, m + 4 sq, m per micro unit x 11 = (185 sq,mt.) 186 x 3sq, m + 4 sq, m per micro unit: 36 + 38 x 1sq, mt.= 740 sq,mt. OUTDOOR AMENITY BUILDING 1 (RENTAL)	20279.31 m2 620 m2 REQUIRED 185 Sq.mt. X 740 Sq.mt. 741 Sq.mt. 185 Sq.mt. 185 Sq.mt.	PROVIDED 150 Sq.mt. 500 Sq.mt 190 Sq.Mt. 820 Sq.Mt.	variance required
TOWER PLATE AMENITY SPACE BUILDING 1 BUILDING 1 BUILDING 1 BUILDING 2	INDOOR AMENITY 58 x 3sq, m + 4 sq, m per micro unit x 11 = (185 sq,mt.) 186 x 3sq, m + 4 sq, m per micro unit: 36 + 38 x 1sq, mt.= 740 sq.mt. OUTDOOR AMENITY BUILDING 1 (RENTAL) TOTAL UNITS 58	20279.31 m2 620 m2 REQUIRED 185 Sq.mt. X 740 Sq.mt. 741 Sq.mt. 185 Sq.mt. 185 Sq.mt.	PROVIDED 150 Sq.mt. 500 Sq.mt 190 Sq.Mt. 820 Sq.Mt.	variance required
TOWER PLATE AMENITY SPACE BUILDING 1 BUILDING 1 BUILDING 1 BUILDING 2	INDOOR AMENITY 58 x 3sq, m + 4 sq, m per micro unit x 11 = (185 sq,mt.) 186 x 3sq, m + 4 sq, m per micro unit: 36 + 38 x 1sq, mt.= 740 sq.mt. OUTDOOR AMENITY BUILDING 1 (RENTAL) TOTAL UNITS 58	20279.31 m2 620 m2 REQUIRED 185 Sq.mt. X 740 Sq.mt. 741 Sq.mt. 185 Sq.mt. 185 Sq.mt.	PROVIDED 150 Sq.mt. 500 Sq.mt 190 Sq.Mt. 820 Sq.Mt.	variance required
TOWER PLATE AMENITY SPACE BUILDING 1 BUILDING 1 BUILDING 1 BUILDING 2	INDOOR AMENITY 58 x 3sq, m + 4 sq, m per micro unit x 11 = (185 sq,mt.) 186 x 3sq, m + 4 sq, m per micro unit: 36 + 38 x 1sq, mt = 740 sq,mt. OUTDOOR AMENITY BUILDING 1 (RENTAL) TOTAL UNITS 58 BUILDING 2 (PODIUM C/W TOWER)	20279.31 m2 620 m2 REQUIRED 185 Sq.mt. 740 Sq.mt. 741 Sq.mt. 185 Sq.mt. 816 Sq.mt. CALCULATING ON THE BASIS THEIR OF .65 PER UNIT = 38 STALLS	PROVIDED 150 Sq.mt. 500 Sq.mt 190 Sq.Mt. 820 Sq.Mt. PROVIDED 38 STALLS	variance required
TOWER PLATE AMENITY SPACE BUILDING 1 BUILDING 2 BUILDING 1 BUILDING 2 PARKING	INDOOR AMENITY 58 x 3sq, m + 4 sq, m per micro unit x 11 = (185 sq,mt.) 186 x 3sq, m + 4 sq, m per micro unit: 36 + 38 x 1sq, mt.= 740 sq,mt. OUTDOOR AMENITY BUILDING 1 (RENTAL) TOTAL UNITS 58 BUILDING 2 (PODIUM C/W TOWER) TOTAL UNITS: 260	20279.31 m2 620 m2 REQUIRED 185 Sq.mt. 740 Sq.mt. 741 Sq.mt. 185 Sq.mt. 816 Sq.mt. CALCULATING ON THE BASIS THEIR OF .65 PER UNIT = 38 STALLS	PROVIDED 150 Sq.mt. 500 Sq.mt 190 Sq.Mt. 820 Sq.Mt. PROVIDED 38 STALLS	variance required
TOWER PLATE AMENITY SPACE BUILDING 1 BUILDING 2 BUILDING 1 BUILDING 2 PARKING	INDOOR AMENITY 58 x 3sq, m + 4 sq, m per micro unit x 11 = (185 sq,mt.) 186 x 3sq, m + 4 sq, m per micro unit: 36 + 38 x 1sq, mt.= 740 sq,mt. OUTDOOR AMENITY BUILDING 1 (RENTAL) TOTAL UNITS 58 BUILDING 2 (PODIUM C/W TOWER) TOTAL UNITS: 260	20279.31 m2 620 m2 REQUIRED 185 Sq.mt. 740 Sq.mt. 741 Sq.mt. 185 Sq.mt. 816 Sq.mt. CALCULATING ON THE BASIS THEIR OF .65 PER UNIT = 38 STALLS	PROVIDED 150 Sq.mt. 500 Sq.mt 190 Sq.Mt. 820 Sq.Mt. PROVIDED 38 STALLS	variance required
TOWER PLATE AMENITY SPACE BUILDING 1 BUILDING 2 BUILDING 1 BUILDING 2 PARKING VISITOR PARKING, HANDICAP AI	INDOOR AMENITY 58 x 3sq, m + 4 sq, m per micro unit x 11 = (185 sq, mt.) 186 x 3sq, m + 4 sq, m per micro unit: 36 + 38 x 1sq, mt.= 740 sq, mt. OUTDOOR AMENITY BUILDING 1 (RENTAL) TOTAL UNITS 58 BUILDING 2 (PODIUM C/W TOWER) TOTAL UNITS : 260 ND BIKE PARKING	20279.31 m2 620 m2 REQUIRED 185 Sq.mt. X 740 Sq.mt. 741 Sq.mt. 185 Sq.mt. 816 Sq.mt. CALCULATING ON THE BASIS THEIR OF .65 PER UNIT = 38 STALLS PO PER UNIT = 234 STALLS	PROVIDED 150 Sq.mt. 500 Sq.mt 190 Sq.Mt. 820 Sq.Mt. PROVIDED 38 STALLS PROVIDED	variance required
TOWER PLATE AMENITY SPACE BUILDING 1 BUILDING 2 BUILDING 2 BUILDING 2 PARKING VISITOR PARKING, HANDICAP AI	INDOOR AMENITY 58 x 3sq, m + 4 sq, m per micro unit x 11 = (185 sq,mt.) 186 x 3sq, m + 4 sq, m per micro unit: 36 + 38 x 1sq, mt. = 740 sq,mt. OUTDOOR AMENITY BUILDING 1 (RENTAL) TOTAL UNITS 58 BUILDING 2 (PODIUM C/W TOWER) TOTAL UNITS: 260 ND BIKE PARKING TOTAL VISITOR PARKING	20279.31 m2 620 m2 REQUIRED 185 Sq.mt. 740 Sq.mt. 741 Sq.mt. 185 Sq.mt. 816 Sq.mt. CALCULATING ON THE BASIS THEIR OF .65 PER UNIT = 38 STALLS REQUIRED 318 X .1 = 32 STALLS	PROVIDED 150 Sq.mt. 500 Sq.mt 190 Sq.Mt. 820 Sq.Mt. PROVIDED 38 STALLS PROVIDED 268 STALLS PROVIDED 32 STALLS	variance required
TOWER PLATE AMENITY SPACE BUILDING 1 BUILDING 2 BUILDING 2 BUILDING 2 PARKING VISITOR PARKING, HANDICAP AI	INDOOR AMENITY 58 x 3sq, m + 4 sq, m per micro unit x 11 = (185 sq,mt.) 186 x 3sq, m + 4 sq, m per micro unit: 36 + 38 x 1sq, mt.= 740 sq,mt. OUTDOOR AMENITY BUILDING 1 (RENTAL) TOTAL UNITS 58 BUILDING 2 (PODIUM C/W TOWER) TOTAL UNITS: 260 ND BIKE PARKING H/C 2% of total parking	20279.31 m2 620 m2 REQUIRED 185 Sq.mt. 740 Sq.mt. 185 Sq.mt. 185 Sq.mt. 621 Sq.mt. 185 Sq.mt. 185 Sq.mt. 241 Sq.mt. 242 Sq.mt. 244 Sq.mt. 255 PER UNIT = 38 STALLS REQUIRED 316 X .1 = 32 STALLS 240x 2% = 7	PROVIDED 150 Sq.mt. 500 Sq.mt 190 Sq.Mt. 820 Sq.Mt. PROVIDED 38 STALLS PROVIDED 268 STALLS PROVIDED 32 STALLS 7 STALLS	variance required
TOWER PLATE AMENITY SPACE BUILDING 1 BUILDING 2 BUILDING 1	INDOOR AMENITY 58 x 3sq, m + 4 sq, m per micro unit x 11 = (185 sq,mt.) 186 x 3sq, m + 4 sq, m per micro unit: 36 + 38 x 1sq, mt. = 740 sq,mt. OUTDOOR AMENITY BUILDING 1 (RENTAL) TOTAL UNITS 58 BUILDING 2 (PODIUM C/W TOWER) TOTAL UNITS: 260 ND BIKE PARKING TOTAL VISITOR PARKING	20279.31 m2 620 m2 REQUIRED 185 Sq.mt. 740 Sq.mt. 741 Sq.mt. 185 Sq.mt. 816 Sq.mt. CALCULATING ON THE BASIS THEIR OF .65 PER UNIT = 38 STALLS REQUIRED 318 X .1 = 32 STALLS	PROVIDED 150 Sq.mt. 500 Sq.mt 190 Sq.Mt. 820 Sq.Mt. PROVIDED 38 STALLS PROVIDED 268 STALLS PROVIDED 32 STALLS	variance required



Unit 209- 6321 King George Blv Surrey BC, V3X 1G1 www.flatarchitecture.ca contact@flatarchitecture.ca

Ph: 604-503-4484

PROJECT INFO:
Apartment Building at 13760, 70, 80, 90 13806 101 A AVE. SURREY B.C. CLIENT:
Amarjeet Ubhi

PROJECT NO: 22-238

SCALE:

DRAWN BY: U.S. 12" = 1'-0"



DATA SHEET

SITE STASTICS N.T.S.

VELS	1	2A	2	3	4	5	6	7	8	9	10	11	12	13	14	15	16	17	18	19	20	21	22	
BUILDING 1																								TOTAL
1 BED UNIT	0		2	1	1	1	1																	
				_	_	_																		
1 BED + DEN UNIT	0		2	7	7	6	4																	
2 BED UNIT	0		1	2	2	3	3																	
2BED + DEN UNIT	0		0	0	0	0	0																	
3BED /TH/LU	6		0	0	0	0	0																	
STUDIO	0		1	2	2	1	3																	
510510	-					_	-																	
	6		6	12	12	11	11																	
BUILDING 2	1		7	8	8	0	4	4	- 1	- 4	- 1	- 1		4		1	4	4	4		6	-		TOTAI
1 BED UNIT	1		/	8	8	U	4	4	4	4	4	4	4	4	4	4	4	4	4	6	ь	ь		3
1 BED + DEN UNIT	5		6	6	6	3	1	1	1	1	1	1	1	1	1	1	1	1	1	. 1	1	1		1
2 BED UNIT	2	2	2	2	2	0	4	4	4	4	4	4	4	4	4	4	4	4	4	2	2	2		2
0050 05111111						0			0															
2BED + DEN UNIT	0		0	0	0	0	0	0	0	0	0	0	0	0	0	0	0	0	0	0	0	0		1
3BED /TH/LU	8	1	1	1	1	0	0	0	0	0	0	0	0	0	0	0	0	0	0	0 0	0	0		0
,,			_									_												
STUDIO	0		1	1	1	0	2	2	2	2	2	2	2	2	2	2	2	2	2	. 2	2	2		2
													200											
	16	3	17	18	18	3	11	11	11	11	11	11	11	11	11	11	11	11	11	. 11	11	11		9
TAL NUMBER OF UNITS	22		23	30	30	14	22	11	11	11	11	11	11	11	11	11	11	11	11	. 11	11	11		9

UNIT MATRIX

N.T.S.



FLAT ARCHITECTURE S

Unit 209- 6321 King George Blv Surrey BC, V3X 1G1 www.flatarchitecture.ca contact@flatarchitecture.ca

Ph: 604-503-4484

PROJECT INFO:
Apartment Building at 13760, 70, 80, 90 13806 101A AVE. SURREY B.C. CLIENT:
Amarjeet Ubhi

PROJECT NO: 22-238

SCALE:


DRAWN BY: R.W.



UNIT MATRIX





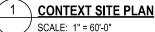



CONTEXTUAL AERIAL VIEW SCALE: 3" = 1'-0"

LOCATION

- THE SITE IS LOCATED AT THE GREEN TIMBERS NEIGHBORHOOD IN THE JURISDICTION OF CITY OF SURREY.
- THE SITE IS LOCATED IN A TRANSITIONING NEIGHBORHOOD. AS THE URBAN FABRIC TRANSITIONS TO HIGHER DENSITY, HIGH RISE. THE SITE OFFERS A POTENTIAL TO DEVELOP A PROPOSAL, THAT ACTS AS AN ANCHOR TO NEIGHBORHOOD FABRIC. AS A TRANSITIONING PROJECT. THAT HUMANIZES THE SCALE OF THE BUILT ENVIRONMENT.
- THE SITE LOCATED NEAR TRANSIT HUB AND OTHER CONVENIENCES, IT IS AN APT. LOCATION FOR HIGHER DENSITY.
- IN ADDITION THE SITE IS LOCATED IN CLOSE PROXIMITY TO THE PROPOSED GREEN INFRASTRUCTURE. PROVIDING A BALANCED URBAN FABRIC





Unit 209-6321 King George Blvd Surrey BC, V3X 1G1 www.flatarchitecture.ca

Ph: 604-503-4484

PROJECT INFO:
Apartment Building at 13760, 70, 80 90 13806 101A AVE. SURREY B.C. CLIENT:
Amarjeet Ubhi

DATE

29/01/2024


PROJECT NO: 22-238


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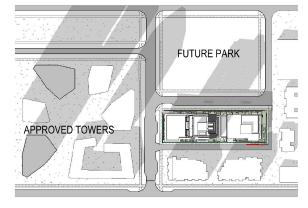
۹ ا	s in	dica	ited	ι	.S.		
					09-04-2024	02-02-2024	DATE
					us.	us.	BY
					ALID BHL OL NOLLYDRAW LNBWIGTBARD	DEVELOPMENT APPLICATION TO THE CITY	DESCRIPTION
					7.0	10	REV

SITE ANALYSIS





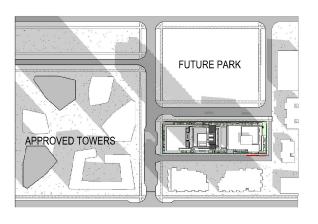

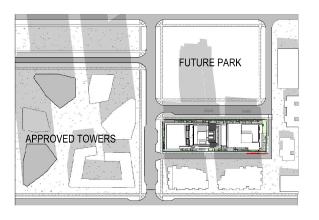








FUTURE PARK

APPROVED TOWERS



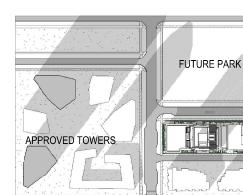

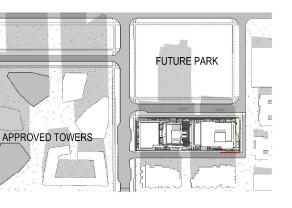

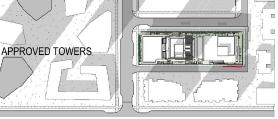









A 011

ARCHITECTURE S

Unit 209-6321 King George Blvd Surrey BC, V3X 1G1 www.flatarchitecture.ca contact@flatarchitecture.ca

Ph: 604-503-4484


PROJECT INFO:
Apartment Building at 13760, 70, 80, 90 13806 101A AVE. SURREY B.C. CLIENT:
Amarjeet Ubhi

DATE 29/01/2024 PROJECT NO:

22-238 SCALE: DRAWN BY:

1" = 200'-0" R.W.

CONCEPTUAL SHADOW STUDY

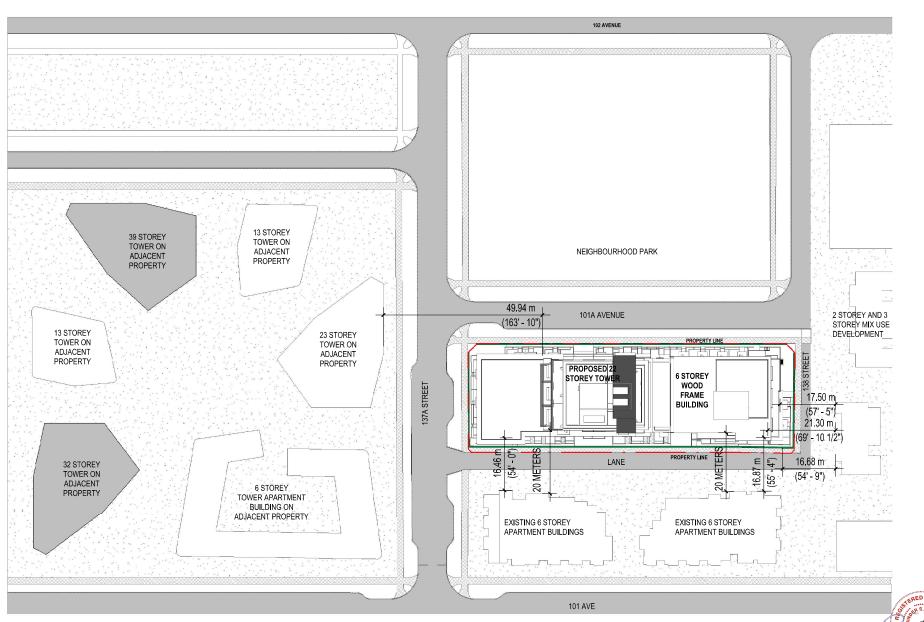



ARCHITECTURE

Unit 209-6321 King George Blvd Surrey BC, V3X 1G1 www.flatarchitecture.ca contact@flatarchitecture.ca

Ph: 604-503-4484


PROJECT INFO:
Apartment Building at 13760, 70, 80, 90 13806 101A AVE. SURREY B.C. CLIENT:
Amarjeet Ubhi

DATE 29/01/2024

PROJECT NO: 22-238

	CAL 1/64	1'-0'	RA W		BY:	
_				08-04-2024	02-02-2004	DATE
				us.	us.	₩.
				DEVELOPMENT APPLICATION TO THE CITY	DEVELOPMENT APPLICATION TO THE CITY	DESCRIPTION
				7.0	10	NEV

TOWER SEPARATION

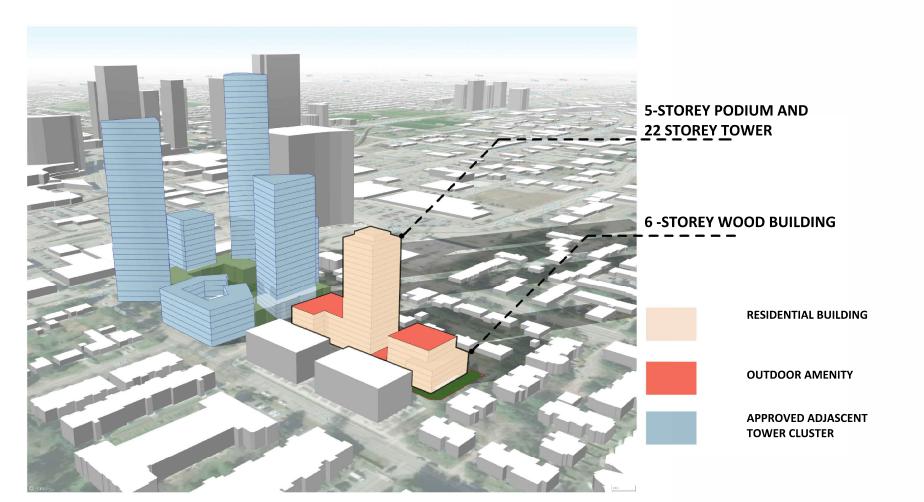

MASSING AND PROGRAMMING

SCALE: 6" = 1'-0"

Unit 209-6321 King George Blvd Surrey BC, V3X 1G1 www.flatarchitecture.ca contact@flatarchitecture.ca

Ph: 604-503-4484

DATE 29/01/2024

PROJECT NO: 22-238

SCALE:

6" = 1'-0"					F	.w.		
						1032 10 80	1005 20 20	DATE
						us.	us.	84
						ALID BHL OL NOLLYDRAW LNBWIGTBARD	DEVELOPMENT APPLICATION TO THE CITY	NOLLHEDSEG
						70	10	ABN

PROGRAMMIMG AND MASSING



SCALE: 1" = 30'-0"



CERAMIC BRICK: FINISH: DUAL TONE GREY CLINKER; Size: 238x115x47cm

EXTERIOR HIGH DENSITY FIBRE

CEMENT BOARD SIDING TO

MATCH; COLOR: WHITE



CONCRETE SAND BLASTED 14 FINISH



METAL PANEL; COLOR: DARK BROWN WOOD PANEL



METAL PANEL: COLOR: DARK 2 BROWN WOOD SIDDING



SOPREMA SPOPRASTAR HIGH ALBEDO ROOF WITH SRI VALUE OF .82



MATERIAL LEGEND:

. CERAMIC BRICK; FINISH: DUAL TONE GREY CLINKER; Size: 238x115x47cm

2. METAL PANEL; COLOR: DARK BROWN WOOD SIDDING

3. METAL PANEL; COLOR: WHITE 4. METAL PANEL; COLOR: BLACK 5. METAL PANEL; COLOR: GREY

6. EXTERIOR HIGH DENSITY FIBRE CEMENT BOARD C/W EASY TRIMS TO MATCH: COLOR: GREY

7. EXTERIOR HIGH DENSITY FIBRE CEMENT BOARD C/W EASY TRIMS TO MATCH; COLOR: WHITE

8. THERMALLY BROKEN VINYL DOUBLE GLAZED WINDOW

9. ALUMINIUM GUARDRAILS WITH GLASS PANEL COLOR: CLEAR GLASS 10. ALUMINUM WITH GLASS PARTION, 6'-0" HIGH

11. ENCLOSURE FENCE - BANKER WIRE TXZ-3

12. WINDOW WALL SYSTEM WITH LOW-E GLASS WITH GREEN TINT

13. SPANDREL GLASS PANEL; COLOR: GREY

14. CONCRETE SAND BLASTED FINISH

15. SOPREMA SPOPRASTAR HIGH ALBEDO ROOF WITH SRI VALUE OF .82

16. EXTERIOR HIGH DENSITY FIBRE CEMENT BOARD SIDINGTO MATCH; COLOR: GREY

17. EXTERIOR HIGH DENSITY FIBRE CEMENT BOARD SIDING TO MATCH; COLOR: WHITE

18. METAL PANEL; COLOR: COOPER TONE

19. METAL PANEL; COLOR: DARK BROWN WOOD PANEL



Unit 209-6321 King George Blvd Surrey BC, V3X 1G1 www.flatarchitecture.ca

ARCHITECTURE

Ph: 604-503-4484

ဆွ် ပ PROJECT INFO:
Apartment Building at 13760, 70, 8C 90 13806 101A AVE. SURREY B.C CLIENT:
Amarjeet Ubhi


DATE 29/01/2024

PROJECT NO:

SCALE:						DRAWN BY:			
1" = 30'-0"					U.S.				
						NOTE NO 60	02-02-2009	DATE	
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						ALID BHL OL NOLLYDRAW LNBWIGTBARD	DEVELOPMENT APPLICATION TO THE CITY	мощивова	
						7.0	10	REV	

MATERIAL BOARD



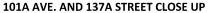





101A AVE. RENTAL BUILDING CLOSE UP

MATERIAL LEGEND:

- CERAMIC BRICK; FINISH: DUAL TONE GREY CLINKER; Size: 238x115x47cm
- 2. METAL PANEL; COLOR: DARK BROWN WOOD SIDDING 3. METAL PANEL; COLOR: WHITE
- 4. METAL PANEL; COLOR: BLACK
- 5. METAL PANEL; COLOR: GREY
- 6. EXTERIOR HIGH DENSITY FIBRE CEMENT BOARD C/W EASY TRIMS TO MATCH; COLOR: GREY
- 7. EXTERIOR HIGH DENSITY FIBRE CEMENT BOARD C/W EASY TRIMS TO MATCH; COLOR: WHITE
- 8. THERMALLY BROKEN VINYL DOUBLE GLAZED WINDOW
- 9. ALUMINIUM GUARDRAILS WITH GLASS PANEL COLOR: CLEAR GLASS
- 10. ALUMINUM WITH GLASS PARTION, 6'-0" HIGH 11. ENCLOSURE FENCE BANKER WIRE TXZ-3
- 12. WINDOW WALL SYSTEM WITH LOW-E GLASS WITH GREEN TINT
- 13. SPANDREL GLASS PANEL; COLOR: GREY
- 14. CONCRETE SAND BLASTED FINISH
- 15. SOPREMA SPOPRASTAR HIGH ALBEDO ROOF WITH SRI VALUE OF .82
- 16. EXTERIOR HIGH DENSITY FIBRE CEMENT BOARD SIDINGTO MATCH; COLOR: GREY
- 17. EXTERIOR HIGH DENSITY FIBRE CEMENT BOARD SIDING TO MATCH; COLOR: WHITE
- 18. METAL PANEL; COLOR: COOPER TONE
- 19. METAL PANEL; COLOR: DARK BROWN WOOD PANEL



Unit 209- 6321 King George Blvd Surrey BC, V3X 1G1 www.flatarchitecture.ca contact@flatarchitecture.ca

Ph: 604-503-4484

PROJECT INFO:
Apartment Building at 13760, 70, 80, 90 13806 101A AVE. SURREY B.C. CLIENT:
Amarjeet Ubhi

DATE 29/01/2024

PROJECT NO: 22-238

SCALE: DRAWN BY: U.S.


MATERIAL BOARD

A 017

101A AVE. TOWER BUILDING CLOSE UP

N.T.S.

3

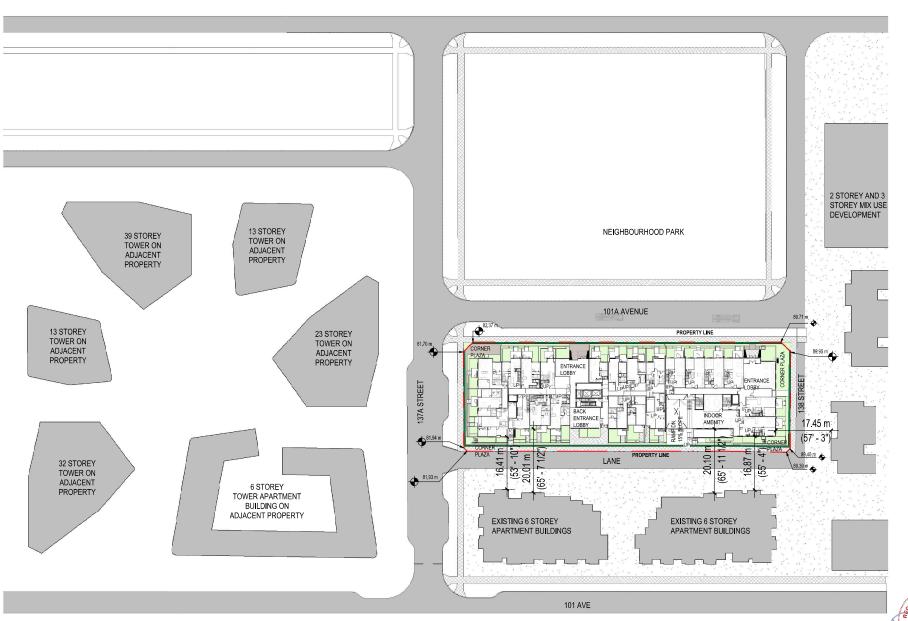



ARCHITECTURE ISC.

Unit 209-6321 King George Blvd Surrey BC, V3X 1G1 www.flatarchitecture.ca contact@flatarchitecture.ca

Ph: 604-503-4484

PROJECT INFO:
Apartment Building at 13760, 70, 80, 90 13806 101A AVE. SURREY B.C. CLIENT:
Amajeet Ubhi


DATE 29/01/2024

PROJECT NO: 22-238

SCALE: DRAWN BY: 1/64" = 1'-0" U.S.

1/64	•=	1'-0'	L	ı.S.			
				09-04-2024	02-02-2024	DATE	
				us.	us.	84	
				DEVELOPMENT APPLICATION TO THE CITY	DEVELOPMENT APPLICATION TO THE CITY	DESCRIPTION	
				7.0	10	REV	

CONTEXT PLAN

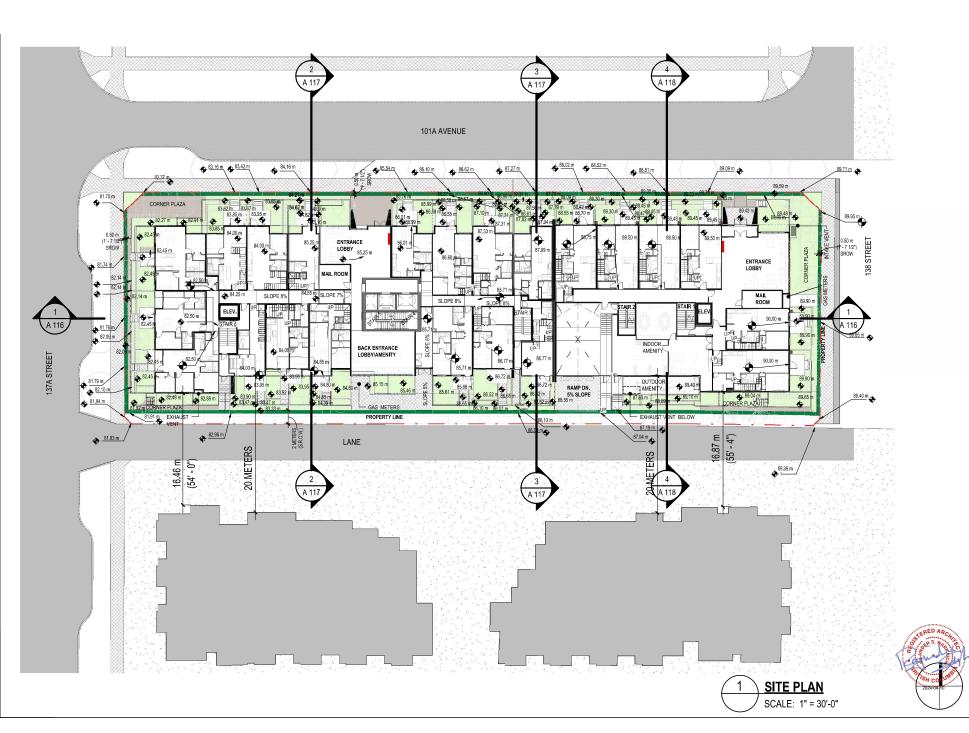

ARCHITECTURE

Unit 209-6321 King George Blvd Surrey BC, V3X 1G1 www.flatarchitecture.ca contact@flatarchitecture.ca

Ph: 604-503-4484

PROJECT INFO:
Apartment Building at 13760, 70, 80, 90 13806 101A AVE. SURREY B.C. CLIENT:
Amarjeet Ubhi


29/01/2024 PROJECT NO: 22-238

DATE

SCALE: DRAWN BY:

1" =	30'-	0*	L	ı.S.		
				09-04-2024	02-02-2024	DATE
				u.s.	us.	84
				DEVELOPMENT APPLICATION TO THE CITY	DEVELOPMENT APPLICATION TO THE CITY	DESCRIPTION
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SITE PLAN

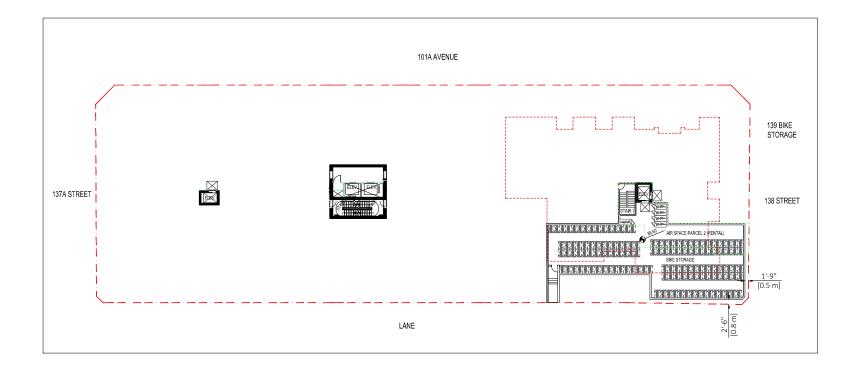

ARCHITECTURE S

Unit 209-6321 King George Blv Surrey BC, V3X 1G1 www.flatarchitecture.ca contact@flatarchitecture.ca

Ph: 604-503-4484

PROJECT INFO:
Apartment Building at 13760, 70, 80, 90 13806 101A AVE. SURREY B.C. CLIENT:
Amarieet Ubhi


DATE 05/02/23


PROJECT NO: 22-238 SCALE:

DRAWN BY: U.S.



U/G PARKADE UPPER

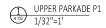

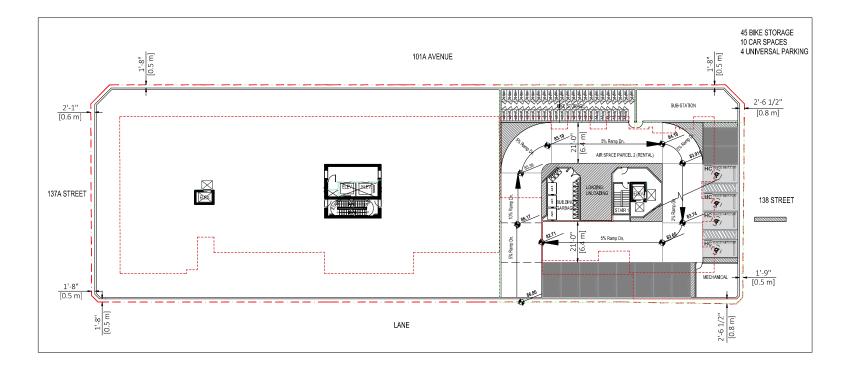

ARCHITECTURE S

Unit 209- 6321 King George Blv Surrey BC, V3X 1G1 www.flatarchitecture.ca contact@flatarchitecture.ca

Ph: 604-503-4484


Apartment Building at 13760, 70, 80, 90 13806 101A AVE. SURREY B.C. CLIENT:
Amarjeet Ubhi

DATE 05/02/23

PROJECT NO: 22-238 SCALE:

DRAWN BY: U.S.

U/G PARKADE P1

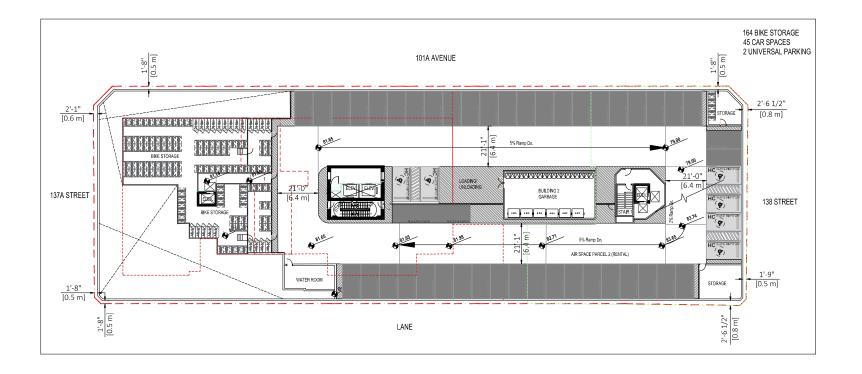



Unit 209- 6321 King George Blv Surrey BC, V3X 1G1 www.flatarchitecture.ca contact@flatarchitecture.ca

Ph: 604-503-4484

PROJECT INFO:
Apartment Building at 13760, 70, 80, 90 13806 101A AVE. SURREY B.C. CLIENT:
Amarjeet Ubhi

DATE 05/02/23 PROJECT NO: 22-238


SCALE: DRAWN BY:



U/G PARKADE P2

A 104

PARKADE P2 1/32"=1'

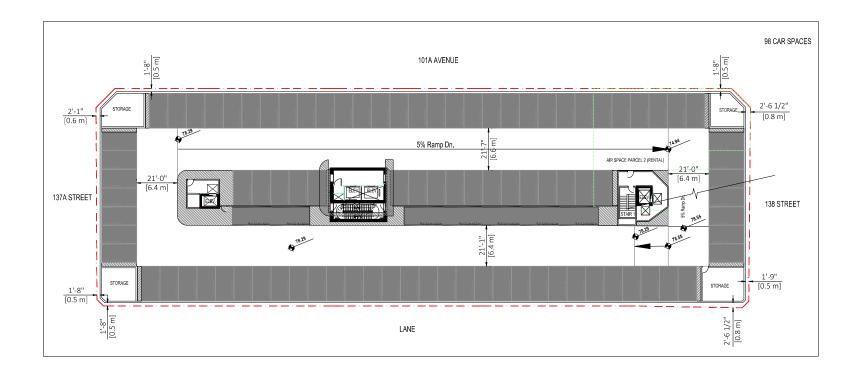

ARCHITECTURE S

Unit 209-6321 King George Blv Surrey BC, V3X 1G1 www.flatarchitecture.ca contact@flatarchitecture.ca

Ph: 604-503-4484

PROJECT INFO:
Apartment Building at 13760, 70, 80, 90 13806 101A AVE. SURREY B.C. CLIENT:
Amarieet Ubhi

DATE 05/02/23

PROJECT NO: 22-238

SCALE: DRAWN BY: U.S.




U/G PARKADE P3

A 105

PARKADE P3

1/32"=1'



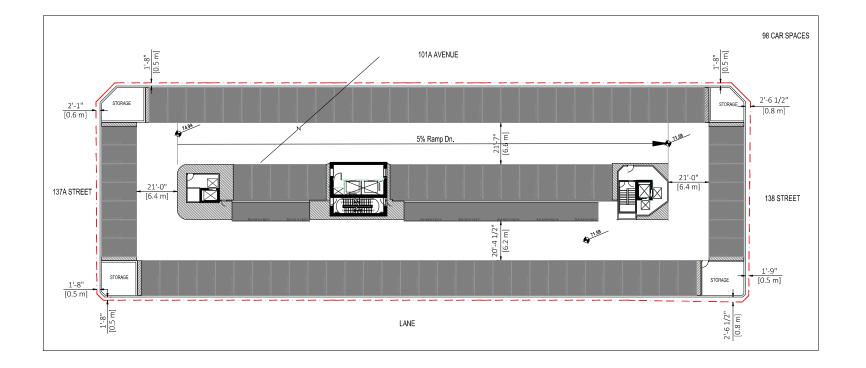



Ph: 604-503-4484

PROJECT INFO:
Apartment Building at 13760, 70, 80, 90 13806 101A AVE. SURREY B.C. CLIENT:
Amarjeet Ubhi

DATE 05/02/23

PROJECT NO: 22-238


SCALE: DRAWN BY:

R.W.

U/G PARKADE P4

A 106

PARKADE P4
1/32"=1'

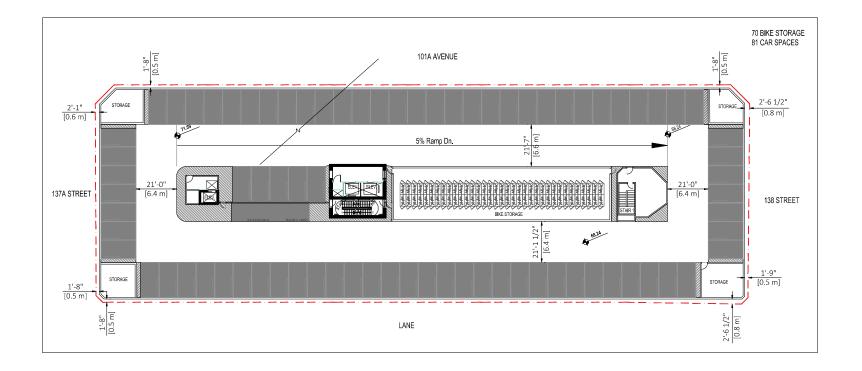

ARCHITECTURE S

Unit 209- 6321 King George Blv Surrey BC, V3X 1G1 www.flatarchitecture.ca contact@flatarchitecture.ca

Ph: 604-503-4484

PROJECT INFO:
Apartment Building at 13760, 70, 80, 90 13806 101A AVE. SURREY B.C. CLIENT:
Amarieet Ubhi


DATE 05/02/23

PROJECT NO: 22-238

SCALE: DRAWN BY:



U/G PARKADE P5

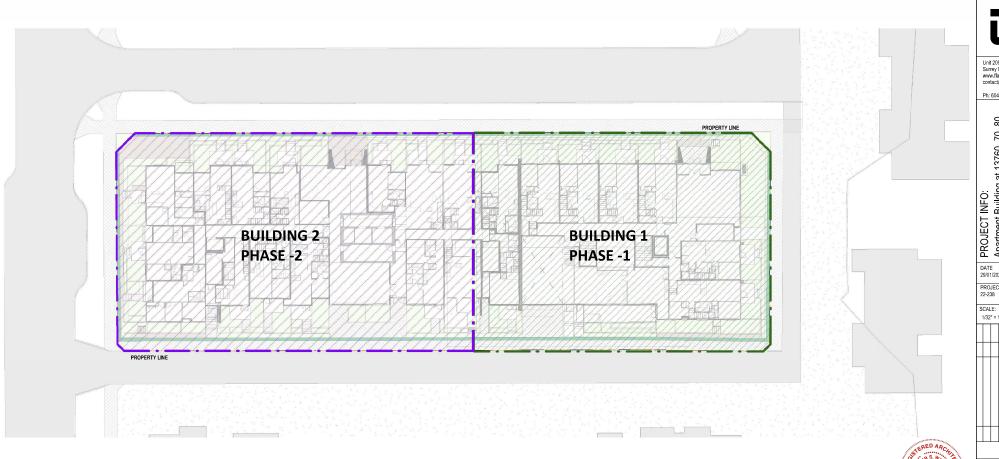



Ph: 604-503-4484

Apartment Building at 13760, 70, 80, 90 13806 101A AVE. SURREY B.C. CLIENT:
Amarjeet Ubhi

DATE 29/01/2024

PROJECT NO: 22-238

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	REV	10	70					

PHASING PLAN

PHASING PLAN SCALE: 1/32" = 1'-0"



ARCHITECTURE

Unit 209-6321 King George Blvd Surrey BC, V3X 1G1 www.flatarchitecture.ca contact@flatarchitecture.ca

Ph: 604-503-4484

PROJECT INFO:
Apartment Building at 13760, 70, 80, 90 13806 101A AVE. SURREY B.C. CLIENT:
Amarjeet Ubhi


DATE 29/01/2024

PROJECT NO: 22-238

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	1" =	30'-	0*	F	.W.		
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FIRE PLAN



ARCHITECTURE

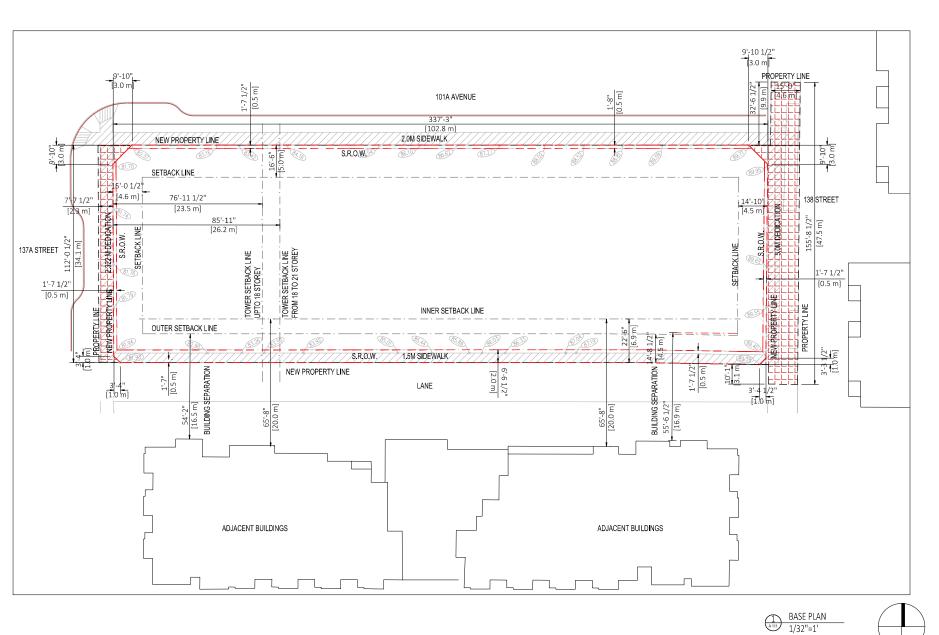Unit 209-6321 King George Blv Surrey BC, V3X 1G1 www.flatarchitecture.ca contact@flatarchitecture.ca

Ph: 604-503-4484

PROJECT INFO:
Apartment Building at 13760, 70, 80, 90 13806 101A AVE. SURREY B.C. CLIENT:
Amarjeet Ubhi

DATE 05/02/23

PROJECT NO: 22-238

DRAWN BY: SCALE: U.S.



BASE PLAN



ARCHITECTURE 2

Unit 209-6321 King George Blvd Surrey BC, V3X 1G1 www.flatarchitecture.ca contact@flatarchitecture.ca

Ph: 604-503-4484

PROJECT INFO:
Apartment Building at 13760, 70, 80, 90 13806 101A AVE. SURREY B.C. CLIENT:
Amarjeet Ubhi

DATE 29/01/2024

PROJECT NO:

22-238

SCALE: DRAWN BY:

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				ALID BHL OL NOLLYDRAW LNBWIGTBARG	DEVELOPMENT APPLICATION TO THE CITY	NOLLHEDSEG	
				0.2	10	REV	

SITE ELEVATION

A 112

ELEVATION - 101A AVENUE(NORTH)

SCALE: 1/32" = 1'-0"



KEY PLAN

Unit 209-6321 King George Blvd Surrey BC, V3X 1G1 www.flatarchitecture.ca contact@flatarchitecture.ca

Ph: 604-503-4484

Apartment Building at 13760, 70, 80, 90 13806 101A AVE. SURREY B.C. CLIENT:
Amarjeet Ubhi

DATE 29/01/2024

PROJECT NO: 22-238

SCALE: DRAWN BY:

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					09-04-2024	02-02-2024	DATE	
					us.	us.	84	
					ALID BHL OL NOLLYDRAW LNBWIGTBARG	DEVELOPMENT APPLICATION TO THE CITY	NOLLHEDSEG	
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SITE ELEVATION

A 113

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-

ELEVATION - 138 STREET (EAST)

SCALE: 1/32" = 1'-0"





KEY PLAN



Unit 209-6321 King George Blvd Surrey BC, V3X 1G1 www.flatarchitecture.ca contact@flatarchitecture.ca

Ph: 604-503-4484

PROJECT INFO:
Apartment Building at 13760, 70, 80, 90 13806 101A AVE. SURREY B.C. CLIENT:
Amarjeet Ubhi

DATE 29/01/2024

PROJECT NO:

22-238

SCALE: DRAWN BY:


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					NOTE NO 60	02-02-2009	DATE
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					DEVELOPMENT APPLICATION TO THE CITY	DEVELOPMENT APPLICATION TO THE CITY	DESCRIPTION
					0.2	01	REV

SITE ELEVATION

A 114

ELEVATION - LANE (SOUTH) 1/32" = 1'-0" A 114



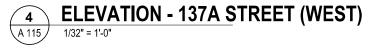



KEY PLAN



Unit 209-6321 King George Blvd Surrey BC, V3X 1G1 www.flatarchitecture.ca contact@flatarchitecture.ca

Ph: 604-503-4484

Apartment Building at 13760, 70, 80, 90 13806 101A AVE. SURREY B.C. CLIENT:
Amarjeet Ubhi


DATE 29/01/2024

PROJECT NO: 22-238

SCALE: DRAWN BY:

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					us.	us.	84
					ALLO BHE OT NOTICE DAY THE CITY	DEVELOPMENT APPLICATION TO THE CITY	DESCRIPTION
					20	10	NEW MEA

SITE ELEVATION

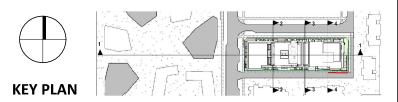



WHALLEY BLVD.



ARCHITECTURE

Unit 209-6321 King George Blvd Surrey BC, V3X 1G1 www.flatarchitecture.ca contact@flatarchitecture.ca

Ph: 604-503-4484

PROJECT INFO:
Apartment Building at 13760, 70, 80
90 13806 101A AVE. SURREY B.C.
CLIENT:
Amarjeet Ubhi


DATE 29/01/2024

PROJECT NO: 22-238


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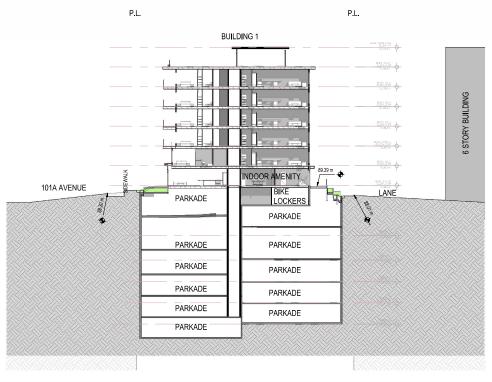
As indicated

SITE SECTION



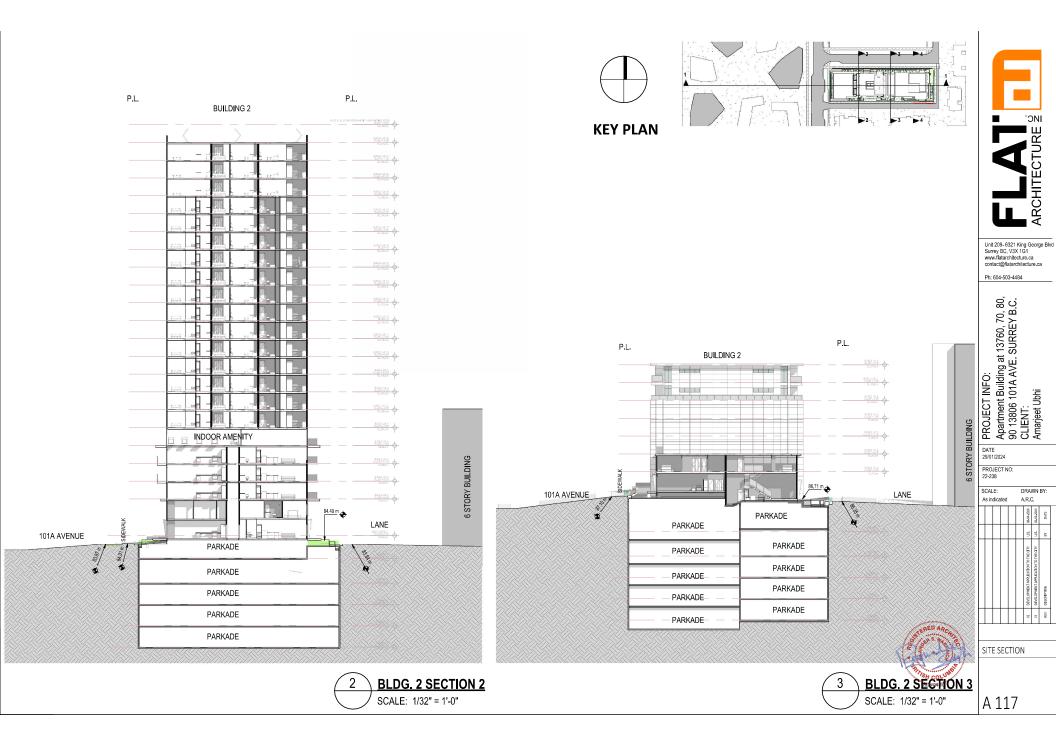



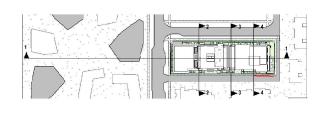

BLDG. 1 SECTION 4 SCALE: 1/32" = 1'-0"



Ph: 604-503-4484

Apartment Building at 13760, 70, 80, 90 13806 101A AVE. SURREY B.C. CLIENT:
Amarjeet Ubhi


DATE 29/01/2024

PROJECT NO: 22-238

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					09-04-2024	02-02-2024	DATE
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					7.0	10	MEV

SITE SECTION

101A AVENUE

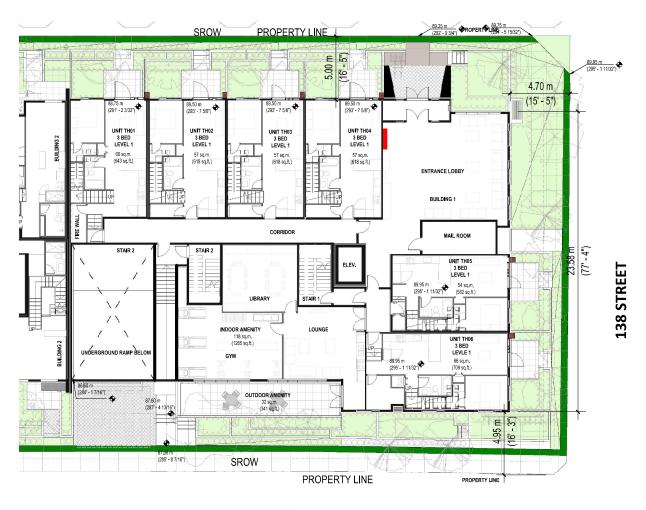

LANE





Apartment Building at 13760, 70, 80, 90 13806 101A AVE. SURREY B.C. CLIENT:
Amarjeet Ubhi


PROJECT NO: 22-238

SCALE: DRAWN BY

| DRAWN BY: 1/40" | 200 | 4.6 | 924.00030 | 63 | 1/40" | 1/40" 
BUILDING 1 LEVEL 1 FLOOR PLAN



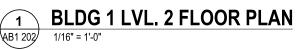



Ph: 604-503-4484

Apartment Building at 13760, 70, 80, 90 13806 101A AVE. SURREY B.C. CLIENT:
Amarjeet Ubhi

DATE 29/01/2024


PROJECT NO: 22-238

SCALE: DRAWN BY:



BUILDING 1 LEVEL 2 FLOOR PLAN

101A AVENUE

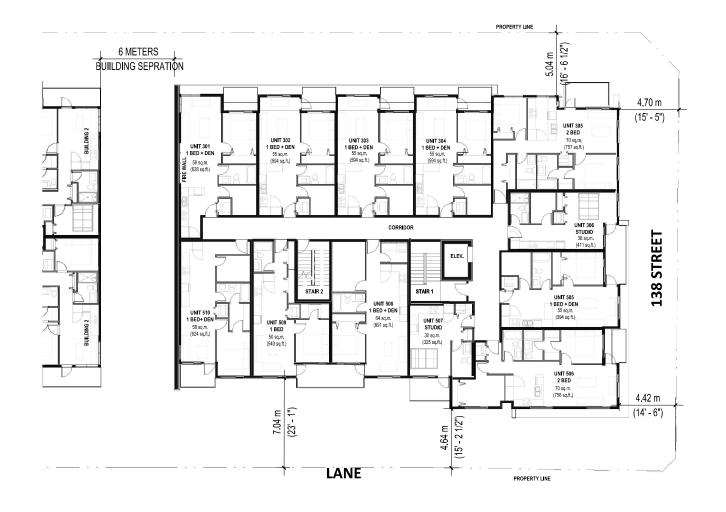



BLDG 1 LEVEL 3 TO LEVEL FLOOR PLAN

1/16" = 1'-0"



Unit 209-6321 King George Blvd Surrey BC, V3X 1G1 www.flatarchitecture.ca contact@flatarchitecture.ca

Ph: 604-503-4484

PROJECT INFO:
Apartment Building at 13760, 70, 80, 90 13806 101A AVE. SURREY B.C. CLIENT:
Amarjeet Ubhi


DATE 29/01/2024

PROJECT NO: 22-238

SCALE: DRAWN BY:

1/16" = 1'-0" U.S.

BUILDING 1 LEVEL 3 TO LEVEL 4 FLOOR PLAN

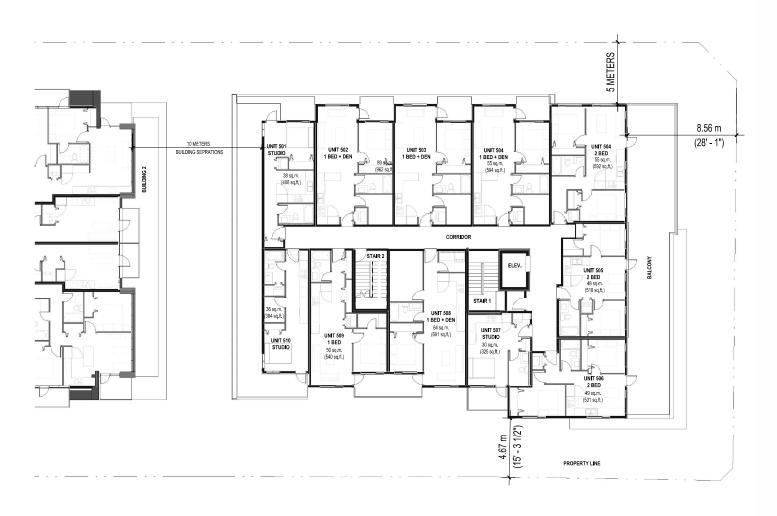



BLDG 1 LVL. 5 FLOOR PLAN
1/16" = 1'-0"





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Ph: 604-503-4484


Apartment Building at 13760, 70, 80, 90 13806 101A AVE. SURREY B.C. CLIENT:
Amarjeet Ubhi


DATE 29/01/2024

PROJECT NO: 22-238

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				ALID BHL OL NOLLYDRAW LNBWIGTBARG	DEVELOPMENT APPLICATION TO THE CITY	NOLLABORRION
				0.2	01	REV

BUILDING 1 LEVEL 5 FLOOR PLAN

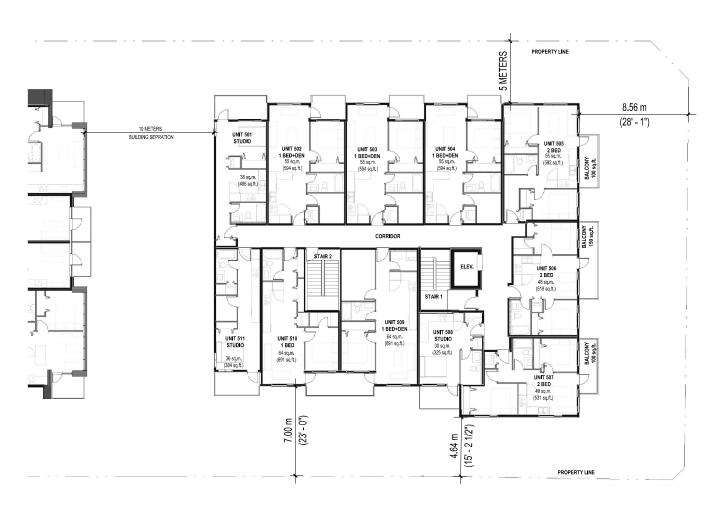

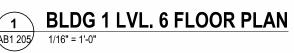



Ph: 604-503-4484

Apartment Building at 13760, 70, 80, 90 13806 101A AVE. SURREY B.C. CLIENT:
Amarjeet Ubhi


DATE 29/01/2024

PROJECT NO: 22-238

SCALE: DRAWN BY:

1/16" = 1'-0" U.S.

BUILDING 1 LEVEL 6 FLOOR PLAN

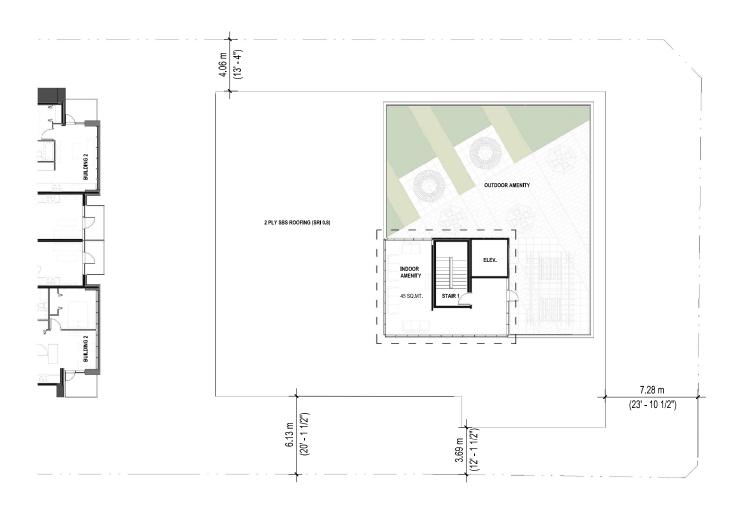



Ph: 604-503-4484

Apartment Building at 13760, 70, 80, 90 13806 101A AVE. SURREY B.C. CLIENT:
Amarjeet Ubhi

DATE 29/01/2024


PROJECT NO: 22-238

SCALE: DRAWN BY: 1/16" = 1'-0" U.S.




BUILDING 1 LEVEL 7 FLOOR PLAN



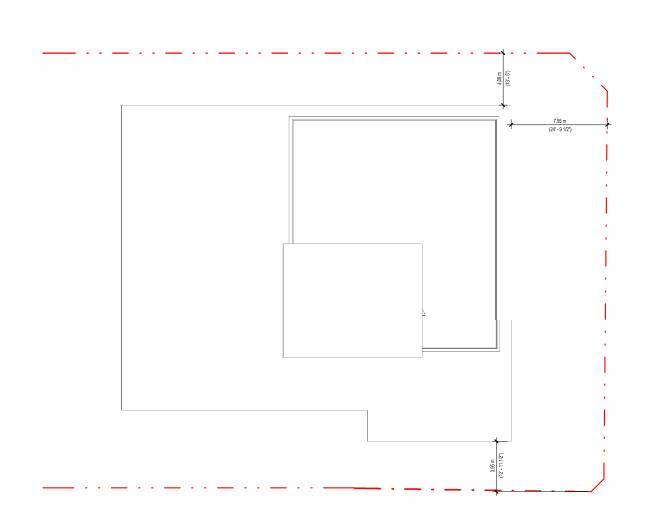

1 AB1 207

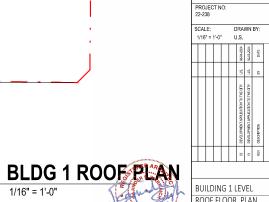

ARCHITECTURE S


Unit 209-6321 King George Blvd Surrey BC, V3X 1G1 www.flatarchitecture.ca contact@flatarchitecture.ca

Ph: 604-503-4484

Apartment Building at 13760, 70, 80, 90 13806 101A AVE. SURREY B.C. CLIENT:
Amarjeet Ubhi

DATE 29/01/2024

BUILDING 1 LEVEL ROOF FLOOR PLAN

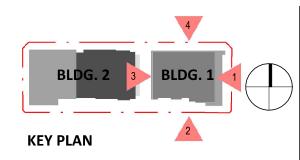

MATERIAL LEGEND:

1. CERAMIC BRICK; FINISH: DUAL TONE GREY CLINKER; Size: 238x115x47cm

2. METAL PANEL; COLOR: DARK BROWN WOOD SIDDING

3. METAL PANEL; COLOR: WHITE

4. METAL PANEL; COLOR: BLACK

5. METAL PANEL; COLOR: GREY

6. EXTERIOR HIGH DENSITY FIBRE CEMENT BOARD C/W EASY TRIMS TO MATCH; COLOR: GREY

7. EXTERIOR HIGH DENSITY FIBRE CEMENT BOARD C/W EASY TRIMS TO MATCH; COLOR: WHITE

8. THERMALLY BROKEN VINYL DOUBLE GLAZED WINDOW

9. ALUMINIUM GUARDRAILS WITH GLASS PANEL COLOR: CLEAR GLASS

10. ALUMINUM WITH GLASS PARTION, 6'-0" HIGH

11. ENCLOSURE FENCE - BANKER WIRE TXZ-3

12. WINDOW WALL SYSTEM WITH LOW-E GLASS WITH GREEN TINT

13. SPANDREL GLASS PANEL; COLOR: GREY

14. CONCRETE SAND BLASTED FINISH

15. SOPREMA SPOPRASTAR HIGH ALBEDO ROOF WITH SRI VALUE OF .82

16. EXTERIOR HIGH DENSITY FIBRE CEMENT BOARD SIDINGTO MATCH; COLOR: GREY

17. EXTERIOR HIGH DENSITY FIBRE CEMENT BOARD SIDING TO MATCH; COLOR: WHITE

18. METAL PANEL; COLOR: COOPER TONE

19. METAL PANEL; COLOR: DARK BROWN WOOD PANEL

PROJECT INFO:
Apartment Building at 13760, 70, 80
90 13806 101A AVE. SURREY B.C
CLIENT:
Amarjeet Ubhi DATE 29/01/2024

PROJECT NO:

SCALE: DRAWN BY: U.S. As indicated


ARCHITECTURE

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Ph: 604-503-4484

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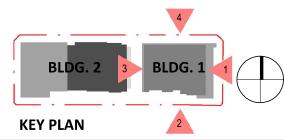
BUILDING 1 ELEVATION





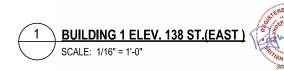

SCALE: 1/16" = 1'-0"



1. CERAMIC BRICK; FINISH: DUAL TONE GREY CLINKER; Size: 238x115x47cm 2. METAL PANEL; COLOR: DARK BROWN WOOD SIDDING

3. METAL PANEL; COLOR: WHITE 4. METAL PANEL; COLOR: BLACK

5. METAL PANEL; COLOR: GREY

6. EXTERIOR HIGH DENSITY FIBRE CEMENT BOARD C/W EASY TRIMS TO MATCH;

7. EXTERIOR HIGH DENSITY FIBRE CEMENT BOARD C/W EASY TRIMS TO MATCH; COLOR: WHITE

8. THERMALLY BROKEN VINYL DOUBLE GLAZED WINDOW

9. ALUMINIUM GUARDRAILS WITH GLASS PANEL COLOR: CLEAR GLASS

10. ALUMINUM WITH GLASS PARTION, 6'-0" HIGH

11. ENCLOSURE FENCE - BANKER WIRE TXZ-3

12. WINDOW WALL SYSTEM WITH LOW-E GLASS WITH GREEN TINT

13. SPANDREL GLASS PANEL; COLOR: GREY

14. CONCRETE SAND BLASTED FINISH

15. SOPREMA SPOPRASTAR HIGH ALBEDO ROOF WITH SRI VALUE OF .82

16. EXTERIOR HIGH DENSITY FIBRE CEMENT BOARD SIDINGTO MATCH; COLOR: GREY

17. EXTERIOR HIGH DENSITY FIBRE CEMENT BOARD SIDING TO MATCH; COLOR: WHITE

18. METAL PANEL; COLOR: COOPER TONE

19. METAL PANEL; COLOR: DARK BROWN WOOD PANEL

ARCHITECTURE

Unit 209-6321 King George Blvd Surrey BC, V3X 1G1 www.flatarchitecture.ca

Ph: 604-503-4484

တ္ထိ ပ PROJECT INFO:
Apartment Building at 13760, 70, 80 90 13806 101A AVE. SURREY B.C. CLIENT:
Amarjeet Ubhi

DATE


29/01/2024 PROJECT NO:

SCALE: DRAWN BY:

As indicated U.S.

BUILDING 1 ELEVATION



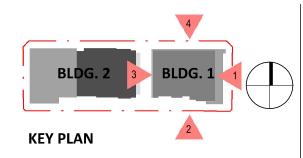



BUILDING 1 ELEVATION FIRE WALL(WEST)

SCALE: 1/16" = 1'-0"



1. CERAMIC BRICK; FINISH: DUAL TONE GREY CLINKER; Size: 238x115x47cm

2. METAL PANEL; COLOR: DARK BROWN WOOD SIDDING

3. METAL PANEL; COLOR: WHITE

4. METAL PANEL; COLOR: BLACK

5. METAL PANEL; COLOR: GREY

6. EXTERIOR HIGH DENSITY FIBRE CEMENT BOARD C/W EASY TRIMS TO MATCH; COLOR: GREY

Y. EXTERIOR HIGH DENSITY FIBRE CEMENT BOARD C/W EASY TRIMS TO MATCH; COLOR: WHITE

8. THERMALLY BROKEN VINYL DOUBLE GLAZED WINDOW

9. ALUMINIUM GUARDRAILS WITH GLASS PANEL COLOR: CLEAR GLASS

10. ALUMINUM WITH GLASS PARTION, 6'-0" HIGH

11. ENCLOSURE FENCE - BANKER WIRE TXZ-3

12. WINDOW WALL SYSTEM WITH LOW-E GLASS WITH GREEN TINT

13. SPANDREL GLASS PANEL; COLOR: GREY

14. CONCRETE SAND BLASTED FINISH

15. SOPREMA SPOPRASTAR HIGH ALBEDO ROOF WITH SRI VALUE OF .82

16. EXTERIOR HIGH DENSITY FIBRE CEMENT BOARD SIDINGTO MATCH; COLOR: GREY

17. EXTERIOR HIGH DENSITY FIBRE CEMENT BOARD SIDING TO MATCH; COLOR: WHITE

18. METAL PANEL; COLOR: COOPER TONE

19. METAL PANEL; COLOR: DARK BROWN WOOD PANEL



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Ph: 604-503-4484


PROJECT INFO:
Apartment Building at 13760, 70, 80
90 13806 101A AVE. SURREY B.C
CLIENT:
Amarjeet Ubhi DATE

29/01/2024 PROJECT NO:

SCALE: DRAWN BY: U.S.

As indicated

BUILDING 1 ELEVATION

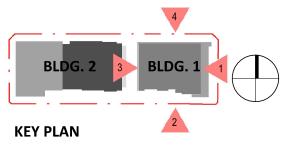

PL 09 2 16 1

MATERIAL LEGEND:

1. CERAMIC BRICK; FINISH: DUAL TONE GREY CLINKER; Size: 238x115x47cm

2. METAL PANEL; COLOR: DARK BROWN WOOD SIDDING

3. METAL PANEL; COLOR: WHITE

4. METAL PANEL; COLOR: BLACK

5. METAL PANEL; COLOR: GREY

6. EXTERIOR HIGH DENSITY FIBRE CEMENT BOARD C/W EASY TRIMS TO MATCH; COLOR: GREY

7. EXTERIOR HIGH DENSITY FIBRE CEMENT BOARD C/W EASY TRIMS TO MATCH; COLOR: WHITE

8. THERMALLY BROKEN VINYL DOUBLE GLAZED WINDOW

9. ALUMINIUM GUARDRAILS WITH GLASS PANEL COLOR: CLEAR GLASS

10. ALUMINUM WITH GLASS PARTION, 6'-0" HIGH

11. ENCLOSURE FENCE - BANKER WIRE TXZ-3

12. WINDOW WALL SYSTEM WITH LOW-E GLASS WITH GREEN TINT

13. SPANDREL GLASS PANEL; COLOR: GREY

14. CONCRETE SAND BLASTED FINISH

15. SOPREMA SPOPRASTAR HIGH ALBEDO ROOF WITH SRI VALUE OF .82

16. EXTERIOR HIGH DENSITY FIBRE CEMENT BOARD SIDINGTO MATCH; COLOR: GREY

17. EXTERIOR HIGH DENSITY FIBRE CEMENT BOARD SIDING TO MATCH; COLOR: WHITE

18. METAL PANEL; COLOR: COOPER TONE

19. METAL PANEL; COLOR: DARK BROWN WOOD PANEL

ARCHITECTURE

Unit 209-6321 King George Blvd Surrey BC, V3X 1G1 www.flatarchitecture.ca

Ph: 604-503-4484

PROJECT INFO:
Apartment Building at 13760, 70, 8C 90 13806 101A AVE. SURREY B.C CLIENT:
Amarjeet Ubhi

DATE 29/01/2024

PROJECT NO:

SCALE: DRAWN BY:


As indicated U.S.

BUILDING 1 ELEVATION

AB1 304

BUILDING 1 ELEV. 101A AVENUE(NORTH)

SCALE: 1/16" = 1'-0"

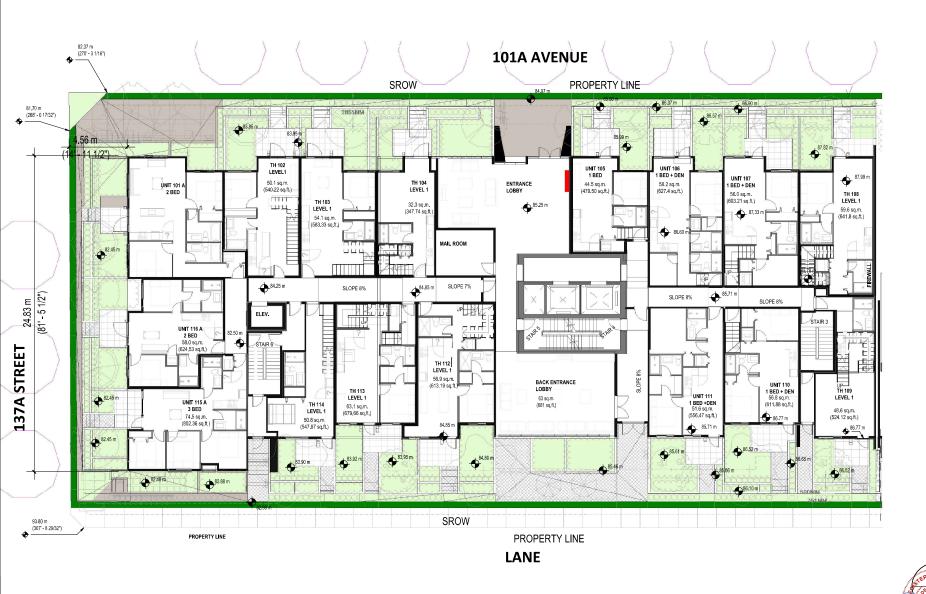





Unit 209-6321 King George Blvd Surrey BC, V3X 1G1 www.flatarchitecture.ca

Ph: 604-503-4484

PROJECT INFO:
Apartment Building at 13760, 70, 80 90 13806 101A AVE. SURREY B.C. CLIENT:
Amarjeet Ubhi

DATE

29/01/2024

PROJECT NO: 22-238

SCALE: DRAWN BY:



BUILDING 2 LEVEL 1

FLOOR PLAN







Ph: 604-503-4484


Apartment Building at 13760, 70, 80, 90 13806 101A AVE. SURREY B.C. CLIENT:
Amarjeet Ubhi

DATE 29/01/2024

PROJECT NO: 22-238

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			08-04-2024	02.02.2024	DATE
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BUILDING 2 LEVEL 2A FLOOR PLAN



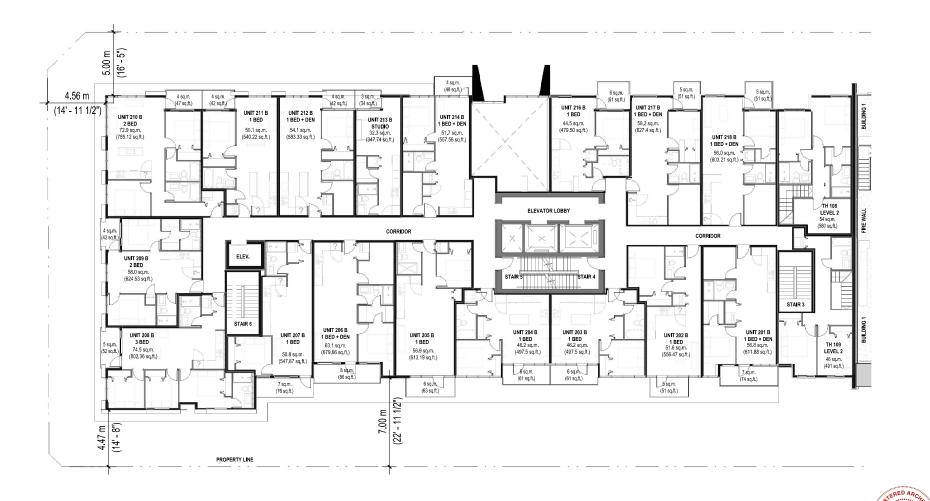

Ph: 604-503-4484

Apartment Building at 13760, 70, 80, 90 13806 101A AVE. SURREY B.C. CLIENT:
Amarjeet Ubhi

DATE 29/01/2024

PROJECT NO:

22-238 SCALE:

DRAWN BY: 1/16" = 1'-0" A.R.C.

BUILDING 2 LEVEL 2

FLOOR PLAN

BLDG 2 LVL. 2 FLOOR PLAN

SCALE: 1/16" = 1'-0"







Ph: 604-503-4484


Apartment Building at 13760, 70, 80, 90 13806 101A AVE. SURREY B.C. CLIENT:
Amarjeet Ubhi

DATE 29/01/2024

PROJECT NO: 22-238

1/16	1'-0'		.R.	O.	BY:
			09-04-2024	02-02-2024	DATE
			u.s.	us.	84
			ALD BHI OL NOLLYDRAW INBINIOTENBO	DEVELOPMENT APPLICATION TO THE CITY	NOLLHEIDEBO
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BUILDING 2 LEVEL 3 TO LEVEL 4 FLOOR PLAN



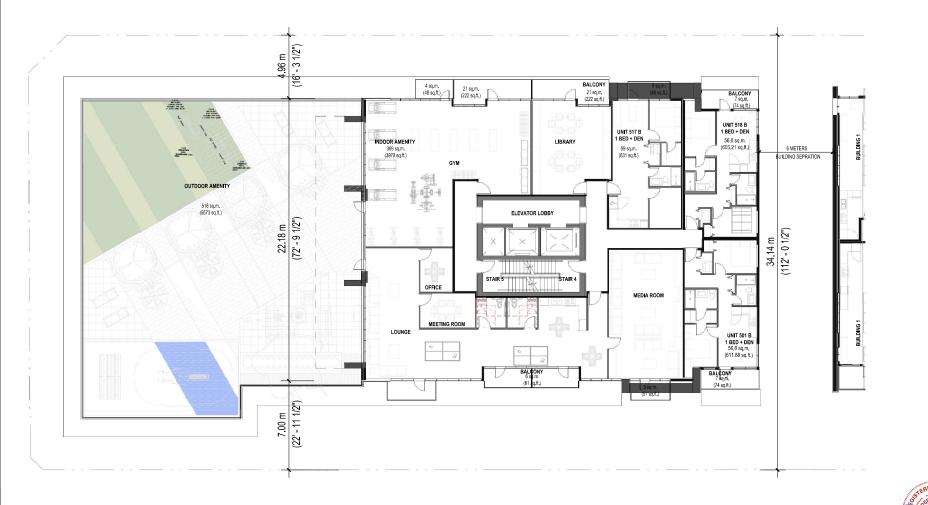

Ph: 604-503-4484

Apartment Building at 13760, 70, 80, 90 13806 101A AVE. SURREY B.C. CLIENT:
Amarjeet Ubhi

DATE 29/01/2024 PROJECT NO: 22-238

SCALE: DRAWN BY:

•	1/16	•=	1'-0'	'	Α	.R.0	С.		
						03-04-2024	02.02.2004	DATE	
						us.	us.	84	
						ALID BHL OL NOLLYDRAW LNBWIGTBARD	DEVELOPMENT APPLICATION TO THE CITY	NOLLHEDSEG	
						7.0	10	REV	

BUILDING 2 LEVEL 5 FLOOR PLAN





Ph: 604-503-4484

Apartment Building at 13760, 70, 80, 90 13806 101A AVE. SURREY B.C. CLIENT:
Amarjeet Ubhi

DATE 29/01/2024

PROJECT NO: 22-238


SCALE: DRAWN BY: 1/16" = 1'-0" A.R.C.



BUILDING 2 LEVEL 6 TO LEVEL 18 FLOOR PLAN

AB2 206

TYPICAL BLDG. 2 LVL. 6 TO LVL. 18 FLOOR PLAN SCALE: 1/16" = 1'-0"

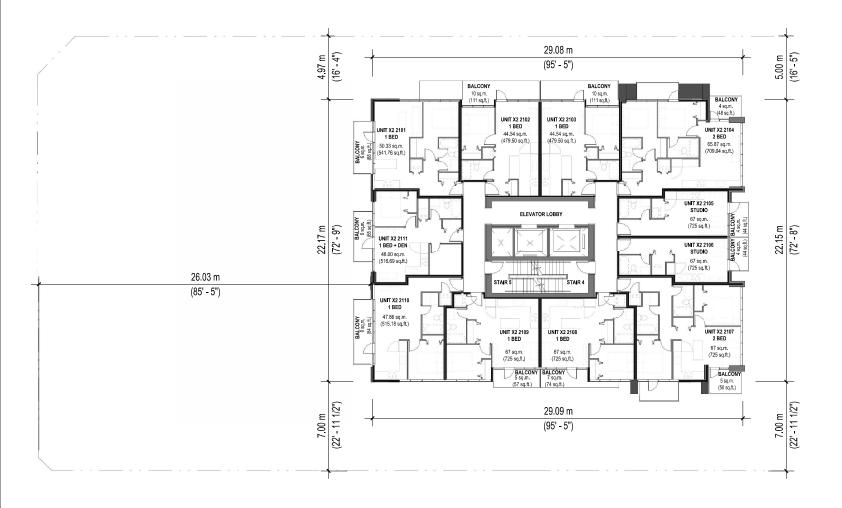

TYPICAL BLDG. 2 LVL. 19 TO LVL. 21 FLOOR PLAN SCALE: 1/16" = 1'-0"



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Ph: 604-503-4484

Apartment Building at 13760, 70, 80, 90 13806 101A AVE. SURREY B.C. CLIENT:
Amarjeet Ubhi


DATE 29/01/2024

PROJECT NO: 22-238

SCALE: DRAWN BY:

1/16" = 1'-0" A.R.C.

BUILDING 2 LEVEL 19 TO 21 FLOOR PLAN

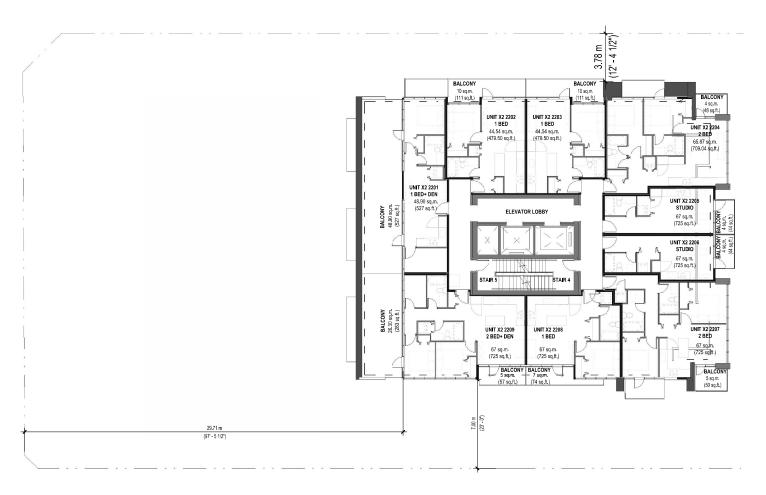



ARCHITECTURE S

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Ph: 604-503-4484

Apartment Building at 13760, 70, 80, 90 13806 101A AVE. SURREY B.C. CLIENT:
Amarjeet Ubhi


DATE 29/01/2024

PROJECT NO: 22-238

SCALE: DRAWN BY:

1/16" = 1'-0" A.R.C.

BUILDING 2 LEVEL 22 FLOOR PLAN

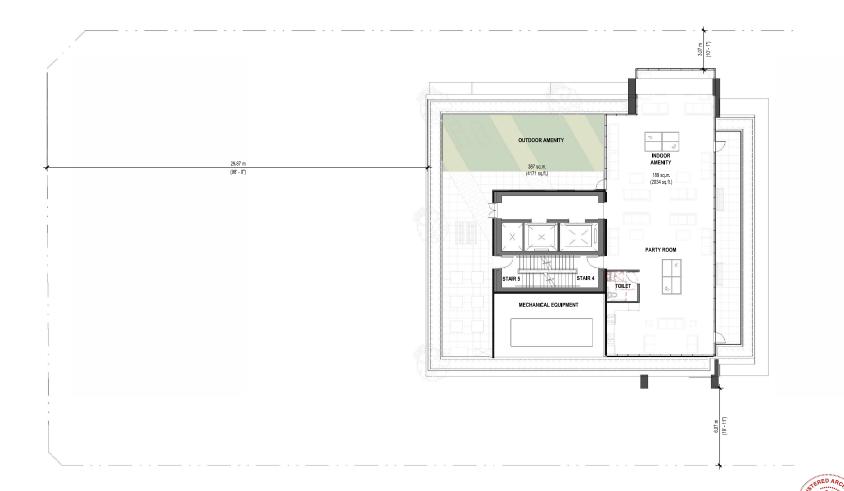

Ph: 604-503-4484

Apartment Building at 13760, 70, 80, 90 13806 101A AVE. SURREY B.C. CLIENT:
Amarjeet Ubhi

DATE 29/01/2024

PROJECT NO: 22-238

SCALE: DRAWN BY:

1/16" = 1'-0" A.R.C.


BUILDING 2 LEVEL 23 OUTDOOR AMENITY FLOOR PLAN

AB2 209



BLDG 2 LVL 23 OUTDOOR AMENITY AND MACHINE ROOM

1/16" = 1'-0"

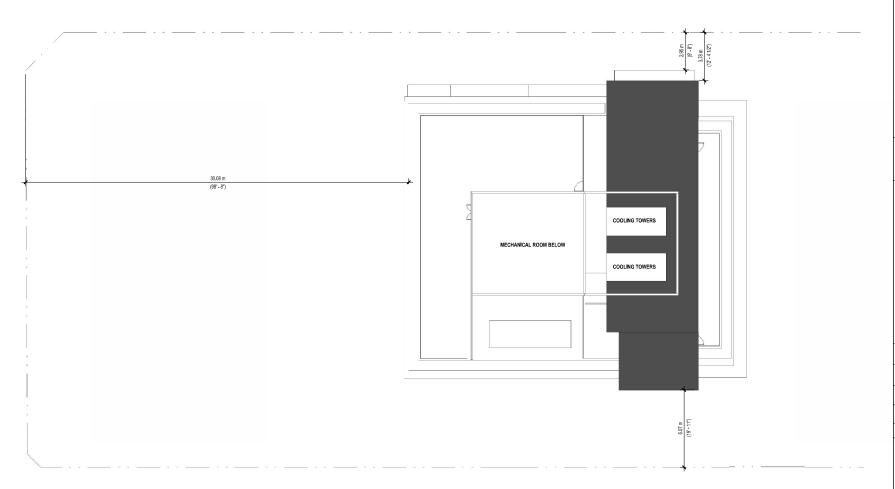





Ph: 604-503-4484

Apartment Building at 13760, 70, 80, 90 13806 101A AVE. SURREY B.C. CLIENT:
Amarjeet Ubhi


DATE 29/01/2024


PROJECT NO: 22-238


DRAWN BY:

SCALE: 1/16" = 1'-0" A.R.C.

BUILDING 2 ROOF LEVEL PLAN

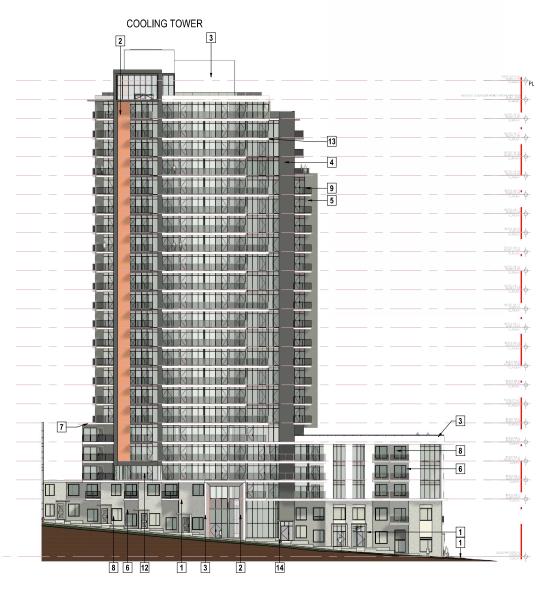

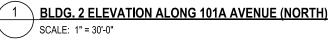

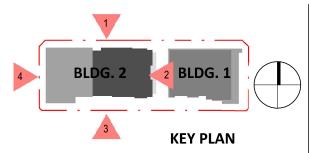

MATERIAL LEGEND:

. CERAMIC BRICK; FINISH: DUAL TONE GREY CLINKER; Size: 238x115x47cm

2. METAL PANEL; COLOR: DARK BROWN WOOD SIDDING

3. METAL PANEL; COLOR: WHITE 4. METAL PANEL; COLOR: BLACK

5. METAL PANEL; COLOR: GREY

6. EXTERIOR HIGH DENSITY FIBRE CEMENT BOARD C/W EASY TRIMS TO MATCH; COLOR: GREY

7. EXTERIOR HIGH DENSITY FIBRE CEMENT BOARD C/W EASY TRIMS TO MATCH; COLOR: WHITE

8. THERMALLY BROKEN VINYL DOUBLE GLAZED WINDOW

9. ALUMINIUM GUARDRAILS WITH GLASS PANEL COLOR: CLEAR GLASS

10. ALUMINUM WITH GLASS PARTION, 6'-0" HIGH

11. ENCLOSURE FENCE - BANKER WIRE TXZ-3

12. WINDOW WALL SYSTEM WITH LOW-E GLASS WITH GREEN TINT

13. SPANDREL GLASS PANEL; COLOR: GREY

14. CONCRETE SAND BLASTED FINISH

15. SOPREMA SPOPRASTAR HIGH ALBEDO ROOF WITH SRI VALUE OF .82

16. EXTERIOR HIGH DENSITY FIBRE CEMENT BOARD SIDINGTO MATCH; COLOR: GREY

17. EXTERIOR HIGH DENSITY FIBRE CEMENT BOARD SIDING TO MATCH; COLOR: WHITE

18. METAL PANEL; COLOR: COOPER TONE

19. METAL PANEL; COLOR: DARK BROWN WOOD PANEL



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Ph: 604-503-4484

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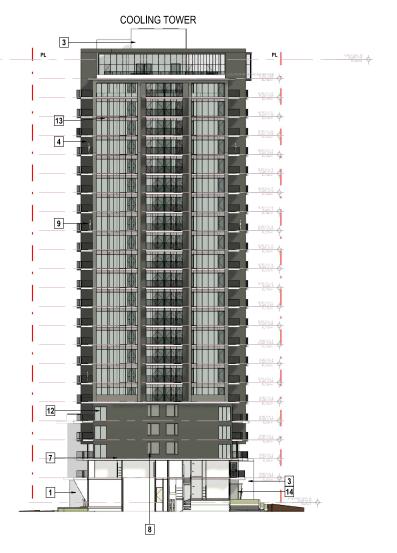
PROJECT INFO:
Apartment Building at 13760, 70, 8C 90 13806 101A AVE. SURREY B.C CLIENT:
Amarjeet Ubhi

DATE 29/01/2024


PROJECT NO: SCALE: DRAWN BY: A.R.C.

As indicated

BUILDING 2 ELEVATION





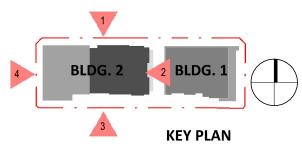

MATERIAL LEGEND:

. CERAMIC BRICK; FINISH: DUAL TONE GREY CLINKER; Size: 238x115x47cm

2. METAL PANEL; COLOR: DARK BROWN WOOD SIDDING

3. METAL PANEL; COLOR: WHITE 4. METAL PANEL; COLOR: BLACK

5. METAL PANEL; COLOR: GREY

6. EXTERIOR HIGH DENSITY FIBRE CEMENT BOARD C/W EASY TRIMS TO MATCH; COLOR: GREY

7. EXTERIOR HIGH DENSITY FIBRE CEMENT BOARD C/W EASY TRIMS TO MATCH; COLOR: WHITE

8. THERMALLY BROKEN VINYL DOUBLE GLAZED WINDOW

9. ALUMINIUM GUARDRAILS WITH GLASS PANEL COLOR: CLEAR GLASS

10. ALUMINUM WITH GLASS PARTION, 6'-0" HIGH

11. ENCLOSURE FENCE - BANKER WIRE TXZ-3

12. WINDOW WALL SYSTEM WITH LOW-E GLASS WITH GREEN TINT

13. SPANDREL GLASS PANEL; COLOR: GREY

14. CONCRETE SAND BLASTED FINISH

15. SOPREMA SPOPRASTAR HIGH ALBEDO ROOF WITH SRI VALUE OF .82

16. EXTERIOR HIGH DENSITY FIBRE CEMENT BOARD SIDINGTO MATCH; COLOR: GREY

17. EXTERIOR HIGH DENSITY FIBRE CEMENT BOARD SIDING TO MATCH; COLOR: WHITE

18. METAL PANEL; COLOR: COOPER TONE

19. METAL PANEL; COLOR: DARK BROWN WOOD PANEL



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Amarjeet Ubhi


DATE 29/01/2024


PROJECT NO:

SCALE: DRAWN BY: A.R.C. As indicated

BUILDING 2 ELEVATION



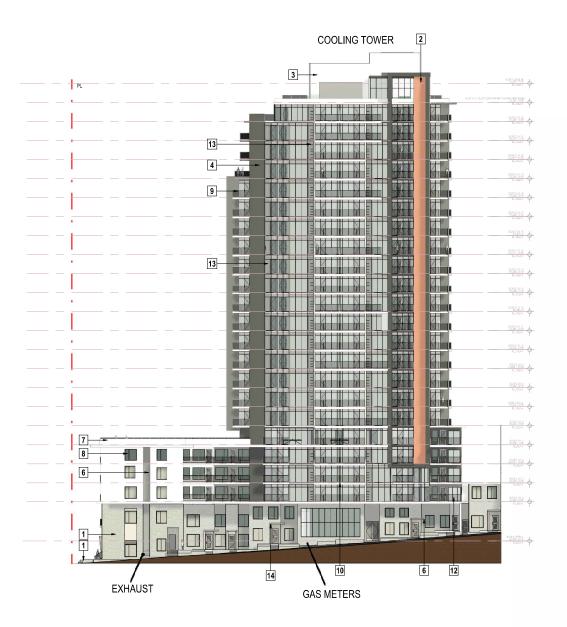

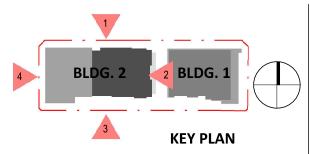

MATERIAL LEGEND:

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2. METAL PANEL; COLOR: DARK BROWN WOOD SIDDING

3. METAL PANEL; COLOR: WHITE

4. METAL PANEL; COLOR: BLACK 5. METAL PANEL; COLOR: GREY

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18. METAL PANEL; COLOR: COOPER TONE

19. METAL PANEL; COLOR: DARK BROWN WOOD PANEL

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PROJECT INFO:
Apartment Building at 13760, 70, 8C 90 13806 101A AVE. SURREY B.C CLIENT:
Amarjeet Ubhi

DATE 29/01/2024

PROJECT NO:

SCALE: DRAWN BY:


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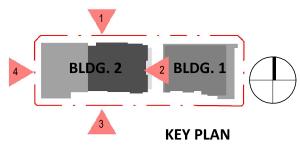
BUILDING 2 ELEVATION

BLDG. 2 LANE ELEVATION (SOUTH)

SCALE: 1" = 30'-0"

AB2 303



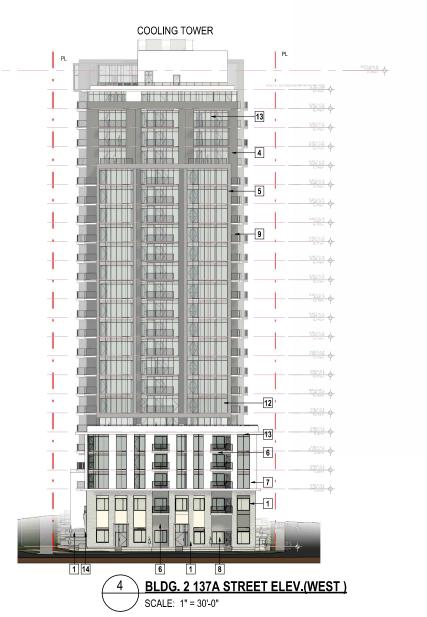

MATERIAL LEGEND:

. CERAMIC BRICK; FINISH: DUAL TONE GREY CLINKER; Size: 238x115x47cm

2. METAL PANEL; COLOR: DARK BROWN WOOD SIDDING

3. METAL PANEL; COLOR: WHITE 4. METAL PANEL; COLOR: BLACK

5. METAL PANEL; COLOR: GREY

6. EXTERIOR HIGH DENSITY FIBRE CEMENT BOARD C/W EASY TRIMS TO MATCH; COLOR: GREY

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Apartment Building at 13760, 70, 8C 90 13806 101A AVE. SURREY B.C CLIENT:
Amarjeet Ubhi

DATE

29/01/2024 PROJECT NO:


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BUILDING 2 ELEVATION

AB2 304





PART SECTION KEY PLAN A 501

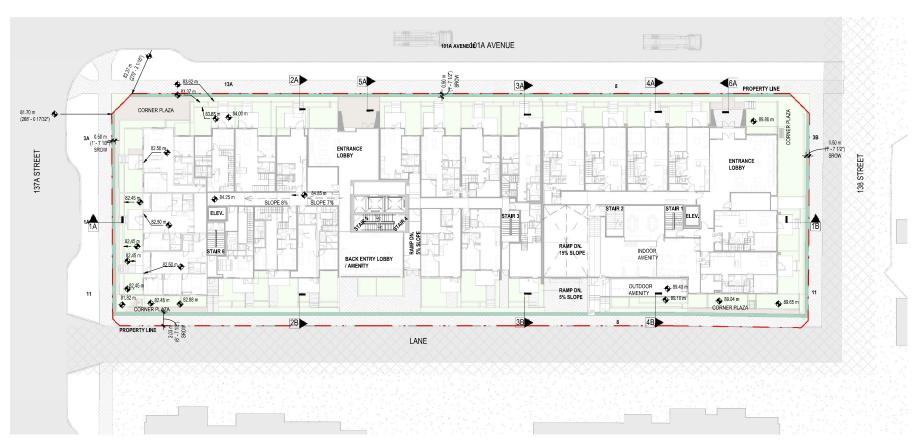1" = 30'-0"



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PROJECT INFO:
Apartment Building at 13760, 70, 80, 90 13806 101A AVE. SURREY B.C. CLIENT:
Amajeet Ubhi


DATE 29/01/2024


PROJECT NO: 22-238

SCALE: DRAWN BY:

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SECTION KEY PLAN



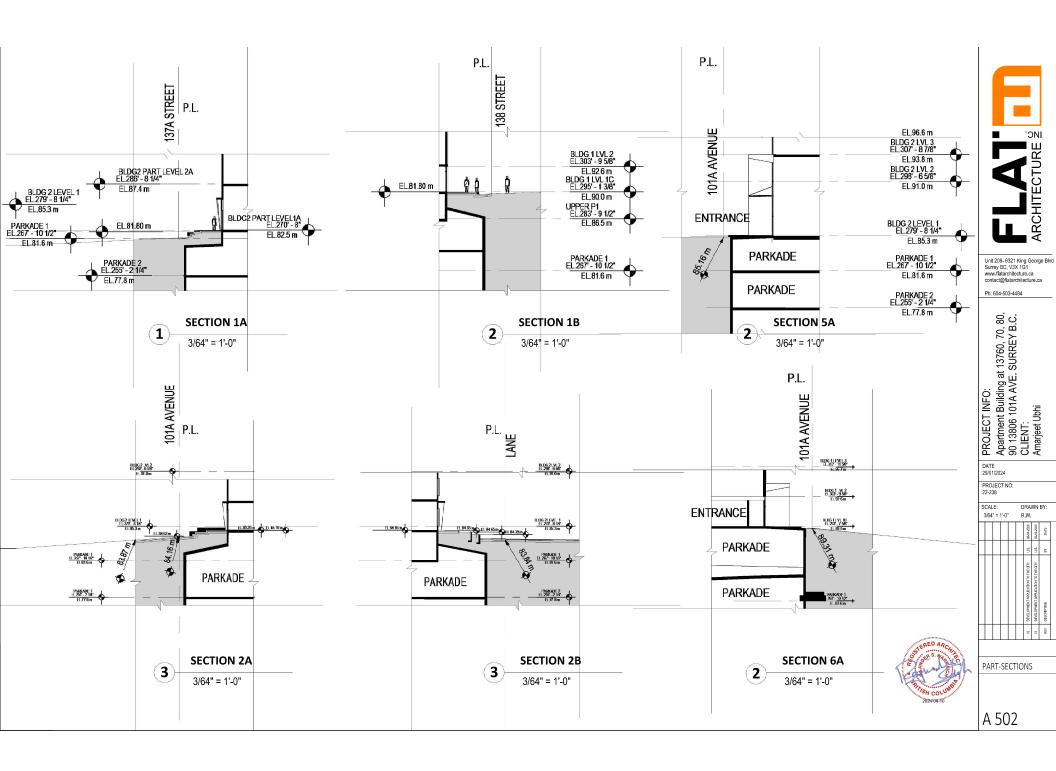

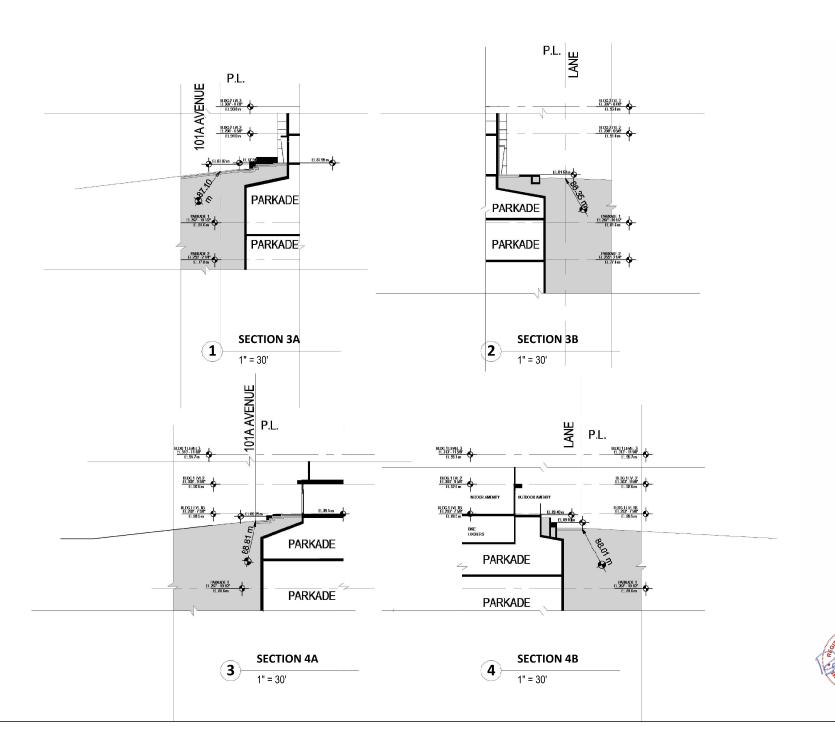

Unit 209-6321 King George Blvd Surrey BC, V3X 1G1 www.flatarchitecture.ca contact@flatarchitecture.ca

Ph: 604-503-4484

Apartment Building at 13760, 70, 80, 90 13806 101A AVE. SURREY B.C. CLIENT:
Amarjeet Ubhi

DATE 29/01/2024 PROJECT NO: 22-238

SCALE: DRAWN BY:

3/64" = 1"-0"

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 08-04-2524	us.	ALID BHL OL NOLLYOTH AV LINBINGOTENED	20

PART-SECTIONS



BLDG. 1



ARCHITECTURE S

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Ph: 604-503-4484

Apartment Building at 13760, 70, 80, 90 13806 101A AVE. SURREY B.C. CLIENT:
Amarjeet Ubhi

DATE 29/01/2024

PROJECT NO: 22-238

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CONCEPTUAL 3D ILLUSTRATION



BLDG. 2

ARCHITECTURE S

Unit 209-6321 King George Blvd Surrey BC, V3X 1G1 www.flatarchitecture.ca contact@flatarchitecture.ca

Ph: 604-503-4484

Apartment Building at 13760, 70, 80, 90 13806 101A AVE. SURREY B.C. CLIENT:
Amarjeet Ubhi

DATE 29/01/2024

PROJECT NO: 22-238

SCALE:

DRAWN BY: 1" = 100'-0" A.R.C.

CONCEPTUAL 3D ILLUSTRATION



ARCHITECTURE S

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Ph: 604-503-4484

Apartment Building at 13760, 70, 80, 90 13806 101A AVE. SURREY B.C. CLIENT:
Amarjeet Ubhi

DATE 29/01/2024

PROJECT NO: 22-238

SCALE: 1" = 100'-0" DRAWN BY: A.R.C.

CONCEPTUAL 3D ILLUSTRATION



BLDG. 2

ARCHITECTURE S

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Ph: 604-503-4484

Apartment Building at 13760, 70, 80, 90 13806 101A AVE. SURREY B.C. CLIENT:
Amarjeet Ubhi

DATE 29/01/2024

PROJECT NO: 22-238

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CONCEPTUAL 3D ILLUSTRATION



BLDG. 1

ARCHITECTURE S

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Ph: 604-503-4484

Apartment Building at 13760, 70, 80, 90 13806 101A AVE. SURREY B.C. CLIENT:
Amarjeet Ubhi

DATE 29/01/2024

PROJECT NO: 22-238

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CONCEPTUAL 3D ILLUSTRATION



BLDG. 1

ARCHITECTURE S Unit 209-6321 King George Blvd Surrey BC, V3X 1G1 www.flatarchitecture.ca contact@flatarchitecture.ca Ph: 604-503-4484

Apartment Building at 13760, 70, 80, 90 13806 101A AVE. SURREY B.C. CLIENT:
Amarjeet Ubhi

DATE 29/01/2024

PROJECT NO: 22-238

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CONCEPTUAL 3D ILLUSTRATION



BLDG. 1

ARCHITECTURE [≦]

Unit 209-6321 King George Blvd Surrey BC, V3X 1G1 www.flatarchitecture.ca contact@flatarchitecture.ca

Ph: 604-503-4484

Apartment Building at 13760, 70, 80, 90 13806 101A AVE. SURREY B.C. CLIENT:
Amarjeet Ubhi

DATE 29/01/2024

PROJECT NO: 22-238

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CONCEPTUAL 3D ILLUSTRATION



ARCHITECTURE S

Unit 209-6321 King George Blvd Surrey BC, V3X 1G1 www.flatarchitecture.ca contact@flatarchitecture.ca

Ph: 604-503-4484

Apartment Building at 13760, 70, 80, 90 13806 101A AVE. SURREY B.C. CLIENT:
Amarjeet Ubhi

DATE 29/01/2024

PROJECT NO: 22-238

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CONCEPTUAL 3D ILLUSTRATION





BOLLARD LIGHT DARK SKY CERTIFIED

DARK SKY CERTIFIED



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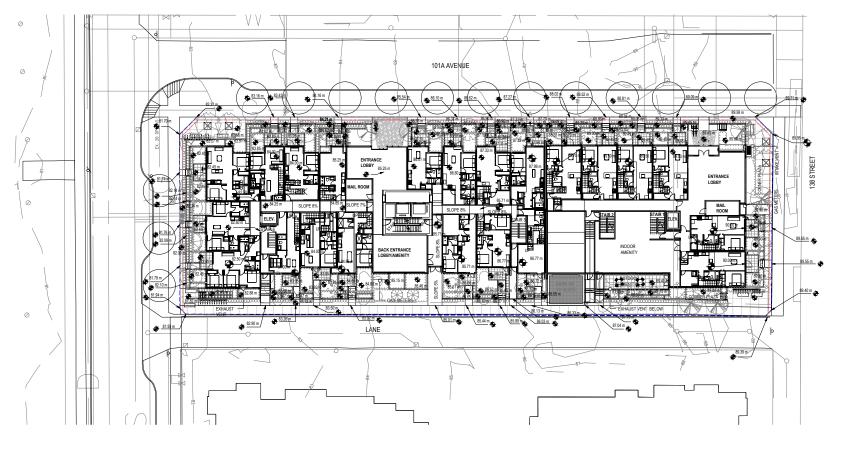
RESIDENTIAL/COMMERCIAL TOWER

13760/70/80 23860 101A AVENUE SURREY, BC

DRAWING TITLE:

LANDSCAPE PLAN

DATE: 23.JUL18 DRAWING NUMBER: SCALE: 1:200
DRAWN: RJ
DESIGN: RJ
CHKC): GG 0F.5



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SEA



PROJECT:

RESIDENTIAL/COMMERCIAL TOWER

13760/70/80 23860 101A AVENUE SURREY, BC


DRAWING TITLE

GRADING PLAN


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DESIGN: RJ
CHICD: CG



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LEVEL 23 LEVEL 7

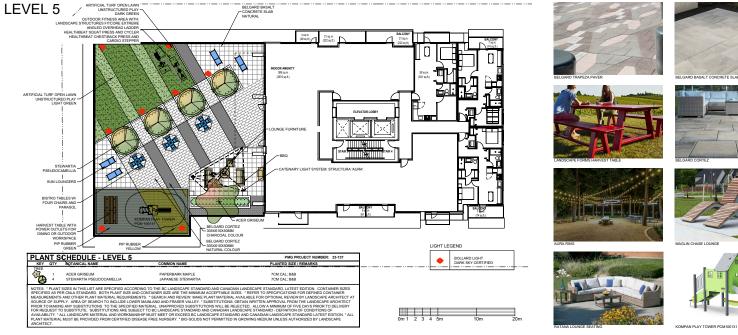

	SCHEDULE - LEVEL 7		PMG PROJECT NUMBER: 23-137
KEY QTY	BOTANICAL NAME	COMMON NAME	PLANTED SIZE / REMARKS
1	RHUS TYPHINA 'TIGER EYES'	CUTLEAF STAGHORN SUMAC	2M HT; B&B 3 STEM OR MORE
PECIFIED AS IEASUREMEN OURCE OF S RIOR TO MAN OR REQUEST VAILABILITY	PER CNLA STANDARD. BOTH PLANT SIZE. TS AND OTHER PLANT MATERIAL REQUIRE UPPLY. AREA OF SEARCH TO INCLUDE LO KING ANY SUBSTITUTIONS TO THE SPECIFI TO SUBSTITUTE. SUBSTITUTIONS ARE SI, "ALL LANDSCAPE MATERIAL AND WORKM.	AND CONTAINER SIZE ARE THE MINIMUM ACCEPTABLE SIZE MEMTS. "SEARCH AND REVIEW: MAKE PLANT MATERIAL AV WER MAINLAND AND FRASER VALLEY." SUBSTITUTIONS: OB IED MATERIAL. UNAPPROVED SUBSTITUTIONS WILL BE REJE BJECTT OB CLANDSCAPE STANDARD AND CANADIAN LAND	VAILABLE FOR OPTIONAL REVIEW BY LANDSCAPE ARCHITECT TIAIN WRITTEN APPROVAL FROM THE LANDSCAPE ARCHITECT CTED. ALLOW A MINIMUM OF FIVE DAYS PRIOR TO DELIVERY ISCAPE STANDARD. DEFINITION OF CONDITIONS OF A NID CANADIAN LANDSCAPE STANDARD LATEST EDITION. "A

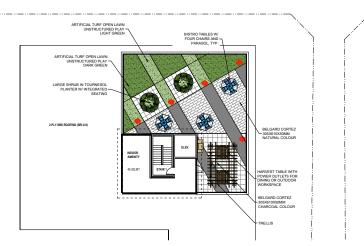UNSTRUCTURED PLAY LIGHT GREEN BELGARD CORTEZ 305X610X50MM -NATURAL COLOUR HARVEST TABLE WITH POWER OUTLETS FOR DINING OR OUTDOOR WORKSPACE

APTICION TUPE OPEN LAWN

305X610X50MM NATURAL COLOUR

COMMUNITY GARDEN

-RHUS TYPHINA 'TIGER EYES'

PLAN	T S	CHEDULE - LEVEL 2	3	PMG PROJECT NUMBER: 23-137
KEY	QTY	BOTANICAL NAME	COMMON NAME	PLANTED SIZE / REMARKS
TREE	4	RHUS TYPHINA 'TIGER EYES'	CUTLEAF STAGHORN SUMAC	2M HT; B&B 3 STEM OR MORE
SPECIFIED MEASURER SOURCE O PRIOR TO FOR REQU AVAILABIL	MENTS OF SUPI MAKINI IEST TO ITY. * A TERIAL	R CNLA STANDARD. BOTH PLANT SIZE. AND OTHER PLANT MATERIAL REQUIRE PLY. AREA OF SEARCH TO INCLUDE LO' G ANY SUBSTITUTIONS TO THE SPECIFI D SUBSTITUTE. SUBSTITUTIONS ARE SL LL LANDSCAPE MATERIAL AND WORKM.	WER MAINLAND AND FRASER VALLEY. "SUBSTITUTIONS: OBTAILED MATERIAL. UNAPPROVED SUBSTITUTIONS WILL BE REJECT TO BC LANDSCAPE STANDARD AND CANADIAN LANDS	* REFER TO SPECIFICATIONS FOR DEFINED CONTAINER ILLBLE FOR OPTIONAL REVIEW BY LANDSCAPE ARCHITECT AT AIM WRITTEN APPROVAL FROM THE LANDSCAPE ARCHITECT TED. ALLOW A MINIMIM OF FIVE DAYS PRIOR TO DELIVERY CAPE STANDARD - DEFINITION OF CONDITIONS OF MID CANDAIDM LANDSCAPE STANDARD LATEST EDITION. * ALL

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NEW SITE PLAN

PROJECT:

CLIENT:

RESIDENTIAL/COMMERCIAL TOWER

13760/70/80 23860 101A AVENUE SURREY, BC


ROOF TOP LANDSCAPE PLAN

DATE:	23.JUL.18	DRAWING NUMBER:
SCALE:	1:150	
DRAWN:	RJ	13
DESIGN:	RJ	
CHKD:	CG	OF 5

23137-3.ZIP PMG PROJECT NUMBER:

23-137



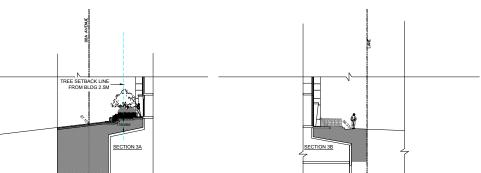

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24.APR.04	NEW SITE PLAN	RJ
24.MAR.04	NEW SITE PLAN	RJ
24.JAN.23	NEW SITE PLAN	RJ/W
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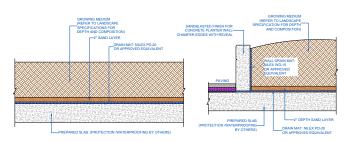
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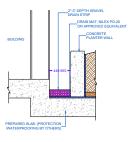
13760/70/80 23860 101A AVENUE SURREY, BC

DRAWING TITLE:

LANDSCAPE SECTIONS

DATE:	23.JUL.18	DRAWING NUMBER:
SCALE:	1:150	
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DESIGN:	RJ	
CHKD:	CG	OF 5







1.5" DEPTH BIRD'S EYE PEA GRAVE
DRAIN MAT: NILEX PD-20
FOR APPROVED EQUIVALENT

2 PLANTER WALL ON SLAB

3 DRAIN ROCK STRIP AT BUILDING ON SLAB

PAVERS OVER SLAB

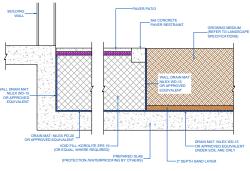

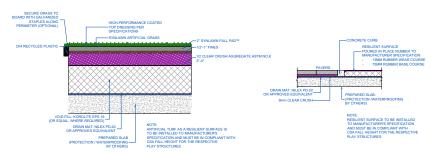



5 PATIO/LANDSCAPE AT SLAB DROP

PLANTING ON SLAB


6 ARTIFICIAL TURF ON SLAB

7 POURED PLAY SURFACE EDGE

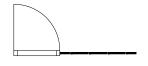


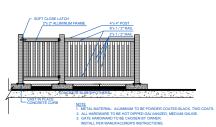

ALUMINUM PICKET FENCE ON SLAB

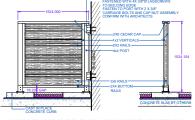

PATIO SCREEN ON SLAB

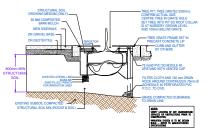

(10) STRUCTURAL SOIL, TREE GRATE

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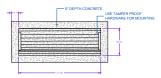
RESIDENTIAL/COMMERCIAL TOWER

13760/70/80 23860 101A AVENUE SURREY, BC


DRAWING TITLE:

LANDSCAPE DETAILS


DATE:	23.JUL.18	DRAWING NUMBER:
SCALE:	AS SHOWN	
DRAWN:	RJ	15
DESIGN:	RJ	
CHKD:	CG	OF 5




1 BENCH ON CONCRETE PAD

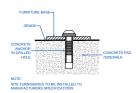


2 SITE FURNITURE MOUNTING

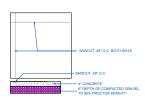

3 CONCRETE SAW CUTS

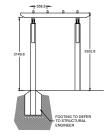

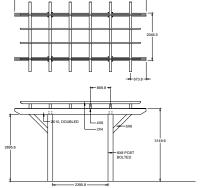

- NOTES:

 1. ALL WOOD TO BE CEDAR SES.

 2. SIAN TO MATCH ACCHITICATE. TWO COATS PREMIUM WEST INERPROOF AND STAM.

 2. SIAN TO MATCH ACCHITICATE WOMES PROVIDE COLOUR SAMME TO COMERT.

 3. COACRETE POOTING TO BE REVIEWED AND APPROVED BY STRUCTURAL ENGINEER PRIOR TO COASTRUCTURAL

 4. ALL MEROWARE CALVANUZED STANLESS.

 5. PROVIDE SIPPO PRIAMINES

4 STRUCTURAL SOIL, TREE GRATE

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Suite C100 - 4185 Still Creek Drive Burnaby, British Columbia, V5C 6G9 p: 604 294-0011 ; f: 604 294-0022

4 24.APR.04	NEW SITE PLAN	RJ
4 24.APR.04 3 24.MAR.04	NEW SITE PLAN NEW SITE PLAN	RJ RJ
		RJ
3 24.MAR.04	NEW SITE PLAN	

PROJECT:

CLIENT:

RESIDENTIAL/COMMERCIAL TOWER

13760/70/80 23860 101A AVENUE SURREY, BC

DRAWING TITLE:

LANDSCAPE DETAILS

ATE:	23.JUL.18	DRAWING NUMBER:
CALE:	AS SHOWN	
RAWN:	RJ	L6
ESIGN:	RJ	
HKD:	CG	OF 5



INTER-OFFICE MEMO

TO: Director, Area Planning & Development

- North Surrey Division

Planning and Development Department

FROM: Manager, Development Services, Engineering Department

DATE: April 16, 2024 PROJECT FILE: 7822-0085-00

RE: Engineering Requirements
Location: 13760 101A Ave

NCP AMENDMENT/ OCP AMENDMENT

There are no engineering requirements relative to the OCP Amendment.

The following issues are to be addressed as a condition of the NCP Amendment:

The applicant is required to complete a sanitary sewer capacity analysis downstream of the subject application due to the proposed land use plan amendment which will result in increased population and subsequent sanitary demand. The applicant will be required to resolve any downstream pipe capacity constraints.

REZONE/SUBDIVISION

Property and Right-of-Way Requirements

- Dedicate 5.00 m along 138 Street;
- Dedicate 2.322 m along 137A Street;
- Dedicate 1.0 m x 1.0 m corner cut at 137A Street and E-W lane;
- Dedicate 1.0 m x 1.0 m corner cut at 138 Street and E-W lane;
- Dedicate 3.0 m x 3.0 m corner cut at 101A Avenue and 137A Street;
- Dedicate 3.0 m x 3.0 m corner cut at 101A Avenue and 138 Street; and
- Register 0.5 m statutory right-of-way along 137A Street, 138 Street, and 101A Avenue.

Works and Services

- Construct all road and lane frontages;
- Construct proposed driveway access;
- Construct an adequately-sized service connections (drainage, water and sanitary), complete with inspection chambers and water meter, to service the site;
- Construct/upgrade fronting mains as required to service the proposed development;
- Construct on-lot stormwater mitigation features;
- Provide stormwater control plan and resolve any downstream constraints; and
- Register legal documents as applicable.

A Servicing Agreement is required prior to Rezone/Subdivision.

DEVELOPMENT PERMIT/DEVELOPMENT VARIANCE PERMIT

There are no engineering requirements relative to issuance of the Development Permit.

Janelle Frank, P.Eng.

Development Review Manager

M51



Department: Planning and Demographics
Date: April 10, 2024

Report For: April 10, 2024

City of Surrey

Development Impact Analysis on Schools For:

Application #: 22-0085

The proposed development of 259 High Rise Apartment units and Low Rise Apartment units are estimated to have the following impact on elementary and secondary schools within the school regions.

School-aged children population projection 31

Projected Number of Students From This Development In:		
Elementary School =	18	
Secondary School =	8	
Total Students =	26	

Current Enrolment and Capacities:		
Lena Shaw Elementary		
Enrolment	664	
Operating Capacity	569	
# of Portables	5	
Guildford Park Secondary		
Enrolment	1390	
Operating Capacity	1050	
# of Portables	11	

Summary of Impact and Commentary


The following tables illustrate the historical, current and future enrolment projections including current/approved ministry operating capacity for the elementary and secondary schools serving the proposed development.

Signficant redevelopment in this neighbourhood is expected with the approval of Skytrain and Transit Oriented Development. The timing of these future developments could impact the enrolment growth upwards even more from the projections below.

Lena Shaw operates at or slightly above the school's capacity. Post 2023, the projected growth trend begins to get stronger finishing at end of the decade to around 830 students. In anticipation of further growth associated with the proposed transit oriented housing mentioned above, the Ministry approved in November 2023 the installation of 8 modulars to open in September 2024 tentatively. Additional projects to relieve capacity have been requested, but are as of yet


Guildford Park Secondary is currently operating at 132% and is projected to minimally grow. This school will be impacted by development along the Guildford 104th Ave Corridor when that NCP has been adopted. The impact of this plan will not be included in this projection until the plan has been approved. In May 2023, the District received capital funding approval from the Ministry to build a 450-capacity addition, targeted to open in the spring of 2028.



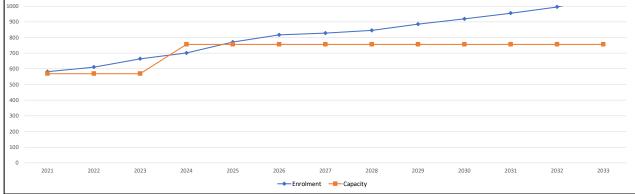

Note: If this report is provided in the months of October, November and December, the 10-year projections are out of date and they will be updated in January of next year.

Guildford Park Secondary

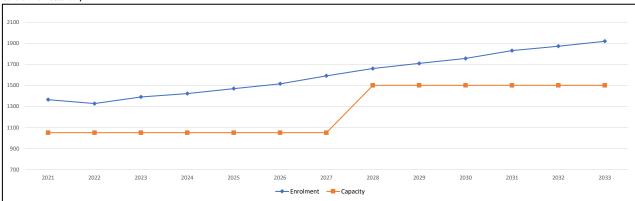

Note: If this report is provided in the months of October, November and December, the 10-year projections are out of date and they will be updated in January of next year.

Population: The projected population of children aged 0-17 Impacted by the development. **Enrolment:** The number of students projected to attend the Surrey School District ONLY.

MIKE FADUM AND ASSOCIATES LTD. VEGETATION CONSULTANTS

Tree Preservation Summary

Surrey Project No: TBD

Address: 13760 13770, 13780, 13790, 13806 101A Avenue Surrey, BC

Registered Arborist: Corey Plester #PN-8523A


On-Site Trees	Number of Trees
Protected Trees Identified (on site and shared trees, including trees within boulevards and proposed streets	27
(on-site and shared trees, including trees within boulevards and proposed streets and lanes, but excluding trees in proposed open space or riparian areas)	27
Protected Trees to be Removed	27
Protected Trees to be Retained (excluding trees within proposed open space or riparian areas)	0
- Alder & Cottonwood Trees Requiring 1 to 1 Replacement Ratio 0 X one (1) = 0 - All other Trees Requiring 2 to 1 Replacement Ratio 27 X two (2) = 54	54
Replacement Trees Proposed	44
Replacement Trees in Deficit	10
Protected Trees to be Retained in Proposed [Open Space / Riparian Areas]	NA


Off-Site Trees	Number of Trees
Protected Off-Site Trees to be Removed	0
Total Replacement Trees Required:	
 Alder & Cottonwood Trees Requiring 1 to 1 Replacement Ratio 0 X one (1) = 0 	0
- All other Trees Requiring 2 to 1 Replacement Ratio	
0 X two (2) = 0	
Replacement Trees Proposed	NA
Replacement Trees in Deficit	NA


Summary report and plan prepared and submitted by: Mike Fadum and Associates Ltd.		
Signature of Arborist:	Date: April 15, 2024	





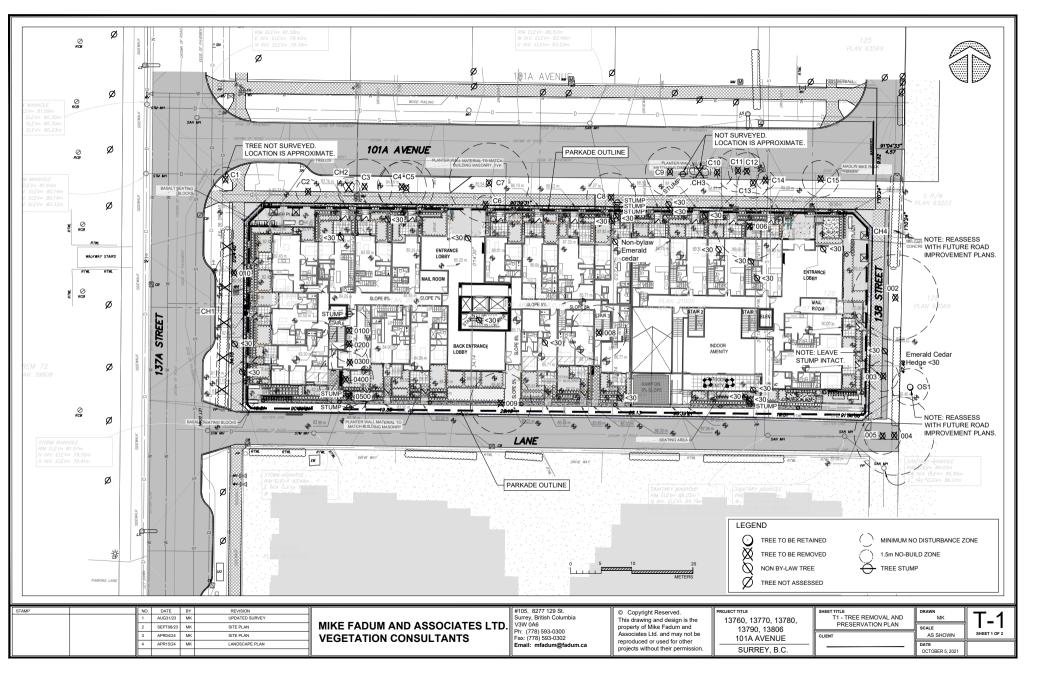

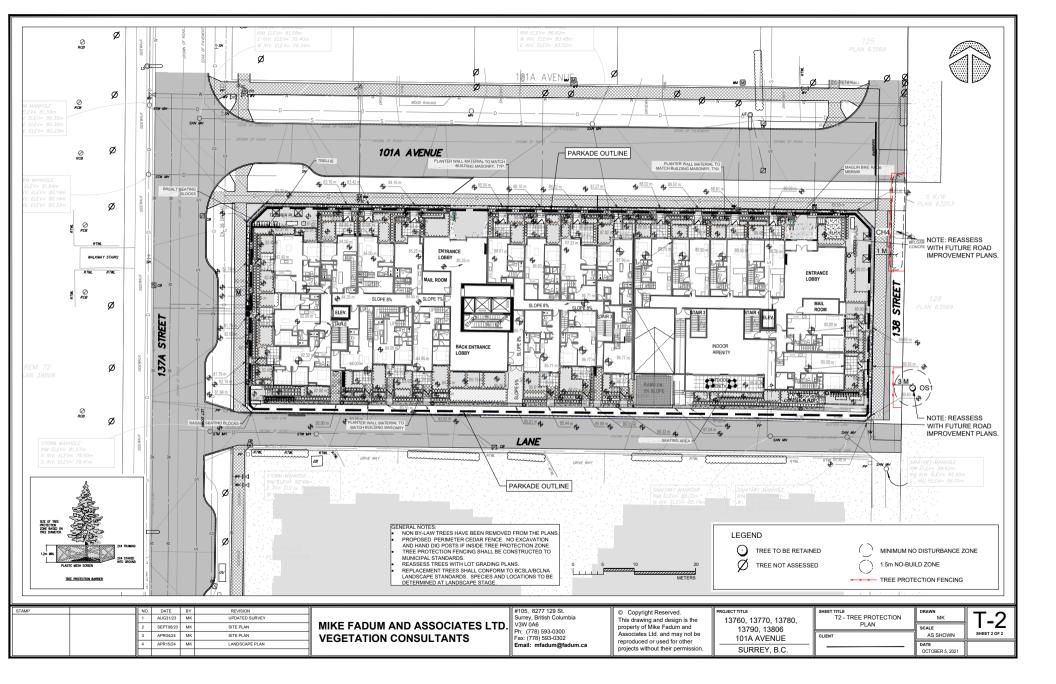

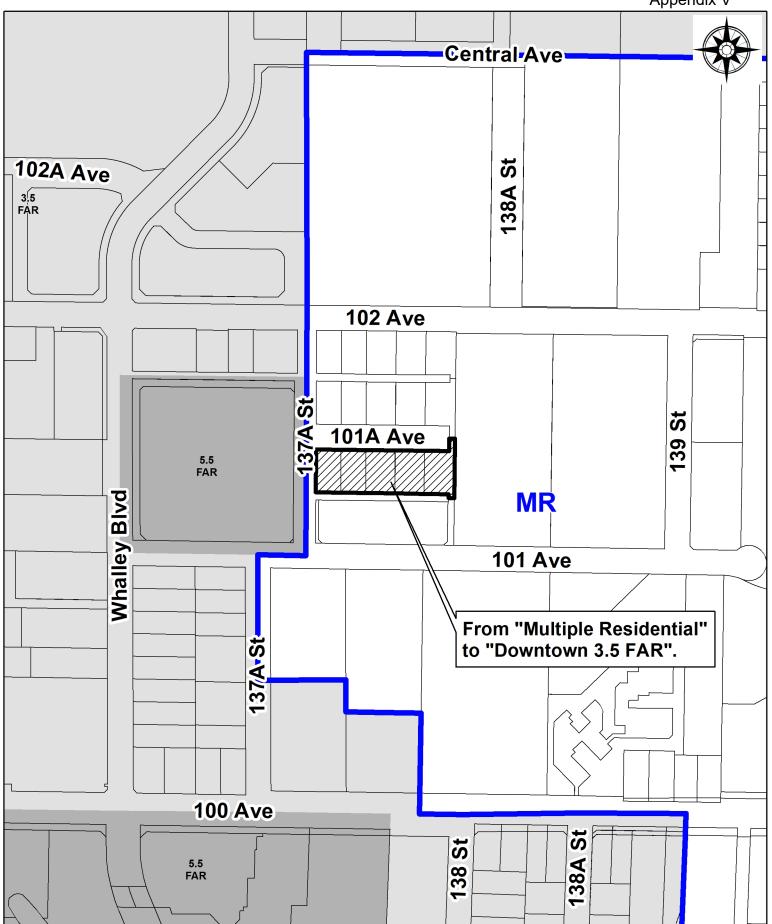




OCP Amendment 22-0085-00

Figure 3 From "Multiple Residential" to "Downtown 3.5 FAR".



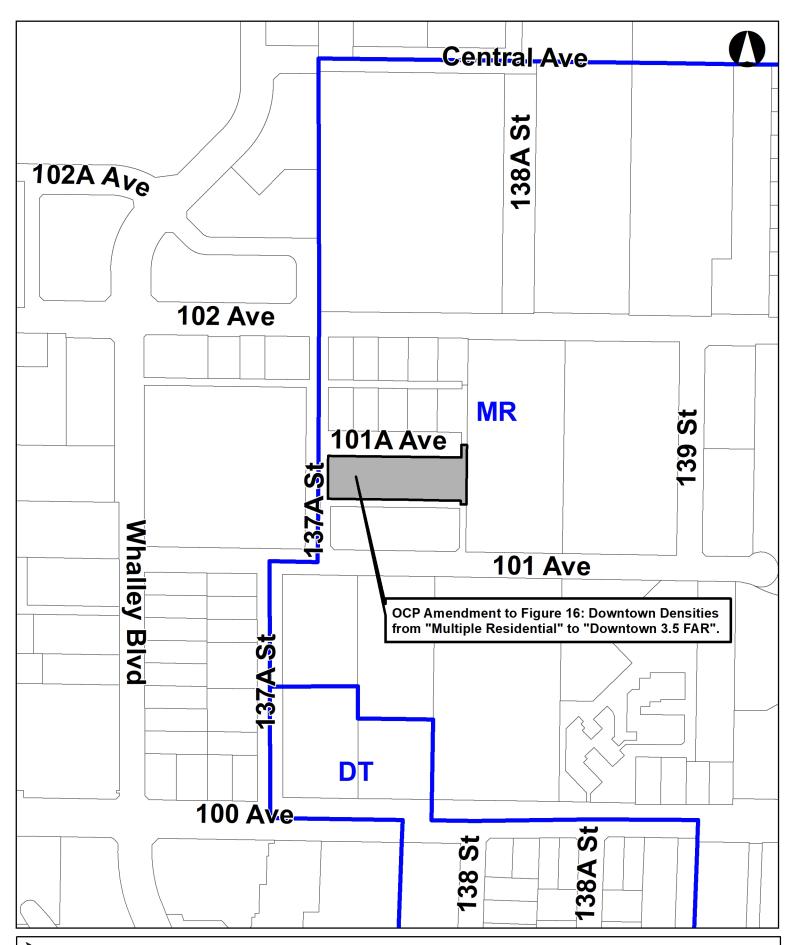



OCP Amendment 22-0085-00

OCP Amendment to Figure 16: Downtown Densities from "Multiple Residential" to "Downtown 3.5 FAR".



CITY OF SURREY

HOUSING AGREEMENT (Residential Only)

THIS	HOUSING AGREEMENT made the day of, 2024.
BETW	EEN:
	CITY OF SURREY , a municipal corporation having its offices at 13450 – 104 Avenue, Surrey B.C. V3T 1V8
	(the "City")
	OF THE FIRST PART
AND:	
	DEER LAKE HOMES LTD., INC.NO. BC0992289 , a corporation having its offices at 7875 118 Street, Delta B.C. V4C 6G9
	(the "Owner")
	OF THE SECOND PART
WHEI	REAS:
A.	The Owner is the legal and beneficial owner of those certain lands and premises located in the City of Surrey, in the Province of British Columbia, legally described as:
	Parcel Identifier: 010-130-705 Legal Description: Lot 25 Section 26 Block 5 North Range 2 West New Westminster District Plan 20979
	Parcel Identifier: 010-130-713 Legal Description: Lot 26 Section 26 Block 5 North Range 2 West New Westminster District Plan 20979
	Parcel Identifier: 010-169-083 Legal Description: Lot 39 Section 26 Block 5 North Range 2 West New Westminster District Plan 21005
	Parcel Identifier: 010-169-130 Legal Description: Lot 40 Section 26 Block 5 North Range 2 West New Westminster District Plan 21005
	Parcel Identifier: 003-335-950 Legal Description: Lot 126 Section 26 Block 5 North Range 2 West New Westminster District Plan 63569
	(collectively, the "Lands");

- B. The Owner wishes to develop a residential development on the Lands consisting of a market condominium component (the "Market Strata Component") and a rental component consisting of market rental units (the "Market Rental Component") as depicted in Schedule "A" attached hereto;
- C. Upon completion of the construction, the Owner intends to deposit an airspace subdivision plan (the "Subdivision Plan") under the Land Title Act in the Land Title Office subdividing the Market Strata Component and the Market Rental Component (the "Market Rental Development" into separate parcels; and
- D. The Owner has voluntarily agreed to enter into a housing agreement pursuant to Section 483 of the *Local Government Act*, R.S.B.C. 2015, Chapter 1, as amended, to ensure that the Rental Units are rented in accordance with this Agreement.

NOW THEREFORE in consideration of the premises herein and of the mutual covenants and agreements hereinafter set forth and contained herein and \$1.00 now paid by the City to the Owner (the receipt of which is hereby acknowledged), the parties hereto covenant and agree each with the other as follows:

1. **DEFINED TERMS**

- 1.1 In and for the purpose of this Agreement, in addition to the definitions on the first page of this document, the following terms shall have the following meanings:
 - (a) "Agreement" means this housing agreement and any amendments to or modifications of the same;
 - (b) "City" means the City of Surrey and any person authorized by the City of Surrey, including assigns of whole or partial interest in this Agreement or of any of the rights conferred upon the City of Surrey by this Agreement;
 - (c) "City Personnel" means all of the City's elected and appointed officials, officers, employees, agents, nominees, delegates, permittees, contractors, subcontractors, invitees and the Approving Officer;
 - (d) "Claims and Expenses" means all actions, causes of actions, suits, judgments, proceedings, demands, and claims, whether at law or in equity, losses, damages, expenses and costs (including legal fees and disbursements on an indemnity basis) of any kind or nature whatsoever, at law or in equity, for any damages, losses, injuries or death;
 - (e) "Lands" means the parcel of land situated in the City of Surrey, British Columbia and legally described in Recital A, and includes any parcel into which such land is consolidated or further subdivided (including a subdivision pursuant to the Land Title Act;
 - (f) "Market Rental Development" means as defined in Recital C;
 - (g) "Owner" means the person named on the first page of this Agreement and the legal and beneficial owner at any given time and any successors in title of the Lands:

- (h) "Rental Units" means 58 dwelling units within the Market Rental Development, which must be made available by the Owner to the general public at arms' length for use as residential rental accommodation on a month-to-month or longer basis in accordance with all applicable laws including, without limitation, the *Residential Tenancy Act*, S.B.C. 2002, Chapter 78, as amended, and any regulations pursuant thereto; and
- (i) "**Term**" means 40 years, commencing on the first day of the month after the City issues an occupancy permit for the Market Rental Development.

2. RESTRICTION ON OCCUPANCY OF DWELLING UNITS

- 2.1 During the Term the Rental Units must be made available for rent in accordance with this Agreement.
- 2.2 The City may, from time to time, during the Term request the Owner to provide written proof of compliance with section 2.1 and the Owner agrees to provide, or cause an operator of the Lands to provide, the City with such proof in a form reasonably satisfactory to the City.
- 2.3 All of the Rental Units must be owned by the same Owner(s).
- 2.4 Throughout the Term, the Owner shall not sell or transfer the beneficial or registered title or any interest in and to the Rental Units, unless the Owner obtains from the transferee an agreement in writing from the transferee to assume and perform all of the obligations of the Owner arising under this Agreement.
- 2.5 The Owner may sell or transfer the Rental Units individually or together but will not sell one of more Rental Units separately in a single or related series of transactions with the result that when the purchaser or transferee of the Rental Units becomes the owner, the purchaser or transferee will be the legal and beneficial owner of less than all of the Rental Units. For the avoidance of doubt, any purchaser or transferee must be the legal and beneficial owner of all of the Rental Units.

3. LIABILITY

- 3.1 The Owner shall indemnify and save harmless the City and City Personnel from all Claims and Expenses which the City and City Personnel may suffer, or incur, or be put to, arising out of or in connection with any breach or default of any covenants or agreements on the part of the Owner contained in this Agreement, or arising out of, or in connection with the Market Rental Development or arising out of the fact that the Lands are encumbered by and affected by this Agreement.
- 3.2 The Owner does hereby remise, release and forever discharge the City and City Personnel from all Claims and Expenses which the Owner may have against the City and City Personnel, which the Owner now has or hereafter may have with respect to or by reasons of or arising out of the fact that the Lands are encumbered by and affected by this Agreement.
- 3.3 The Owner covenants and agrees that the indemnity and release in Sections 3.1 and 3.2 will remain effective and survive the expiration or termination of this Agreement whether by fulfilment of the covenants contained in this Agreement or otherwise.

4. NOTICE

- 4.1 Any notices or other documents to be given or delivered pursuant to this Agreement will be addressed to the proper party as follows:
 - (a) As to the City:

City of Surrey 13450 – 104 Avenue Surrey, BC V3T 1V8

Attention: General Manager, Planning and Development Department

(b) As to the Owner:

Amarjeet Singh Ubhi and Harkurn Singh Ubhi 7875 118 Street, Delta B.C. V4C 6G9

or such other address as such party may direct. Any notice or other documents to be given or delivered pursuant to this Agreement will be sufficiently given or delivered if delivered to the particular party as its address set out or determined in accordance with this section and shall be deemed complete two (2) days after the day of delivery.

4.2 It is specifically agreed that for any notice or document to be validly given or delivered pursuant to this Agreement, such notice or document must be delivered and not mailed.

5. **GENERAL**

- 5.1 Where the Owner consists of more than one person, each such person will be jointly and severally liable to perform the Owner's obligations under this Agreement.
- This Agreement or any of the rights conferred by this Agreement upon the City may be assigned in whole or in part by the City without the consent of the Owner.
- 5.3 Nothing contained or implied herein will derogate from the obligations of the Owner under any other agreement with the City or, if the City so elects, prejudice or affect the City's rights, powers, duties or obligations in the exercise of its functions pursuant to the *Local Government Act* and the *Community Charter*, as amended from time to time and the rights, powers, duties and obligations of the City under all public and private statutes, by-laws, orders and regulations, which may be, if the City so elects, as fully and effectively exercised in relation to the Lands as if this Agreement had not been executed and delivered by the Owner and the City.
- 5.4 The Owner and the City hereby acknowledge, agree and declare that this Agreement is entered into for the sole purpose of benefitting the City and, in particular, acknowledge, agree and declare that this Agreement is not designed to protect or promote the interests of the Owner or any mortgagee of the Owner, or any future owner or occupier of the Lands and any improvements on the Lands or any other person and the City may, at its sole option, execute a release of this Agreement at any time without liability to any person for so doing.
- 5.5 The Owner acknowledges and agrees that no failure on the part of the City to exercise and no delay in exercising any right under this Agreement will operate as a waiver thereof, nor will any single or partial exercise by the City of any right under this Agreement

- preclude any other or future exercise thereof of the exercise of any other right.
- 5.6 The Owner agrees that the City is not required or is under no obligation in law or equity to prosecute or enforce this Agreement in any way whatsoever.
- 5.7 The remedies provided for in this Agreement will be cumulative and not exclusive of any other remedies provided by law or in equity. In addition to any remedies which are available under this Agreement or at law, the City will be entitled to all equitable remedies, including, without limitation, specific performance, injunction and declaratory relief, or any combination thereof, to enforce its rights under this Agreement. The Owner acknowledges that specific performance, injunctive relief (mandatory or otherwise) or other equitable relief may be the only adequate remedy for a default by the Owner under this Agreement.
- 5.8 All the obligations and covenants in this Agreement are severable, so that if any one or more of the obligations or covenants are declared by a court of competent jurisdiction to be void and unenforceable, the balance of the obligations and covenants will remain and be binding.
- 5.9 In an action to enforce this Agreement in respect of which the court determines that the position of the City will prevail, the City will be entitled to court costs on a solicitor-client basis.
- 5.10 This Agreement shall enure to the benefit of and be binding upon the parties hereto and their personal representatives, respective heirs, executors, administrators, successors, and assigns.
- 5.11 This Agreement will be governed by and construed in accordance with the laws of the Province of British Columbia and the laws of Canada applicable in British Columbia.
- 5.12 The Owner shall at the sole expense of the Owner, do or cause to be done all acts reasonably necessary to grant priority to this Agreement over all charges and encumbrances which may have been registered against the title to the Lands at the Land Title Office save and except those specifically approved in writing by the City.
- 5.13 The Owner shall do, or cause to be done, all things and execute or cause to be executed all documents and give such further and other assurances which may be reasonably necessary to give proper effect to the intent of this Agreement.
- 5.14 Agreement may be executed in any number of counterparts and delivered via facsimile or e-mail, each of which will be deemed to be an original and all of which taken together will be deemed to constitute one and the same instrument, provided that any party delivering this Agreement via facsimile or e-mail will deliver to the other party any originally executed copy of this Agreement forthwith upon request by the other party.
- 5.15 This Agreement represents the entire agreement between the City and the Owner regarding the matters set out in this Agreement and supersedes all prior agreements, letters of intent or understandings about these matters.

IN WITNESS WHEREOF the City of Surrey and the Owner have executed this Agreement under seal of their duly authorized officers as of the references of this Agreement.


[Remainder of page left intentionally blank; execution page follows]

CITY OF SURREY

By:	
·	Authorized Signatory
	Brenda Locke,
	Mayor
	City of Surrey
By:	
Бу.	Authorized Signatory
	Jennifer Ficocelli,
	City Clerk
	City of Surrey
DEE I	R LAKE HOMES LTD.
By:	
	Authorized Signatory
	Name:
	Title:

SCHEDULE "A"

See attached.

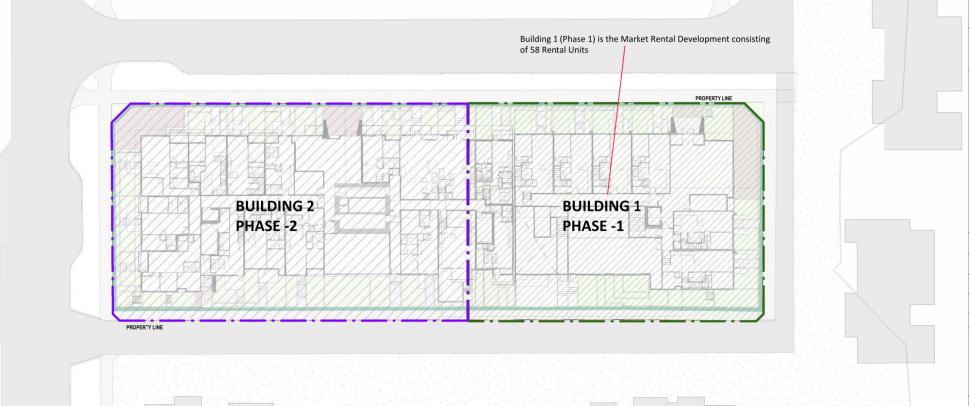

Unit 209- 6321 King George Blvd Surrey BC, V3X 1G1 www.flatarchitecture.ca contact@flatarchitecture.ca

Ph: 604-503-4484

PROJECT INFO:
Apartment Building at 13760, 70, 80, 90 13806 101A AVE. SURREY B.C. CLIENT:
Amarjeet Ubhi

DATE 29/01/2024

PROJECT NO: 22-238

SCALE: 1/32" = 1'-0"

PHASING PLAN

A 108

PHASING PLAN SCALE: 1/32" = 1'-0"



DISTRICT ENERGY SERVICE AREA (SERVICE AREA A & SERVICE AREA B)

ENGINEERING DEPARTMENT